

NOTES:

1. OWNER: REESE ASSOCIATES, LLC 14 ROCKFORD CROSSING

2. TAX PARCEL NO.: 07-00-12.000-01-10.01 07-00-12.000-01-11.00 3. SOURCE OF TITLE: DEED BOOK 12501, PAGE 186

DEED BOOK 12501, PAGE 186 4. AREA: 1.30± ACRES 3.27± ACRES

5. ADDRESS: SOUTH DUPONT HWY 8093 SOUTH DUPONT HWY FELTON, DE 19943 FELTON, DE 19943

DOVER, DE 19901

6. PROPOSED USE: 48 RESIDENTIAL APARTMENTS

HORIZONTAL — DELAWARE STATE PLANE, NAD 83 VERTICAL — NORTH AMERICA VERTICAL DATUM NAVD 1988 DERIVED FROM 7. DATUM: GPS OBSERVATIONS.


8. SITE BENCHMARK: SQUARE BOX CUT ON TOP OF CONCRETE CURB AT CRESTWOOD DRIVE ELEVATION = 54.16

9. WATER: TIDEWATER UTILITIES, INC. WATER SUPPLY IS SUBJECT TO THE APPROVAL OF THE DELAWARE STATE DEPARTMENT OF NATURAL RESOURCES AND ENVIRONMENTAL CONTROL AND THE DELAWARE DEPARTMENT OF PUBLIC HEALTH.

10. SEWER: KENT COUNTY PUBLIC WORKS

SANITARY FORCE MAIN END STA: 29+64

11. PROPERTY LINES SHOWN HEREON WERE DERIVED FROM TAX MAPS, SITE FEATURES, AND FIELD

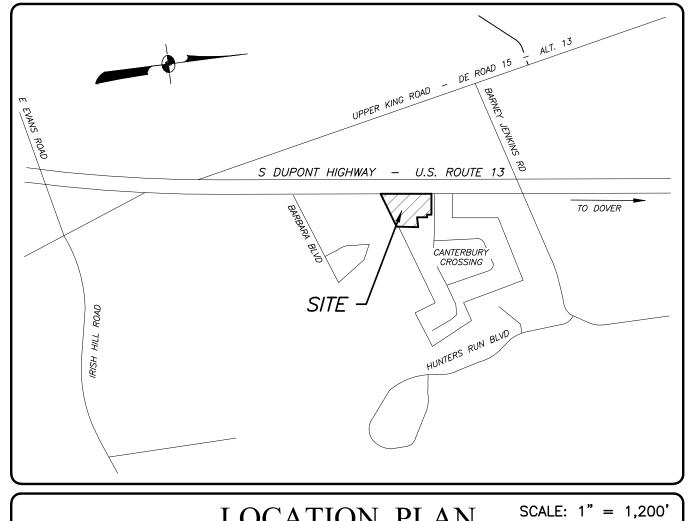

LOCATION PLAN

THE PURPOSE OF THIS PLAN IS TO:

CONSTRUCT 265 L.F. OF PRIVATE 2" SANITARY SEWER FORCE MAIN, 276 L.F. OF PRIVATE 8" GRAVITY SANITARY SEWER, 1,352 L.F. OF PUBLIC 2" SANITARY SEWER FORCE MAIN, 1,333 L.F. OF PUBLIC 3" SANITARY AND A PRIVATE PUMP STATION TO SERVICE PROPOSED APARTMENTS.

SHEET NO. SHEET TITLE

CP1.01

INDEX PLAN, GENERAL DATA AND PROJECT INFORMATION

CP1.02-CP1.04 SANITARY SEWER FORCEMAIN PLAN AND PROFILE CP1.05 SANITARY SEWER GRAVITY PLAN

CP1.06 SANITARY SEWER PROFILES


CP1.07 PUMP STATION DETAILS SANITARY SEWER DETAILS AND NOTES


DRODGED /EVISTING ADDROVED INEDASTRICTURE EVALUATION

PROP	PROPOSED/EXISTING APPROVED INFRASTRUCTURE EVALUATION					
ITEM NO.	NAME / ENTITY	APPROVED/ PROPOSED EDU'S	EXISTING EDU'S	DIFFERENCE EDU'S	AVERAGE FLOW GPM (Q AVG)	COMMENTS
1	REESE APARTMENTS	48	0	48	8.3	BASED ON 250 GPD/EDU
2	CLUBHOUSE & RENTAL OFFICE	5	0	5	0.9	BASED ON 250 GPD/EDU
	TOTAL	53	0	53	9.2	

 $PF = \frac{20+2(EDU/10)^{\circ}0.5}{5+2(EDU/10)^{\circ}0.5} = \frac{24.60}{9.60} = 2.60$

Qp=(PF)(Qavg) Qp=(2.6)(9.2)=23.9 gpm (0.03 MGD)

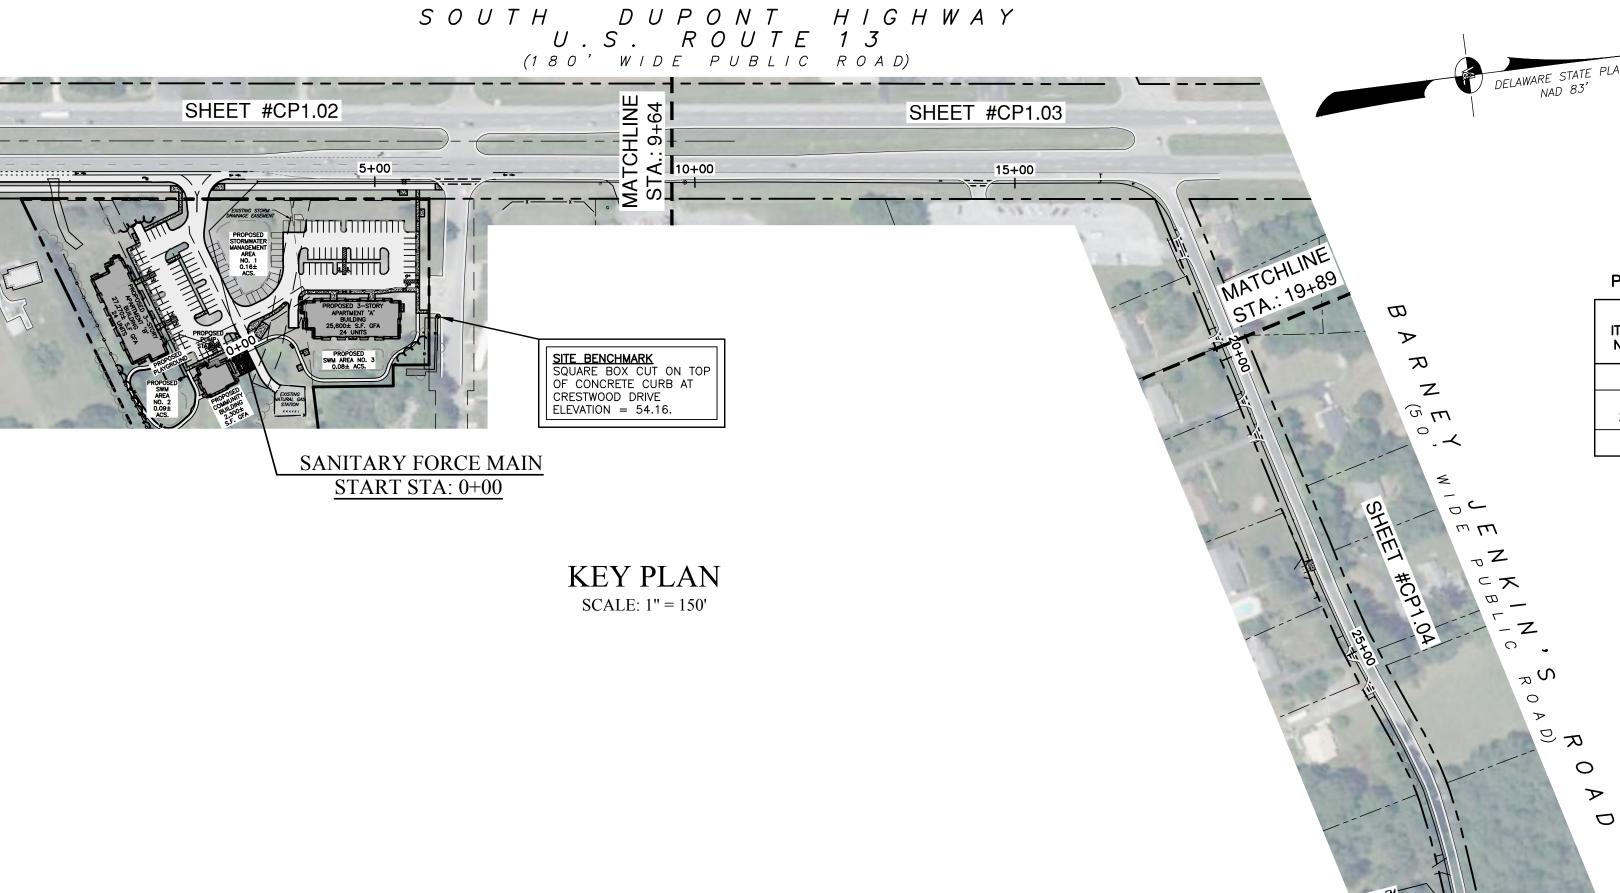

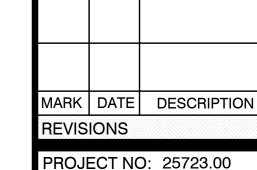

VANDEMARK

& LYNCH, INC.

NGINEERS - PLANNERS - SURVEYORS

ARCHITECTURAL

ARCHITECTURE • PLANNING INTERIOR DESIGN • GRAPHIC ARTS

DELAWARE

SUITE 22

SUITE 194

EXTON, PA 19341 610.640.9000

PROJECT NAME

8093 S. Dupont Hwy, Felton, DE 19943 Kent County

10.2.23

THE REESE APARTMENTS

PER KENT COUNTY PUBLIC WORKS

PER KENT COUNTY

PUBLIC WORKS

302.478.3777

1309 VEALE ROAD

WILMINGTON, DE 19810

PENNSYLVANIA 256 EAGLEVIEW BLVD

ALLIANCE

4305 MILLER ROAD

302.764.7635

WILMINGTON, DE 19802

DRAWN BY: DJS CHK'D BY: SHR DATE: 3/21/23

DRAWING NAME

SANITARY SEWER PLAN

INDEX PLAN

DRAWING NUMBER

KENT COUNTY CP1.01

SCALE: 1" = 150' SHEET 1 OF 10

EXISTING UTILITIES ARE SHOWN IN ACCORDANCE WITH THE BEST AVAILABLE INFORMATION. COMPLETENESS OR CORRECTNESS THEREOF IS NOT GUARANTEED. IT SHALL BE EACH CONTRACTORS' RESPONSIBILITY TO CONTACT THE UTILITY COMPANIES INVOLVED IN ORDER TO SECURE THE MOST ACCURATE INFORMATION AVAILABLE AS TO UTILITY LOCATION AND ELEVATION. NO CONSTRUCTION AROUND OR ADJACENT TO UTILITIES SHALL BEGIN WITHOUT NOTIFYING THEIR OWNERS AT LEAST 48 HOURS IN ADVANCE. EACH CONTRACTOR SHALL TAKE THE NECESSARY PRECAUTIONS TO PROTECT THE EXISTING UTILITIES. TO LOCATE EXISTING UTILITIES IN THE FIELD PRIOR TO CONSTRUCTION, THE CONTRACTOR SHALL CONTACT MISS UTILITY OF DELMARVA (TELEPHONE 800-282-8555).

THE FOLLOWING UTILITIES ARE IDENTIFIED BY MISS UTILITY (TICKET NO.S 223500265, 223500266, 223500274, 223500275, 223500276, 223500277, 223500278, 223500279) AS HAVING UNDERGROUND FACILITIES IN THE AREA OF THIS PROJECT


<u>DISTRICT</u> COMPANY NAME COMCAST/CABLE PROTECTION CUDE02 CHESAPEÁKE UTILITIES DELMARVA POWER/UTILIQUEST DPML11 ESNGKEN EASTERN SHORE NATURAL GAS KCDE01 KENT COUNTY PUBLIC WORKS P00R01 POORES PROPANE TIDE01 VKNTD TIDEWATER UTILITIES VERIZON




SANITARY SEWER DATA TABLE						
STREET NAME	TOTAL # OF MANHOLES	NOMINAL DIAMETER OF SANITARY SEWER PIPE	TOTAL LENGTH OF GRAVITY SANITARY SEWER PIPE	TOTAL LENGTH OF FORCEMAIN	PIPE MATERIAL	
ON-SITE	1	8"	396 L.F.		PVC SDR-26	
ON-SITE		2"		280 L.F.	HDPE DR-11	
SOUTH DUPONT HIGHWAY		2"		1,351 L.F.	HDPE DR-11	
BARNEY JENKIN'S ROAD		3"		1,333 L.F.	HDPE DR-11	
TOTAL	1		396 L.F.	2,964 L.F.		


INDEX PLAN SANITARY SEWER PLAN REESE APARTMENTS 8093 SOUTH DUPONT HIGHWAY

NORTH MURDERKILL HUNDRED DELAWARE

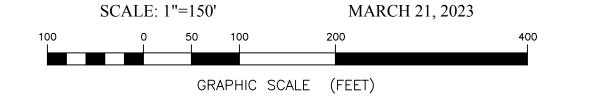

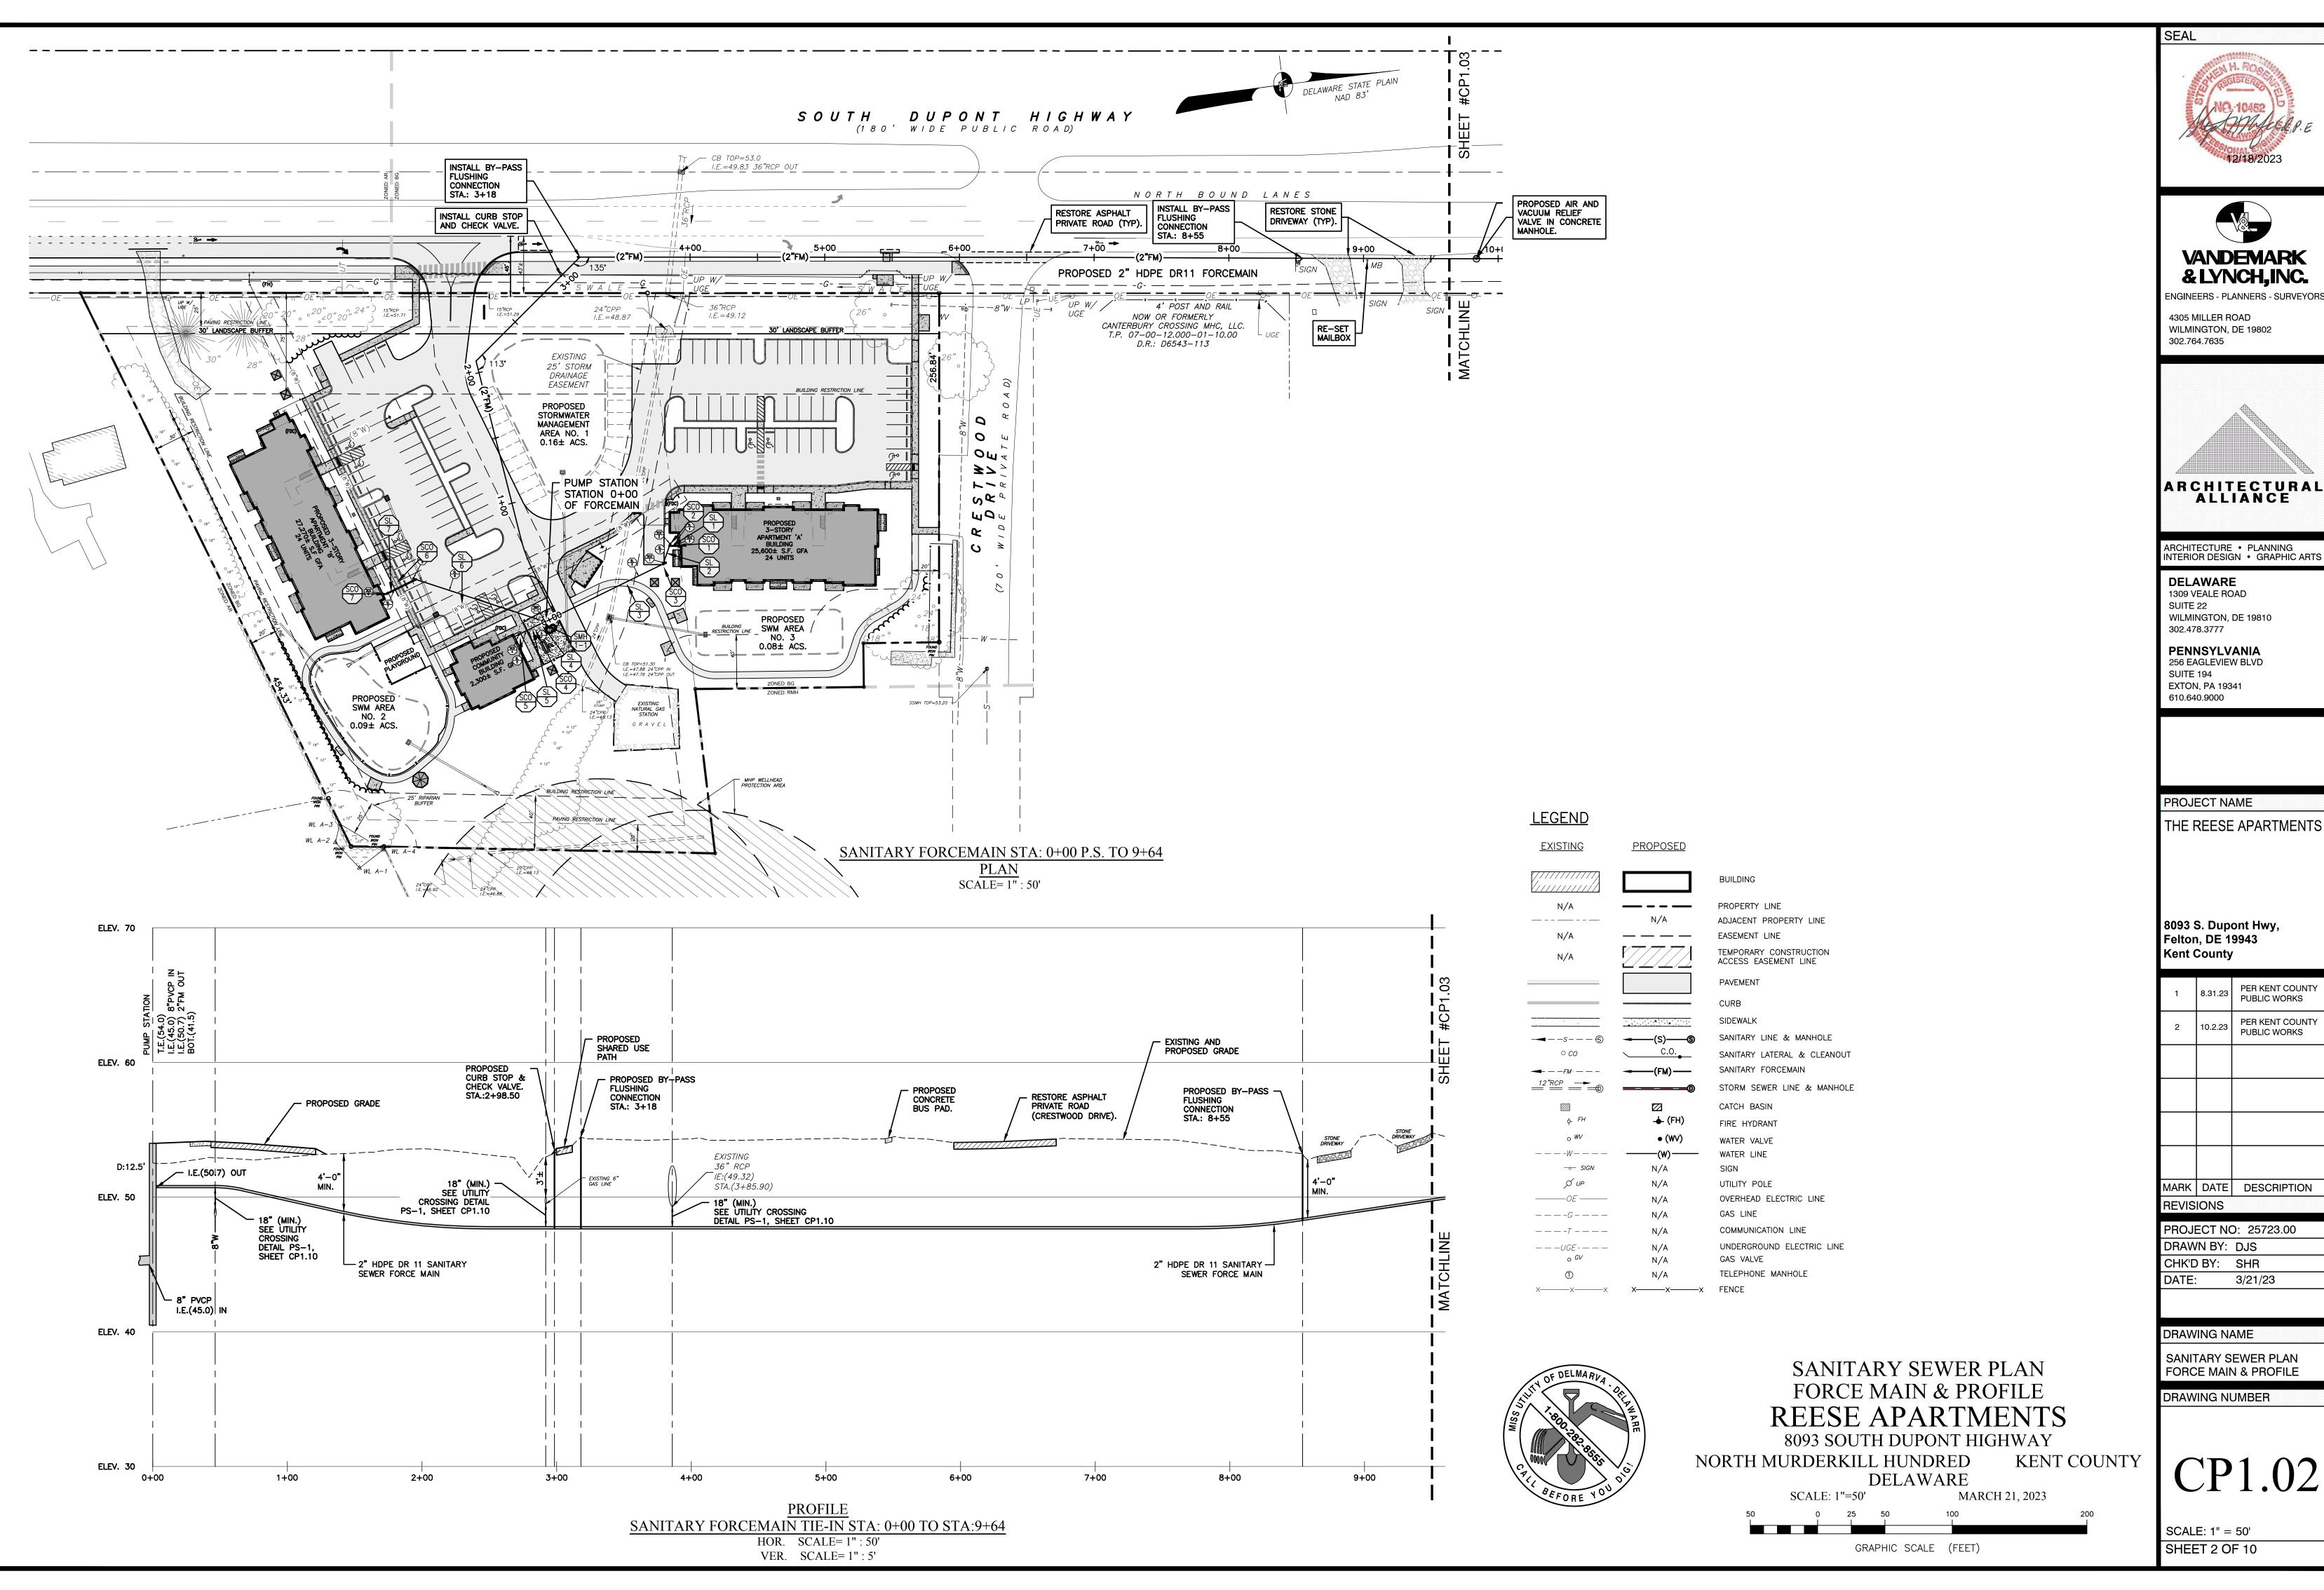



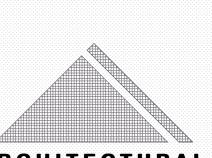



ARCHITECTURAL ALLIANCE

		PUBLIC WORKS
2	10.2.23	PER KENT COUNTY PUBLIC WORKS
1 DIZ		DECODIBION

MARK DATE DESCRIPTION


CP1.02

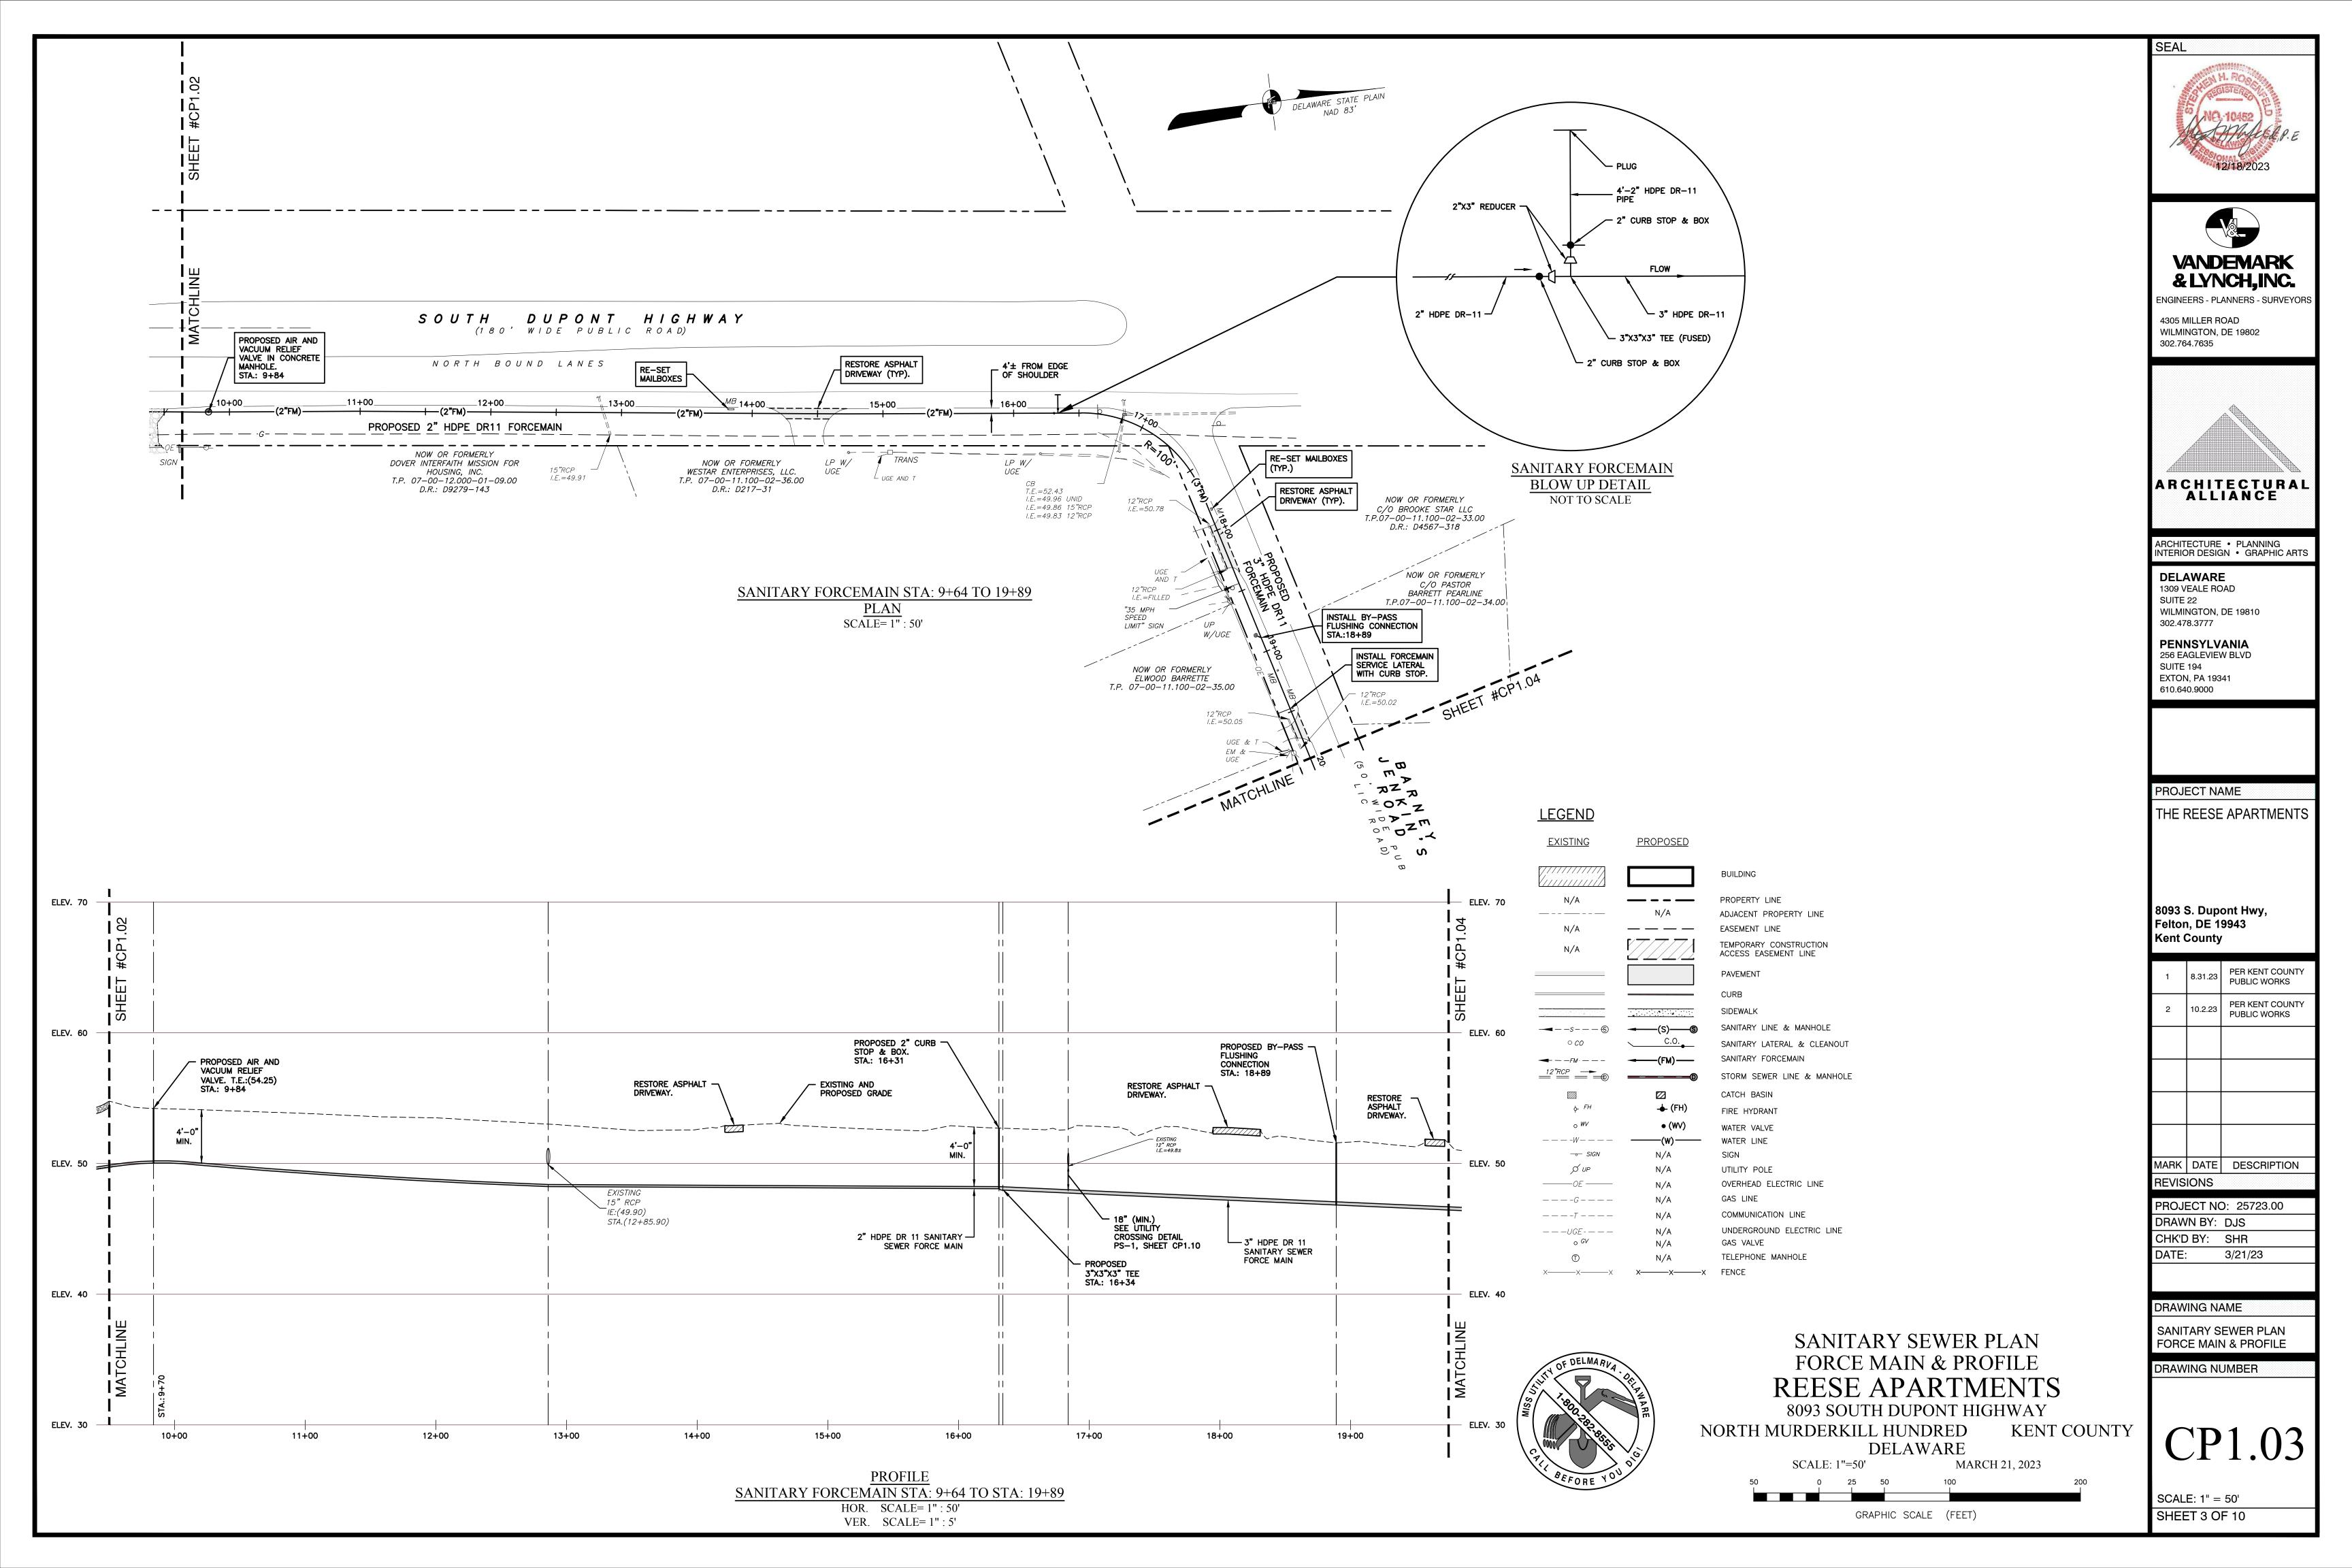

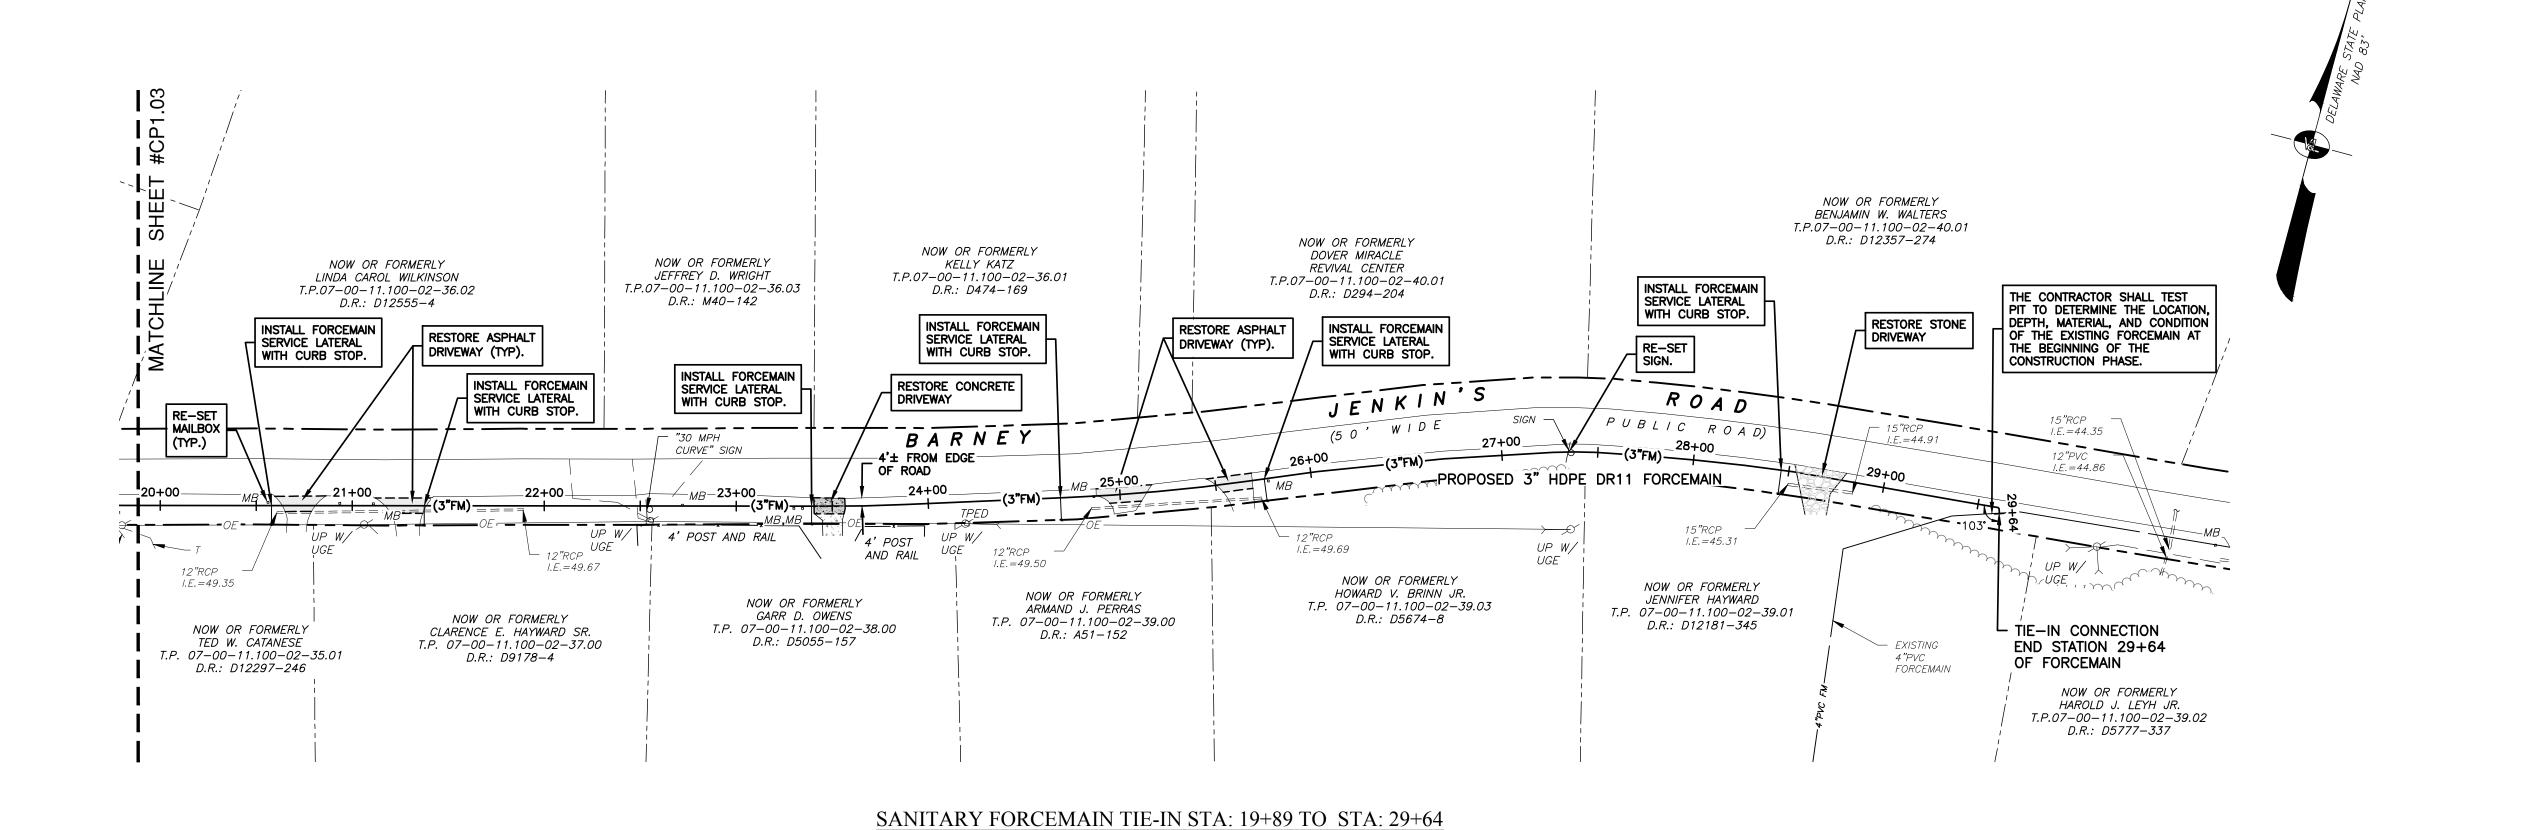

PLAN

SCALE= 1" : 50'

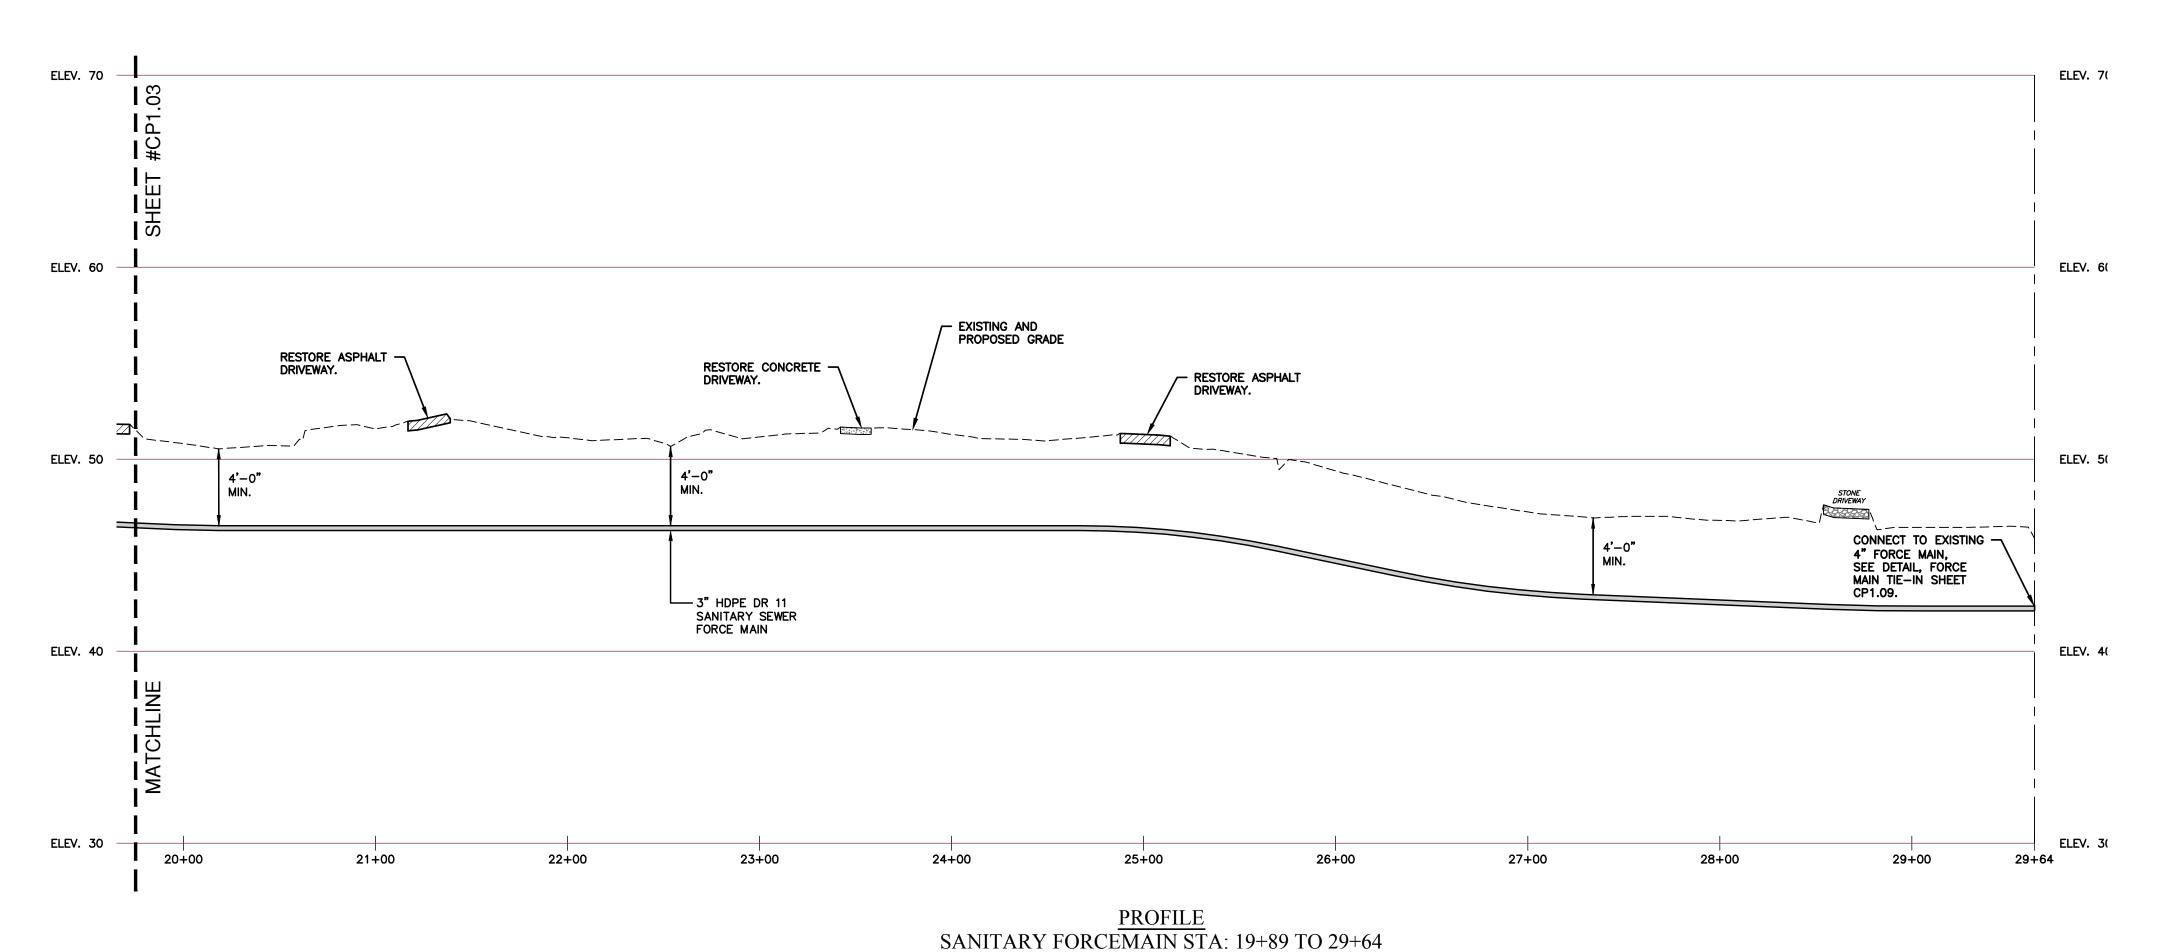

HOR. SCALE= 1": 50'

VER. SCALE= 1" : 5'

BUILDING PROPERTY LINE ADJACENT PROPERTY LINE EASEMENT LINE TEMPORARY CONSTRUCTION ACCESS EASEMENT LINE PAVEMENT CURB SIDEWALK SANITARY LINE & MANHOLE SANITARY LATERAL & CLEANOUT SANITARY FORCEMAIN **─** - - FM · - - -STORM SEWER LINE & MANHOLE CATCH BASIN FIRE HYDRANT WATER VALVE

N/A

WATER LINE

UTILITY POLE

GAS LINE

GAS VALVE


OVERHEAD ELECTRIC LINE

UNDERGROUND ELECTRIC LINE

COMMUNICATION LINE

TELEPHONE MANHOLE

<u>PROPOSED</u>

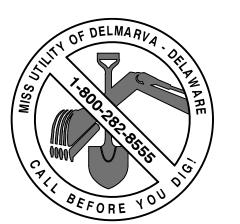

— — — UGE - — —

X-----X

<u>LEGEND</u>

SANITARY SEWER PLAN FORCE MAIN & PROFILE REESE APARTMENTS 8093 SOUTH DUPONT HIGHWAY

NORTH MURDERKILL HUNDRED KENT COUNTY DELAWARE

SCALE: 1"=50' MARCH 21, 2023

0 25 50 100 200


GRAPHIC SCALE (FEET)

NO. 10452 12/18/2023



ENGINEERS - PLANNERS - SURVEYORS 4305 MILLER ROAD WILMINGTON, DE 19802

302.764.7635

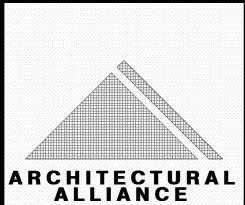

ARCHITECTURE • PLANNING INTERIOR DESIGN • GRAPHIC ARTS

DELAWARE1309 VEALE ROAD
SUITE 22
WILMINGTON, DE 19810
302.478.3777

PENNSYLVANIA 256 EAGLEVIEW BLVD SUITE 194 EXTON, PA 19341 610.640.9000

PROJECT NAME

THE REESE APARTMENTS

8093 S. Dupont Hwy, Felton, DE 19943 Kent County

1	8.31.23	PER KENT COUNTY PUBLIC WORKS
2	10.2.23	PER KENT COUNTY PUBLIC WORKS
MARK	DATE	DESCRIPTION

REVISIONS

PROJECT NO: 25723.00

DRAWN BY: DJS

CHK'D BY: SHR

DATE: 3/21/23


DRAWING NAME


SANITARY SEWER PLAN FORCE MAIN & PROFILE

DRAWING NUMBER


CP1.04

SCALE: 1" = 50' SHEET 4 OF 10

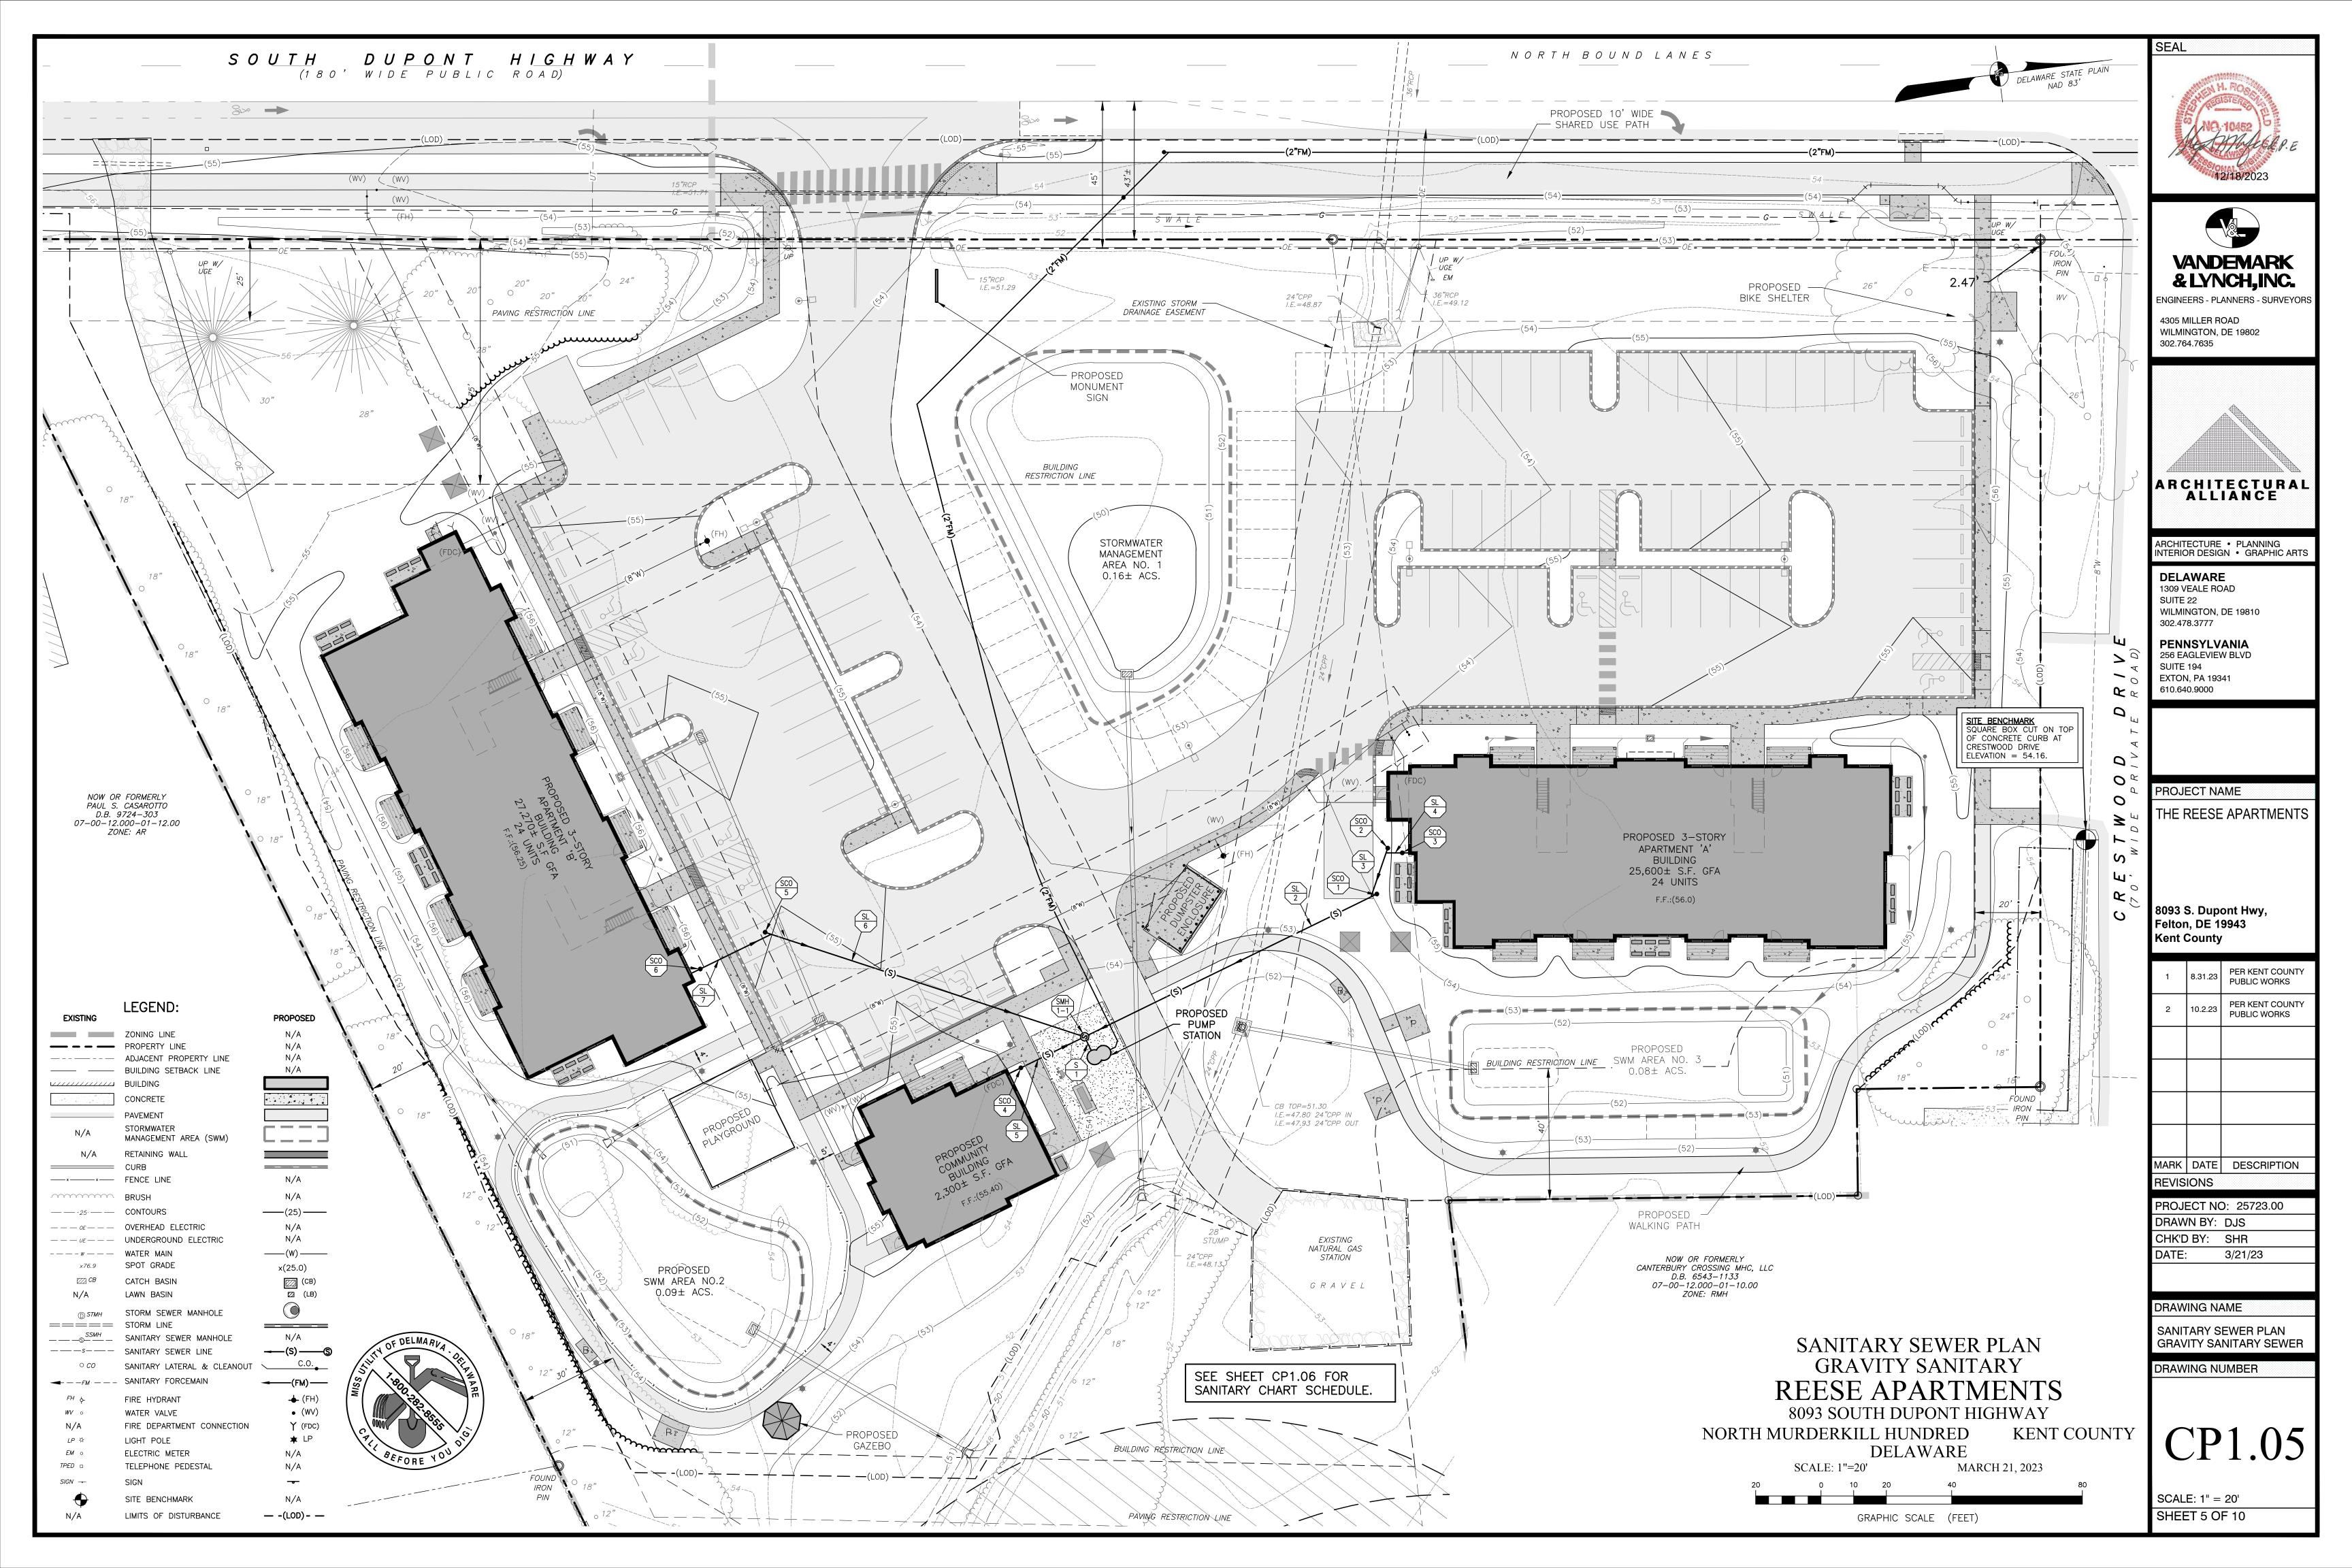


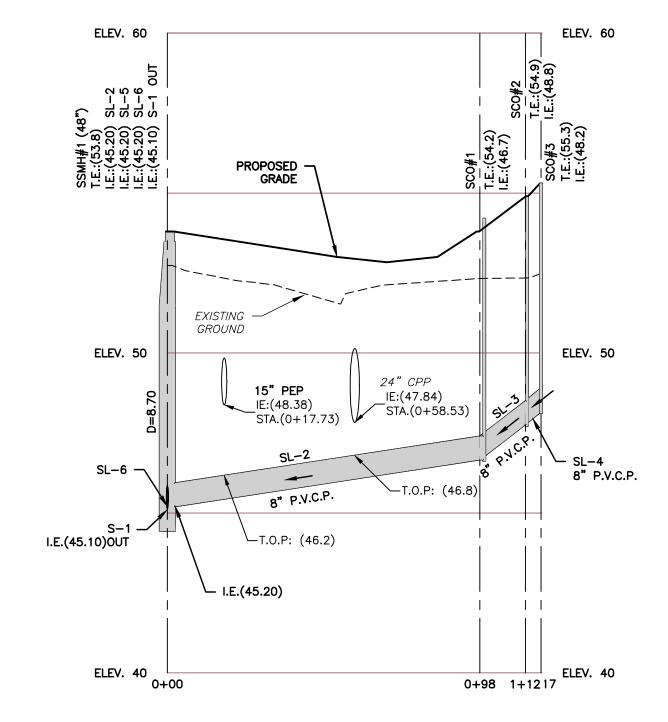

PROFILE
SANITARY SSMH-1 TO SSCO-3
HOR. SCALE= 1": 30'
VER. SCALE= 1": 3'

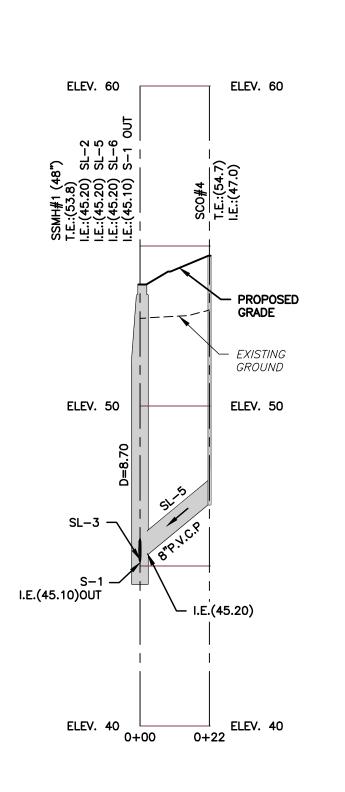

PROFILE
SANITARY SSMH-1 TO SSCO-4
HOR. SCALE= 1": 30'
VER. SCALE= 1": 3'

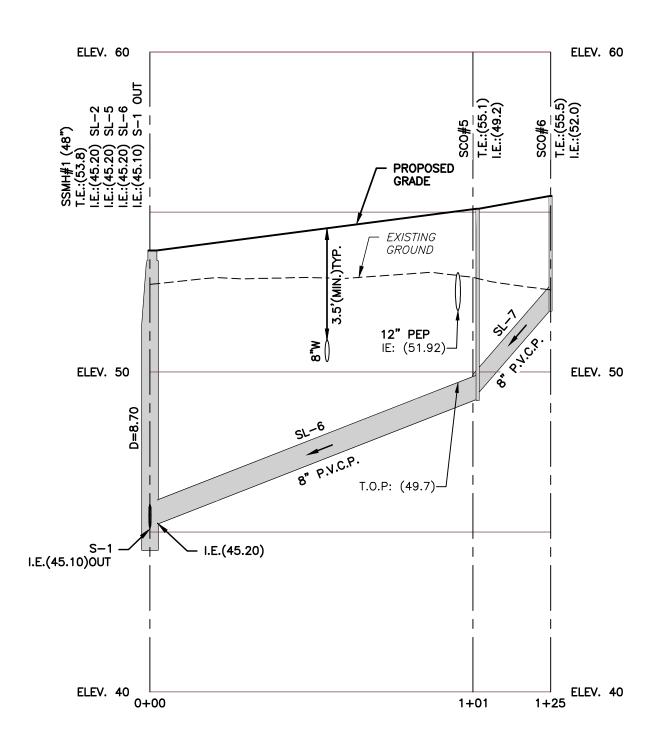

PROFILE
SANITARY SSMH-1 TO SSCO-6
HOR. SCALE= 1": 30'
VER. SCALE= 1": 3'

SANITARY MANHOLE SCHEDULE (SS)					
NO.	SIZE	TOP ELEV.	INV. ELEV. (IN)	INV. ELEV. (OUT)	
1-1	48"	53.8	45.20 (SL-2) 45.20 (SL-5) 45.20 (SL-6)	45.10 (S-1)	


SANIT	ARY PIPE	SCHED	ULE S
NO.	SIZE/TYPE	LENGTH	SLOPE
S-1	8" P.V.C.P.	5 L.F.	0.0200 FT/FT

·	•	'		<u>'' </u>	0 2	
	PIPE -26.	SHALI	_ BE	ASTN	И D3034,	

SANITAR	SANITARY CLEANOUT SCHEDULE (SCO)				
NO.	T.E.	I.E.			
SCO-1	54.2	46.7			
SCO-2	54.9	47.8			
SCO-3	55.3	48.2			
SCO-4	54.7	47.0			
SCO-5	55.1	49.2			
SCO-6	55.5	52.0			

	SANIT	ARY LATER	RAL SCH	IEDULE (SL.)	
	NO.	SIZE/TYPE	LENGTH	SLOPE	
	SL-2	8" P.V.C.P.	98 L.F.	0.0150 FT/FT	
	SL-3	8" P.V.C.P.	141 L.F.	0.0800 FT/FT	
	SL-4	8" P.V.C.P.	5 L.F.	0.0800 FT/FT	
	SL-5	8" P.V.C.P.	22 L.F.	0.0800 FT/FT	
	SL-6	8" P.V.C.P.	101 L.F.	0.0400 FT/FT	
	SL-7	8" P.V.C.P.	24 L.F.	0.0200 FT/FT	
PVC PIPE SHALL BE ASTM D3034					

PVC PIPE SHALL BE ASTM D3034, SDR-26.

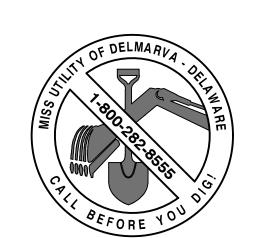

<u>LEGEND</u>

EXISTING

----UGE----

<u>PROPOSED</u>

N/A

PAVEMENT

SANITARY LINE & MANHOLE
SANITARY LATERAL & CLEANOUT

STORM SEWER LINE & MANHOLE

SANITARY FORCEMAIN

CATCH BASIN

FIRE HYDRANT

WATER VALVE

UTILITY POLE

GAS LINE

GAS VALVE

OVERHEAD ELECTRIC LINE

UNDERGROUND ELECTRIC LINE

COMMUNICATION LINE

TELEPHONE MANHOLE

SIGN

SANITARY SEWER PROFILES REESE APARTMENTS 8093 SOUTH DUPONT HIGHWAY

NORTH MURDERKILL HUNDRED KENT COUNTY DELAWARE

SCALE: 1"=30' MARCH 21, 2023


0 15 30 60 120

GRAPHIC SCALE (FEET)

SEAL NO. 10452 P. E. 12/18/2023



ENGINEERS - PLANNERS - SURVEYORS 4305 MILLER ROAD WILMINGTON, DE 19802 302.764.7635

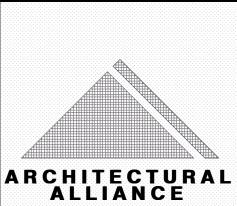

ARCHITECTURE • PLANNING INTERIOR DESIGN • GRAPHIC ARTS

DELAWARE
1309 VEALE ROAD
SUITE 22
WILMINGTON, DE 19810
302.478.3777

PENNSYLVANIA 256 EAGLEVIEW BLVD SUITE 194 EXTON, PA 19341

610.640.9000

PROJECT NAME

THE REESE APARTMENTS

8093 S. Dupont Hwy, Felton, DE 19943 Kent County

1	8.31.23	PER KENT COUNTY PUBLIC WORKS
2	10.2.23	PER KENT COUNTY PUBLIC WORKS
MARK	DATE	DESCRIPTION

REVISIONS	
PROJECT NO:	25723.00

DRAWN BY: DJS

CHK'D BY: SHR

DATE: 3/21/23


DRAWING NAME


SANITARY SEWER PROFILE

DRAWING NUMBER

CP1.06

SCALE: 1" = 30' SHEET 6 OF 10

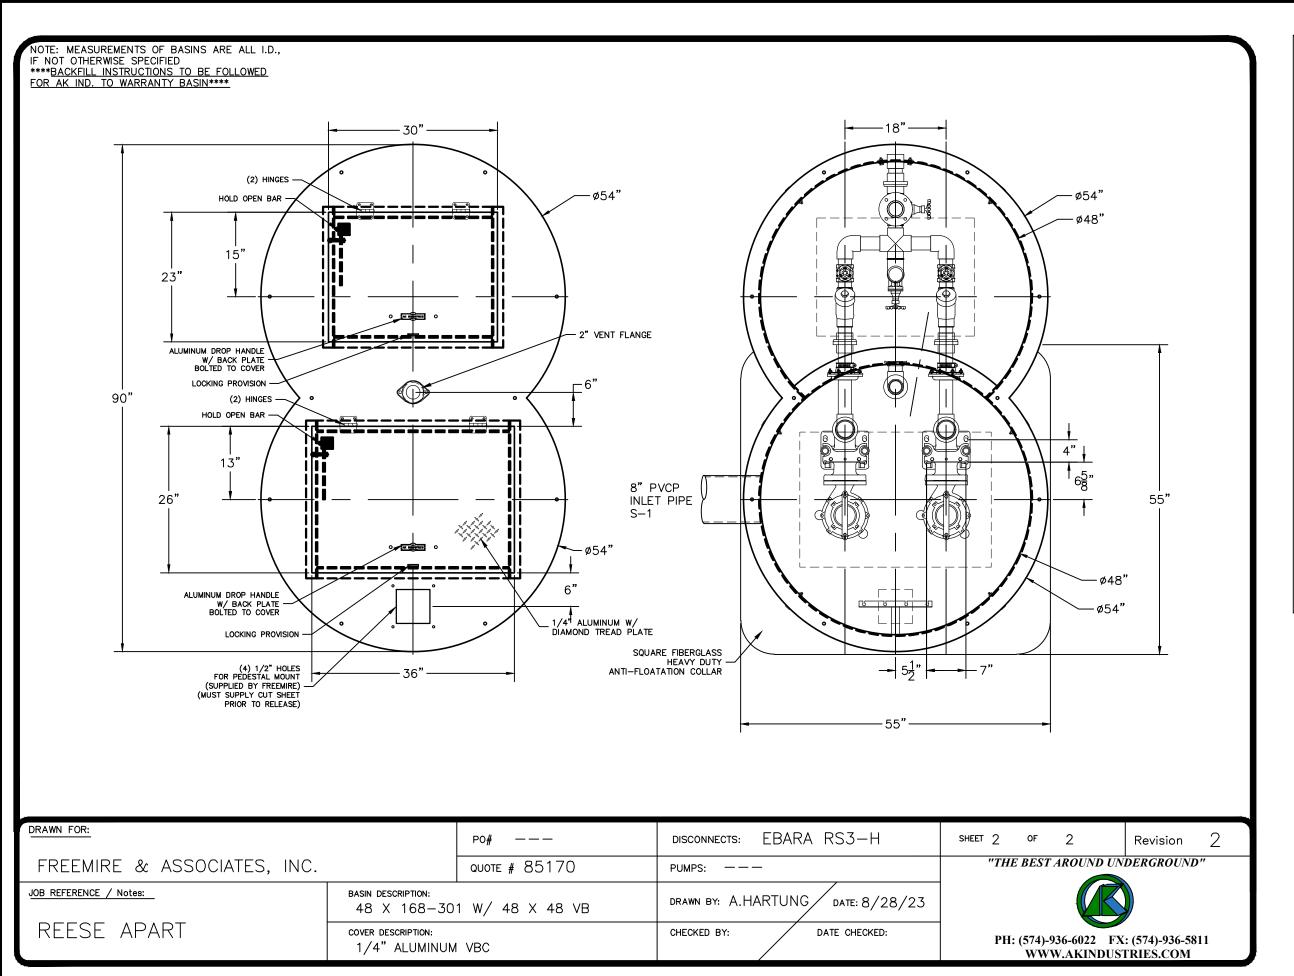

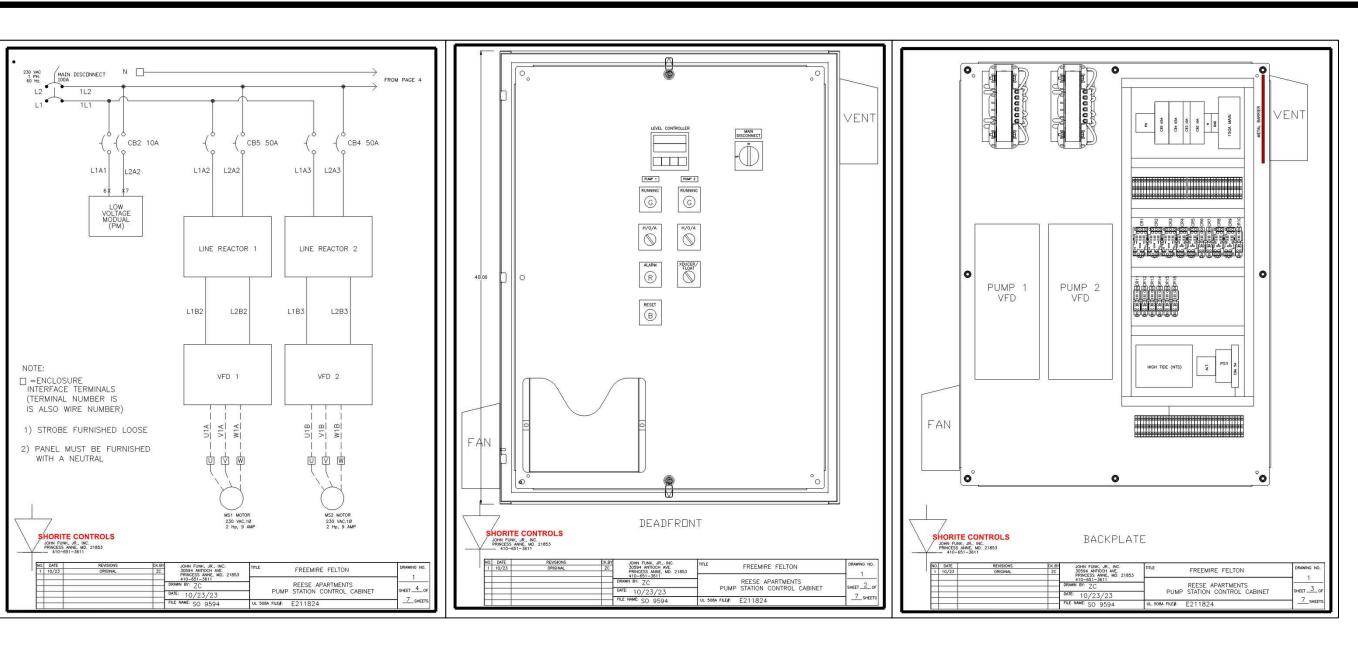

<u>LEGEND</u>

EXISTING

S UP

____OE ____

— — — UGE - — — —

PROPOSED

BUILDING

PROPERTY LINE

EASEMENT LINE

PAVEMENT

SIDEWALK

ADJACENT PROPERTY LINE

SANITARY LINE & MANHOLE

SANITARY FORCEMAIN

CATCH BASIN

FIRE HYDRANT

WATER VALVE

WATER LINE

UTILITY POLE

GAS LINE

GAS VALVE

OVERHEAD ELECTRIC LINE


UNDERGROUND ELECTRIC LINE

COMMUNICATION LINE

TELEPHONE MANHOLE

SANITARY LATERAL & CLEANOUT

STORM SEWER LINE & MANHOLE

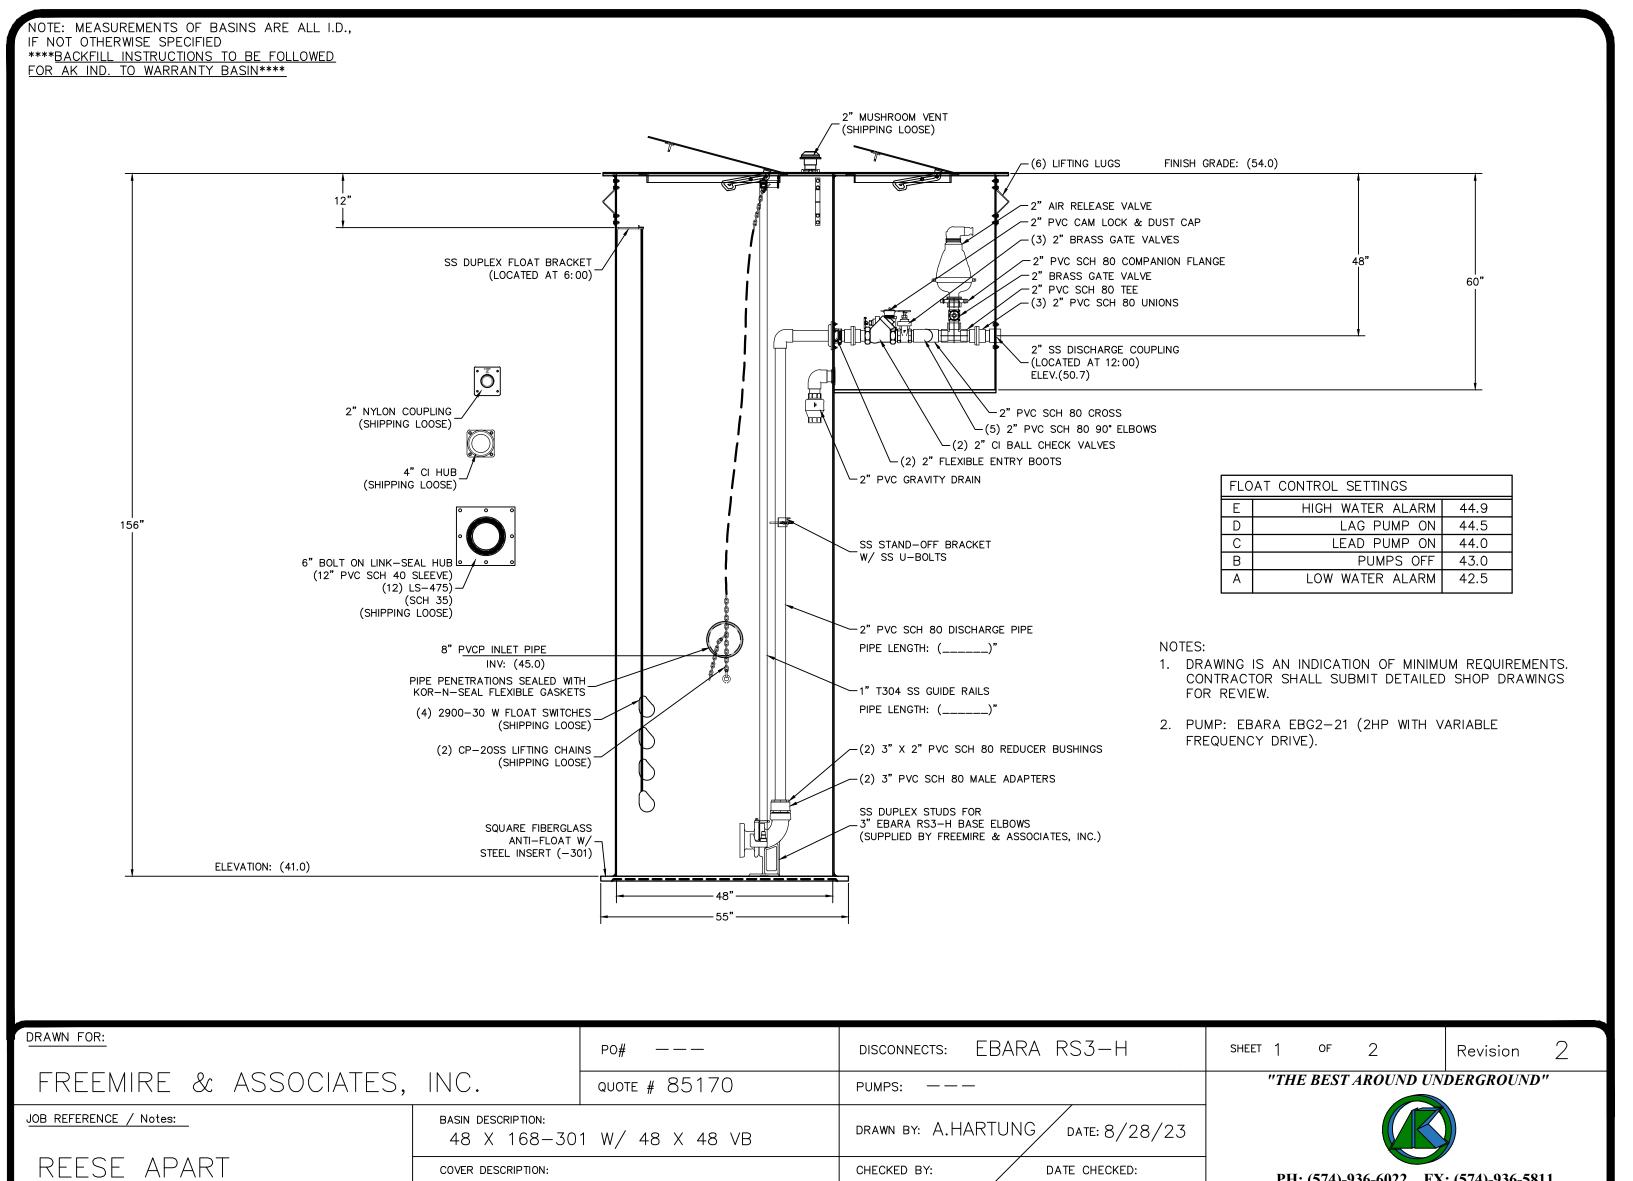

CHECKED BY:


DATE CHECKED:

PH: (574)-936-6022 FX: (574)-936-5811


WWW.AKINDUSTRIES.COM


COVER DESCRIPTION:

1/4" ALUMINUM VBC

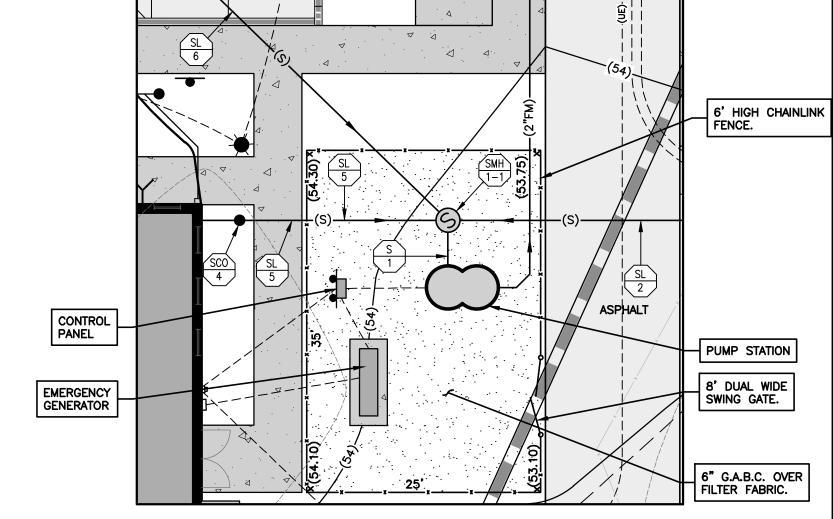

PUMP STATION PLAN VIEW

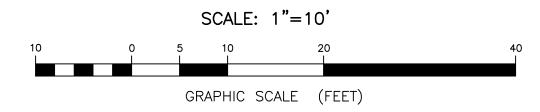

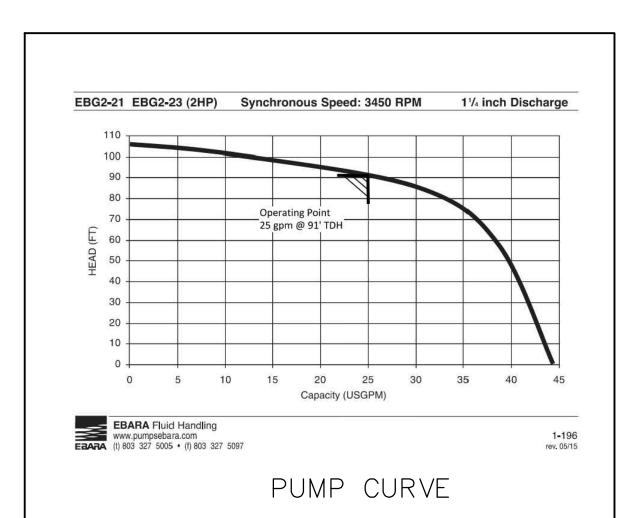

SANITARY SEWER PLAN PUMP STATION DETAILS FELTON APARTMENTS

8093 SOUTH DUPONT HIGHWAY NORTH MURDERKILL HUNDRED KENT COUNTY **DELAWARE** SCALE: AS SHOWN MARCH 21, 2023



NGINEERS - PLANNERS - SURVEYORS 4305 MILLER ROAD WILMINGTON, DE 19802 302.764.7635



ARCHITECTURAL ALLIANCE

ARCHITECTURE • PLANNING INTERIOR DESIGN • GRAPHIC ARTS

DELAWARE 1309 VEALE ROAD SUITE 22 WILMINGTON, DE 19810 302.478.3777

PENNSYLVANIA 256 EAGLEVIEW BLVD SUITE 194 **EXTON, PA 19341** 610.640.9000

PROJECT NAME

THE REESE APARTMENTS

8093 S. Dupont Hwy, Felton, DE 19943

Kent County

PER KENT COUNTY PUBLIC WORKS PER KENT COUNTY 10.2.23 PUBLIC WORKS

MARK DATE DESCRIPTION REVISIONS


PROJECT NO: 25723.00 DRAWN BY: DJS CHK'D BY: SHR DATE: 3/21/23


DRAWING NAME


SANITARY SEWER PLAN PUMP STATION DETAILS


DRAWING NUMBER


SCALE: AS SHOWN SHEET 7 OF 10

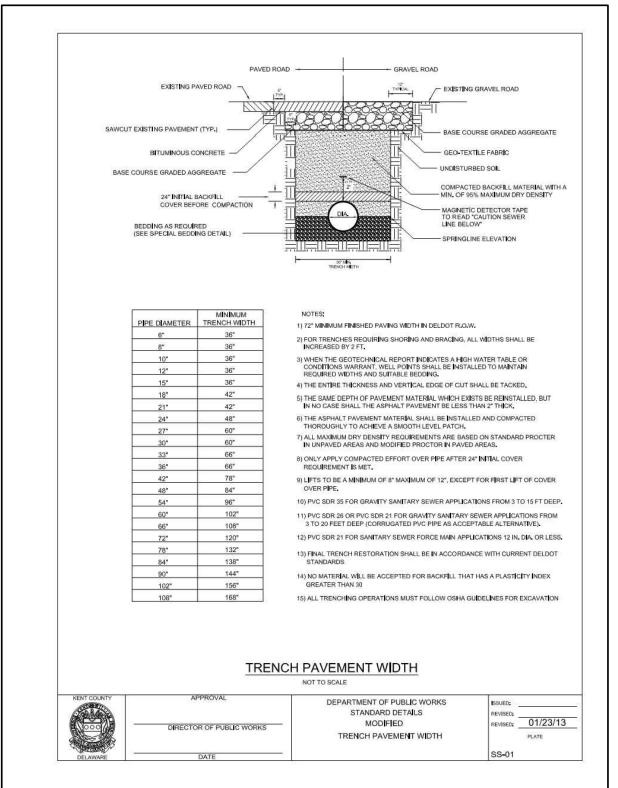


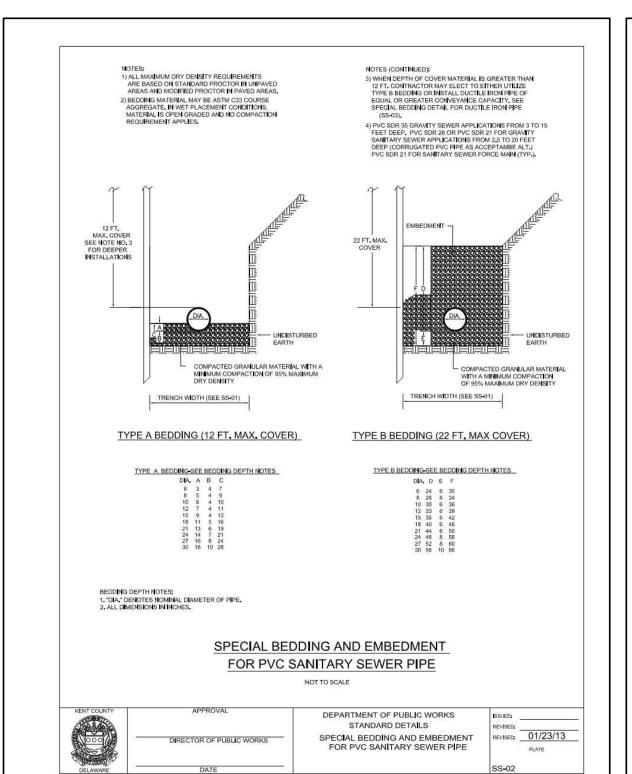

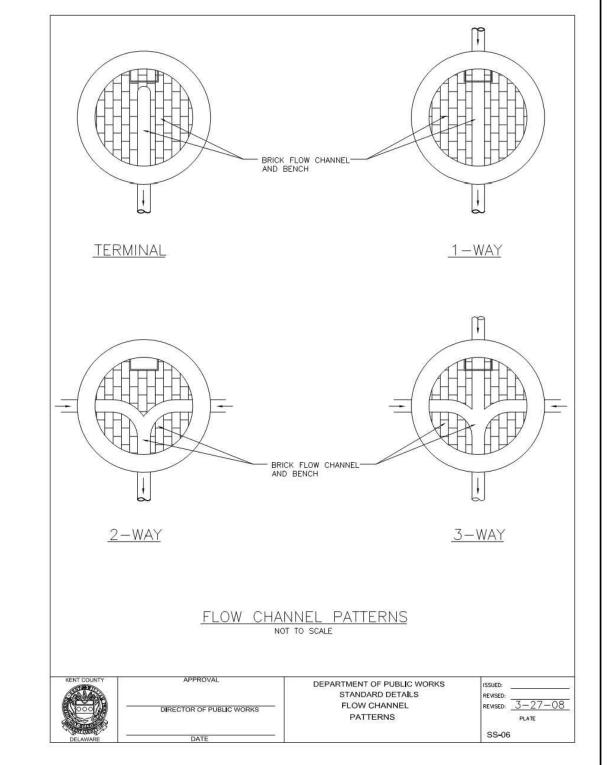

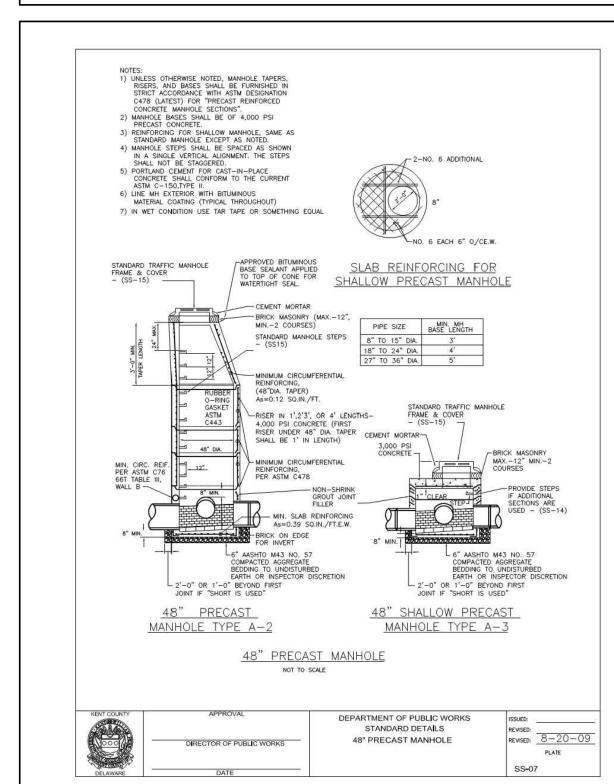

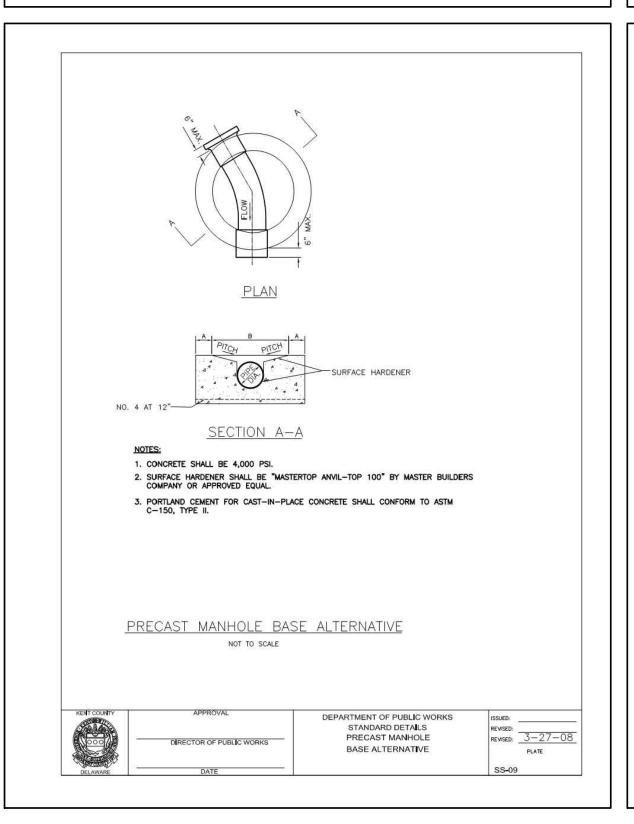

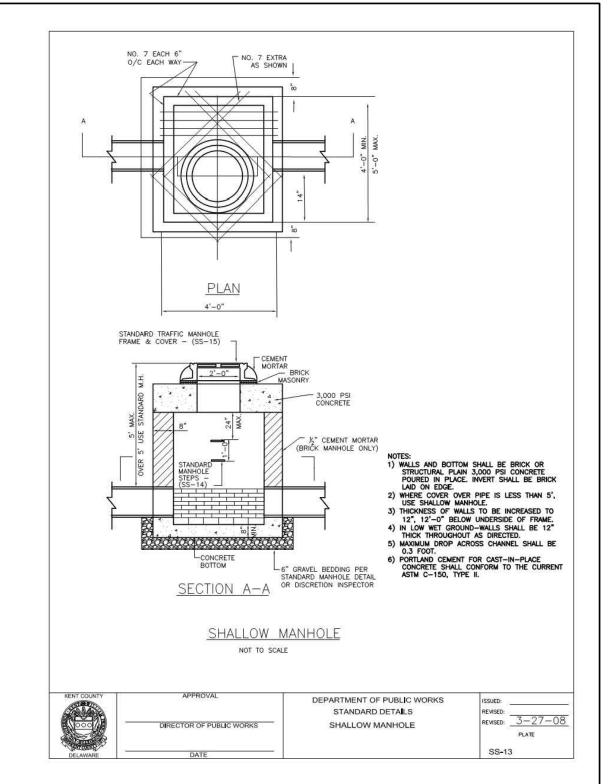

SANITARY SEWER PLAN
CONSTRUCTION NOTES AND DETAILS
REESE APARTMENTS
8093 SOUTH DUPONT HIGHWAY

NORTH MURDERKILL HUNDRED KENT COUNTY
DELAWARE
SCALE: AS SHOWN MARCH 21, 2022

SCALE: AS SHOWN MARCH 21, 2023

50 0 25 50 100 200

GRAPHIC SCALE (FEET)

12/18/2023



4305 MILLER ROAD
WILMINGTON, DE 19802
302.764.7635



ARCHITECTURE • PLANNING INTERIOR DESIGN • GRAPHIC ARTS

DELAWARE
1309 VEALE ROAD
SUITE 22
WILMINGTON, DE 19810

PENNSYLVANIA 256 EAGLEVIEW BLVD SUITE 194 EXTON, PA 19341

302.478.3777

610.640.9000

PROJECT NAME

THE REESE APARTMENTS

8093 S. Dupont Hwy, Felton, DE 19943 Kent County

1	8.31.23	PER KENT COUNTY PUBLIC WORKS
2	10.2.23	PER KENT COUNTY PUBLIC WORKS

MARK DATE DESCRIPTION
REVISIONS

PROJECT NO: 25723.00

DRAWN BY: DJS

CHK'D BY: SHR

DATE: 3/21/23


DRAWING NAME


SANITARY SEWER PLAN CONST. NOTES AND DETAILS


DRAWING NUMBER


CP1.08

SCALE: AS SHOWN
SHEET 8 OF 10

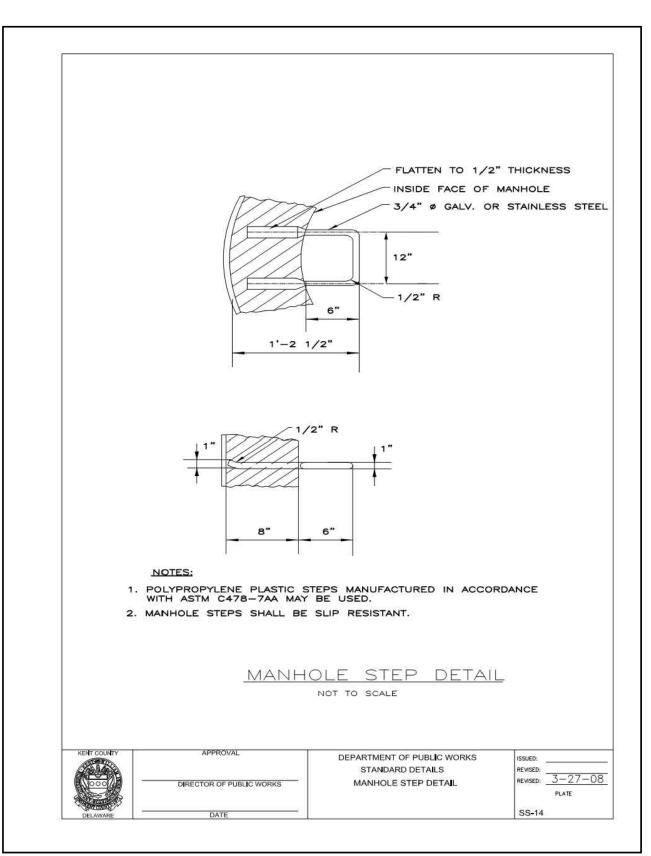


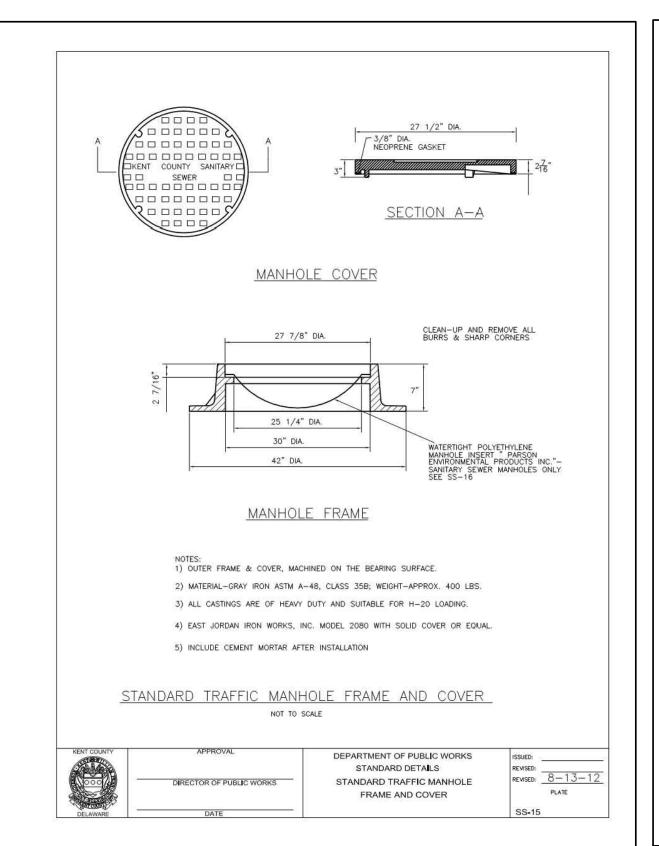


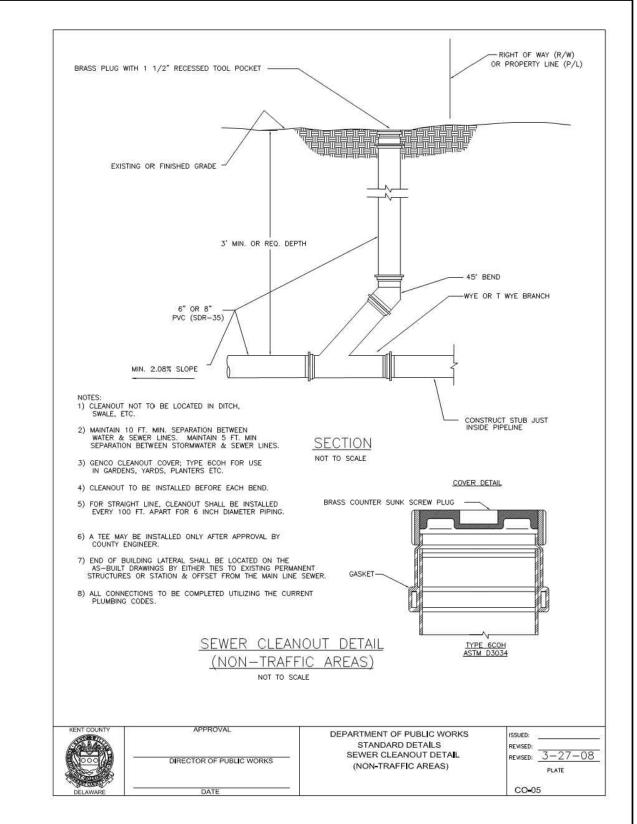


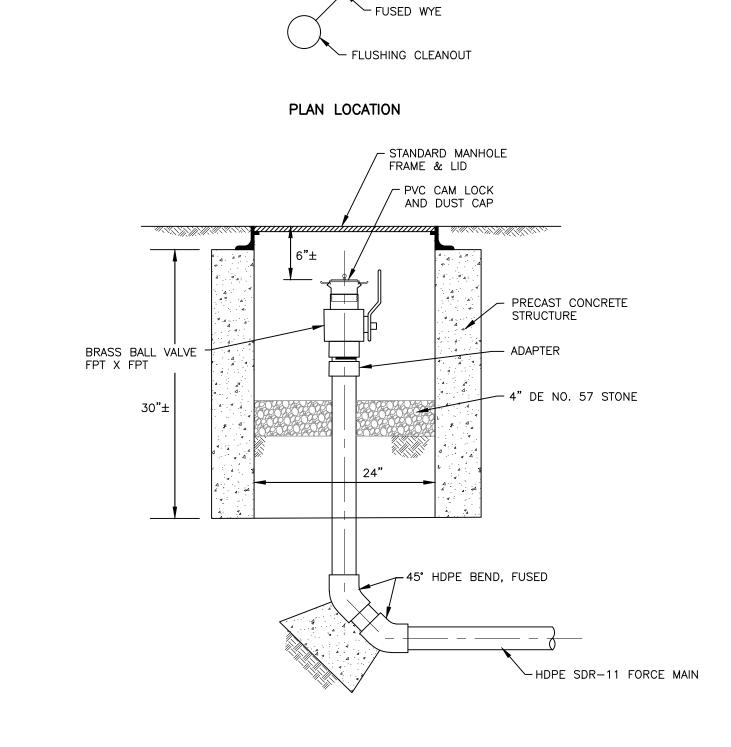



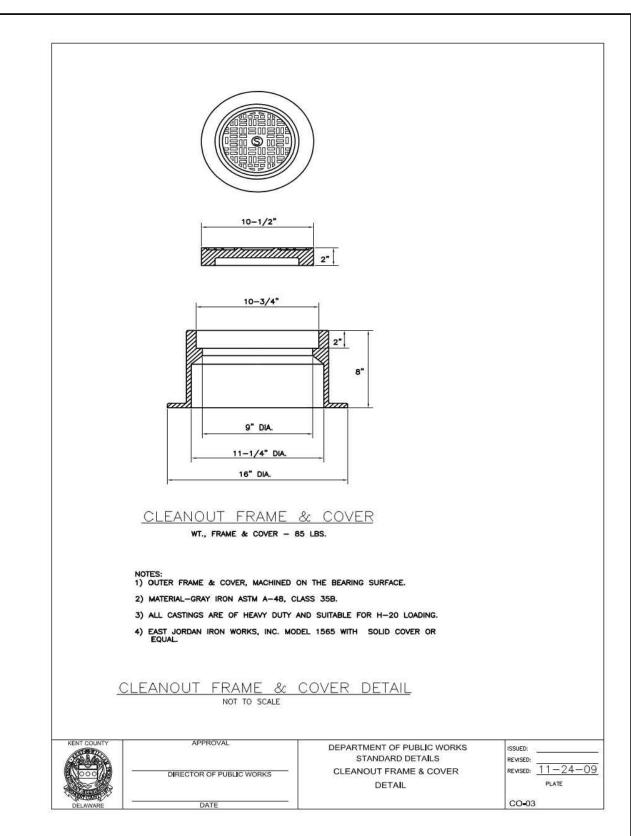

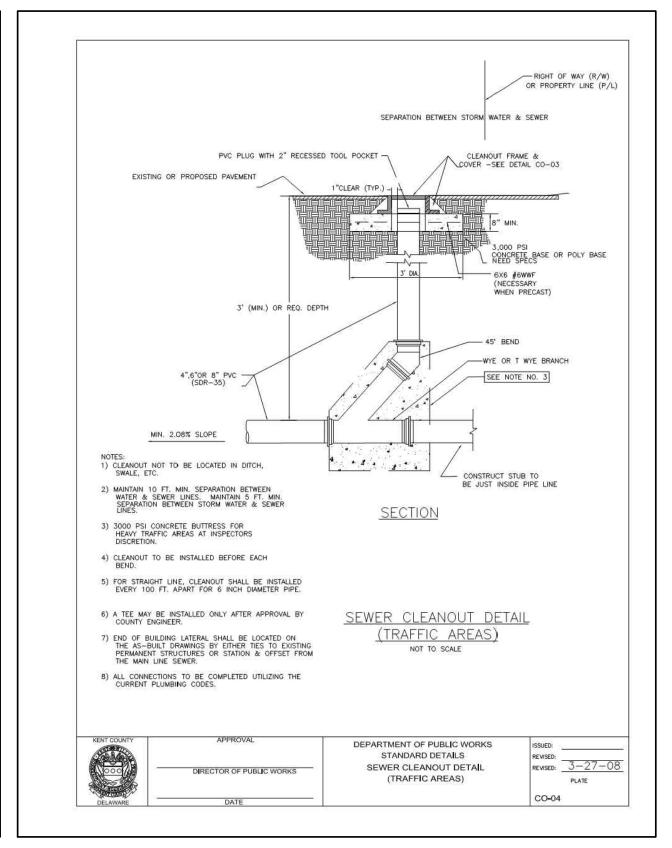

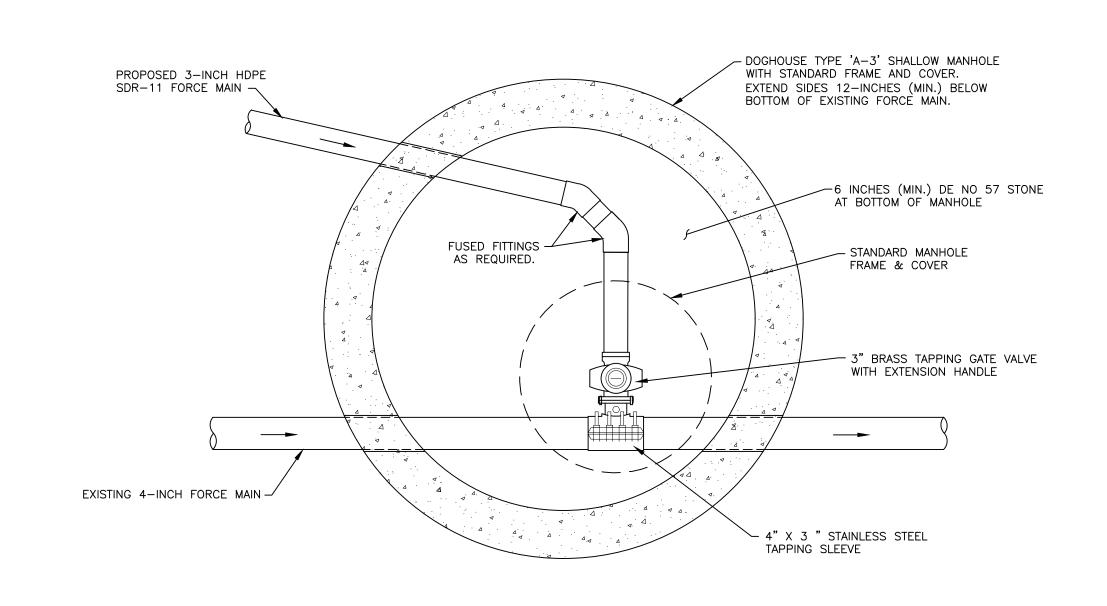

FORCE MAIN TIE-IN DETAIL

NOT TO SCALE

SANITARY SEWER PLAN CONSTRUCTION NOTES AND DETAILS REESE APARTMENTS 8093 SOUTH DUPONT HIGHWAY

NORTH MURDERKILL HUNDRED KENT COUNTY
DELAWARE
SCALE: AS SHOWN MARCH 21, 2022

SCALE: AS SHOWN MARCH 21, 2023

50 0 25 50 100 200

GRAPHIC SCALE (FEET)

NO. 10452 NO. 10452 NO. 10452 12/18/2023



ENGINEERS - PLANNERS - SURVEYORS
4305 MILLER ROAD
WILMINGTON, DE 19802
302.764.7635



ARCHITECTURE • PLANNING INTERIOR DESIGN • GRAPHIC ARTS

DELAWARE
1309 VEALE ROAD
SUITE 22
WILMINGTON, DE 19810
302.478.3777

PENNSYLVANIA 256 EAGLEVIEW BLVD SUITE 194 EXTON, PA 19341

610.640.9000

PROJECT NAME

THE REESE APARTMENTS

8093 S. Dupont Hwy, Felton, DE 19943 Kent County

1	8.31.23	PER KENT COUNTY PUBLIC WORKS
2	10.2.23	PER KENT COUNTY PUBLIC WORKS
MARK	DATE	DESCRIPTION

PROJECT NO: 25723.00

DRAWING NAME

DRAWN BY: DJS
CHK'D BY: SHR
DATE: 3/21/23


REVISIONS


DRAWING NUMBER


SANITARY SEWER PLAN CONST. NOTES AND DETAILS


CP1.09


SCALE: AS SHOWN
SHEET 9 OF 10

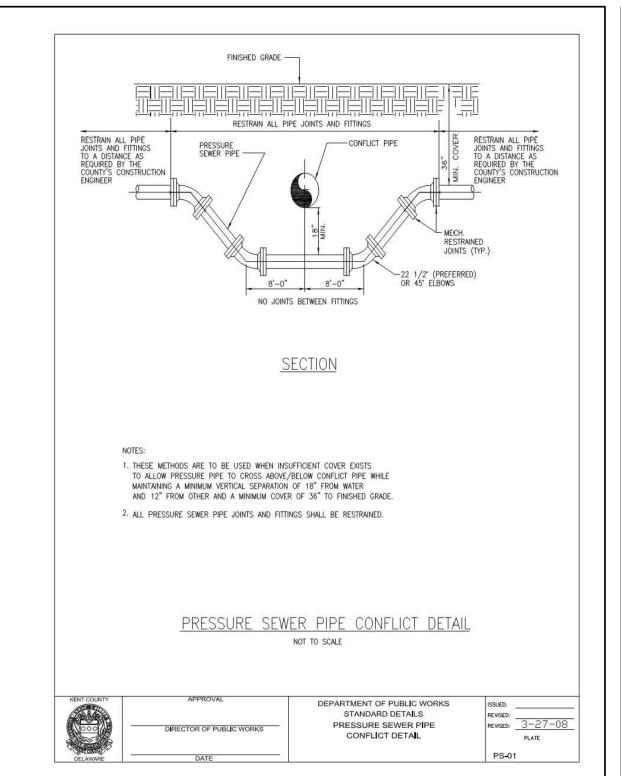

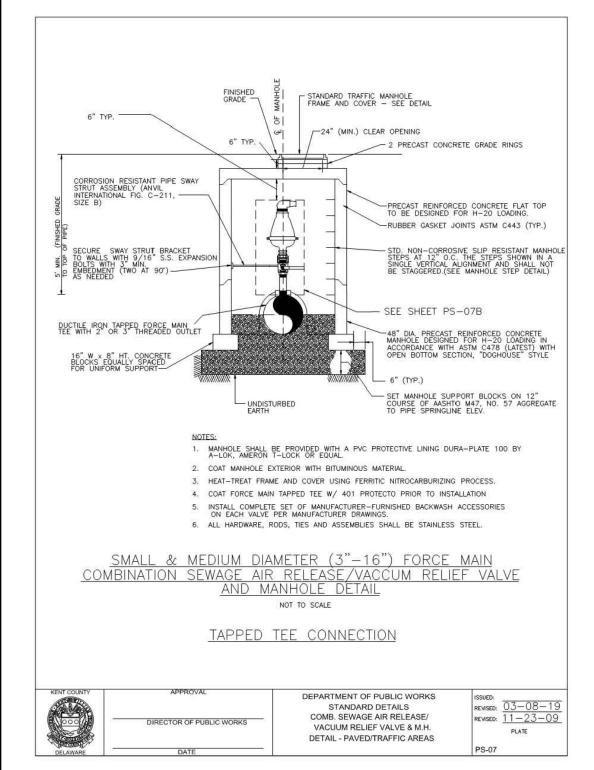

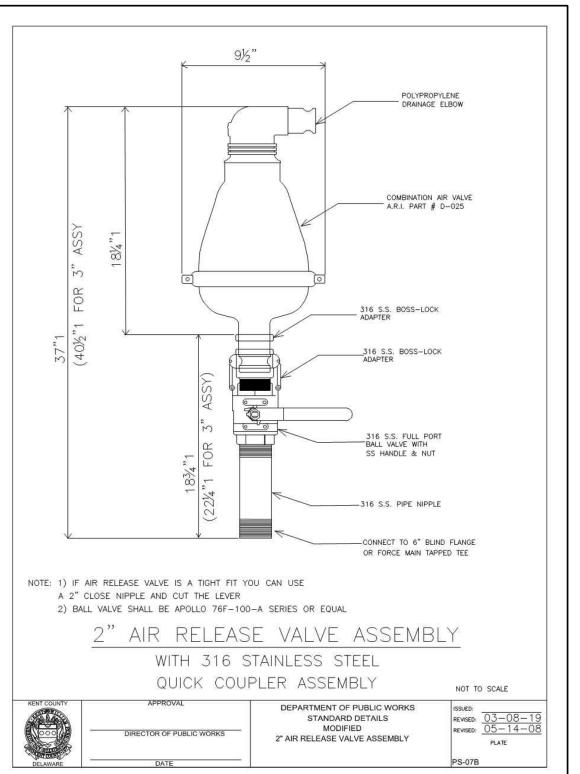

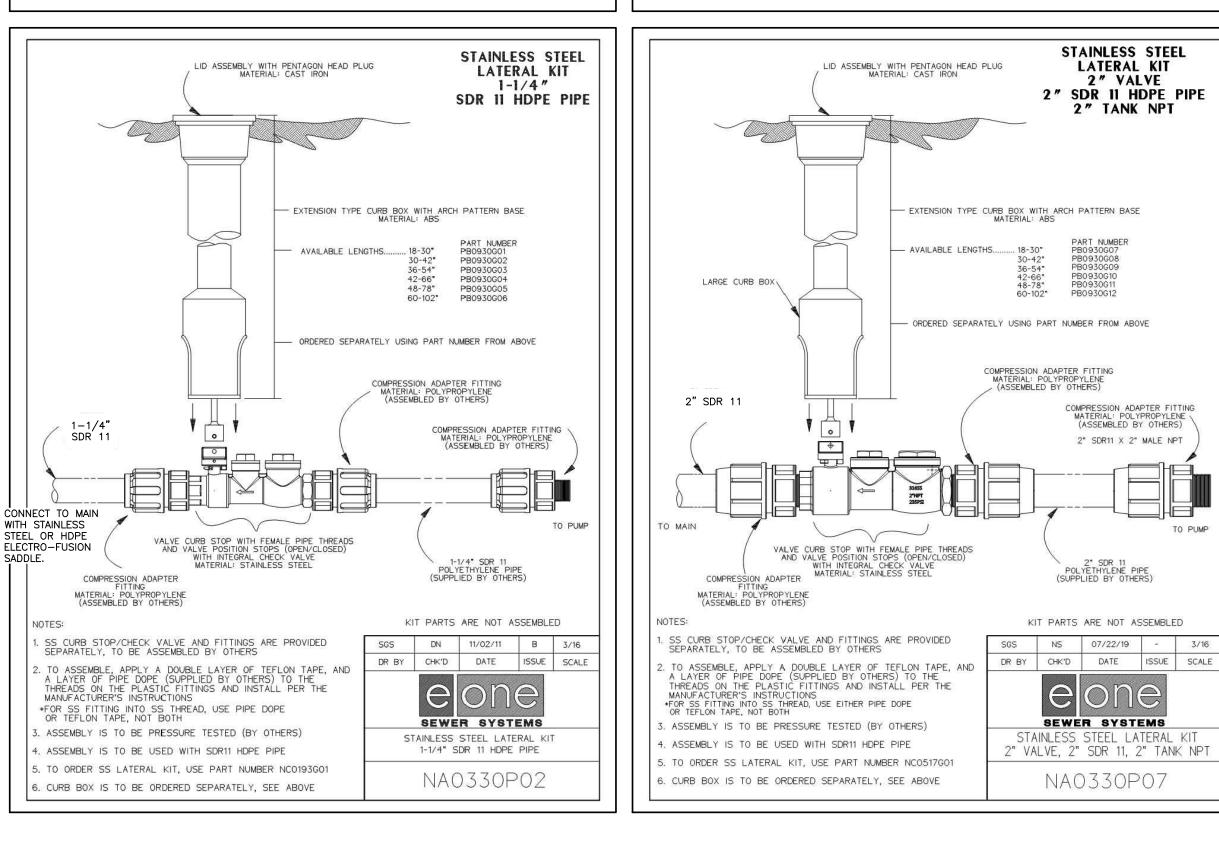

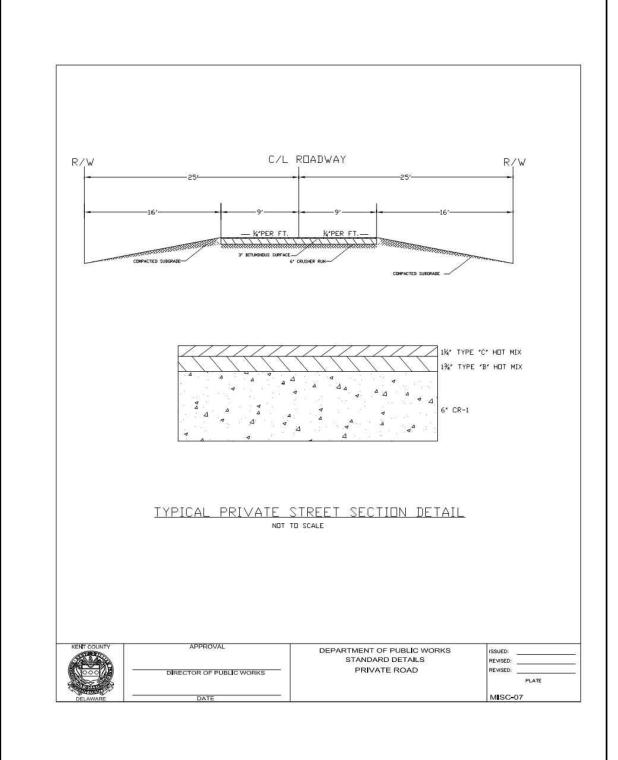

GENERAL NOTES

- 1. THE CONTRACTOR SHALL PROVIDE SEDIMENT CONTROL MEASURES TO PROTECT STOCKPILE AREAS AND STORAGE AREAS. ALL AREAS USED BY THE CONTRACTOR FOR STAGING OPERATIONS SHALL BE FULLY RESTORED BY THE CONTRACTOR UPON COMPLETION OF THE PROJECT. IF THE STAGING AREA IS PAVED, IT SHALL BE RESTORED TO ITS ORIGINAL CONDITION. IF THE STAGING AREA IS UNPAVED, IT SHALL BE RE-GRADED, TOPSOILED, SEEDED AND MULCHED TO THE SATISFACTION OF THE ENGINEER. ALL COSTS ASSOCIATED WITH RESTORATION OF THE STAGING AREA SHALL BE AT THE CONTRACTOR'S EXPENSE. IF THE ENGINEER DETERMINES THAT A SATISFACTORY STAND OF GRASS DOES NOT EXIST AT THE TIME OF FINAL INSPECTION, ALL COSTS ASSOCIATED WITH RE-ESTABLISHING A SATISFACTORY STAND OF GRASS SHALL BE AT THE CONTRACTOR'S EXPENSE.
- 2. EQUIPMENT AND/OR STOCKPILE MATERIAL SHALL NOT BE STORED IN THE DRIPLINE AREA OF ANY TREE.
- 3. THE CONTRACTOR SHALL CONTACT KENT COUNTY DEPARTMENT OF PUBLIC WORKS AT 302-744-2430 AT LEAST 48 HOURS IN ADVANCE OF STARTING CONSTRUCTION.
- 4. THE CONTRACTOR SHALL CONTACT MISS UTILITY OF DELMARVA AT 1-800-282-8555 FOR UTILITY LOCATIONS WITHIN AND SURROUNDING CONSTRUCTION AREAS NOT LESS THAN 3 DAYS BEFORE PERFORMING ANY EXCAVATION.
- 5. THE CONTRACTOR SHALL PROVIDE TEMPORARY SEED AND MULCH FOR ALL AREAS WHERE SOIL IS EXPOSED AND SILT FENCE IS NOT SPECIFIED, BY THE CLOSE OF EACH BUSINESS
- 6. THE CONTRACTOR SHALL MAINTAIN PUBLIC ROADS AND STREETS IN A BROOM SWEPT CONDITION AT ALL TIMES.
- 7. PIPE JOINTS TO BE RESTRAINED ARE SHOWN ON THE DRAWINGS.
- 8. THE CONTRACTOR SHALL USE ONLY NEW MATERIALS, PARTS, AND PRODUCTS.
 ALL MATERIALS SHALL BE STORED SO AS TO ASSURE THE PRESERVATION OF THEIR
 QUALITY AND FITNESS FOR THE INTENDED WORK.
- 9. MAINTENANCE OF TRAFFIC ALL WORK SHALL BE PERFORMED IN A MANNER THAT WILL ENSURE THE LEAST PRACTICABLE OBSTRUCTION TO TRAFFIC CONSISTENT WITH SAFETY AND SHALL COMPLY WITH THE DEPARTMENT MANUAL ENTITLED "TRAFFIC CONTROLS FOR STREETS AND HIGHWAY CONSTRUCTION, MAINTENANCE, UTILITY AND EMERGENCY OPERATIONS". THE MOST CURRENT VERSION OF THIS MANUAL IN EFFECT AT THE TIME OF CONSTRUCTION SHALL BE USED. HEREINAFTER, THIS MANUAL SHALL BE REFERRED TO AS THE "TRAFFIC CONTROL MANUAL". THE CONTRACTOR SHALL SUBMIT A TRAFFIC CONTROL PLAN FOR APPROVAL BY THE ENGINEER BEFORE THE START OF THE PROJECT.
- 10. ALL UTILITIES PLOTTED ON THE DRAWINGS ARE FROM THE BEST AVAILABLE INFORMATION. THE CONTRACTOR, PRIOR TO LAYING A RUN OF PIPE OR OTHER INVOLVED CONSTRUCTION, SHALL EXCAVATE WITHIN THE ALIGNMENT AT POINTS OF POSSIBLE CONFLICT TO DETERMINE IF A CONFLICT EXISTS. ANY CONFLICTS SHALL BE COORDINATED BY THE CONTRACTOR WITH THE ENGINEER AND THE UTILITY INVOLVED. THE ENGINEER SHALL DETERMINE THE SOLUTION. EXCAVATING, BACKFILLING AND RESTORATION OF THE TEST HOLES AS REQUIRED FOR UTILITY INVESTIGATIONS SHALL BE CONSIDERED INCIDENTAL TO THE INSTALLATION OF THE UTILITIES AS SHOWN ON THE PLANS.
- ALL CONSTRUCTION SHALL BE PERFORMED TO THE SATISFACTION OF THE ENGINEER, KENT COUNTY DEPARTMENT OF PUBLIC WORKS (DPW), DELAWARE DEPARTMENT OF TRANSPORTATION (DELDOT) AND ALL RESPECTIVE UTILITY OWNER/S IN ACCORDANCE WITH ALL APPLICABLE CONTRACT DRAWINGS AND SPECIFICATIONS.
- 12. THE CONTRACTOR SHALL COMPLY WITH ALL APPLICABLE LAWS, ORDINANCES, RULES, REGULATIONS AND ORDERS OF ANY PUBLIC BODY HAVING JURISDICTION. THE CONTRACTOR SHALL ERECT AND MAINTAIN, AS REQUIRED BY THE CONDITIONS AND PROGRESS OF THE WORK, ALL NECESSARY SAFEGUARDS FOR SAFETY AND PROTECTION.
- 13. THE CONTRACTOR SHALL INSTALL THE PROPOSED SANITARY SEWER AND FORCE MAINS WITH A MINIMUM OF 3 FT. OF CLEARANCE FROM OTHER EXISTING AND PROPOSED UTILITIES. THE CONTRACTOR SHALL MAINTAIN A MINIMUM HORIZONTAL CLEARANCE OF 10 FT. BETWEEN WATER MAINS AND SANITARY SEWERS (BOTH EXISTING AND PROPOSED MAINS). IN CASES WHERE THIS MINIMUM HORIZONTAL CLEARANCE IS NOT SHOWN OR FEASIBLE, THE CONTRACTOR MAY INSTALL THE PROPOSED SANITARY SEWER LESS THAN 10 FT. FROM EXISTING WATER LINES, PROVIDED ALL EXISTING WATER MAINS REMAIN ON AN UNDISTURBED EARTH SHELF IN A SEPARATE TRENCH FROM THE PROPOSED SANITARY SEWER MAINS AND THERE IS AT LEAST 18 INCHES OF VERTICAL CLEARANCE WITH THE WATER MAIN HIGHER THAN THE SEWER. IF VERTICAL CLEARANCE BETWEEN PROPOSED SANITARY SEWER AND EXISTING WATER MAINS IS LESS THAN 18 INCHES, THE CONTRACTOR SHALL CONCRETE ENCASE THE SANITARY SEWER PIPING A MINIMUM OF 10 FT. ON EACH SIDE OF THE WATER MAIN CROSSING OR 10 FT. BEYOND THE LIMITS WHERE VERTICAL CLEARANCE IS NOT MAINTAINED.
- 14. THE CONTRACTOR SHALL SUBMIT SHOP DRAWINGS FOR ALL MATERIALS FOR APPROVAL TO THE OWNER PRIOR TO COMMENCEMENT OF CONSTRUCTION. ALL MATERIALS ORDERED AND INSTALLED PRIOR TO THE OWNER'S REVIEW AND ACCEPTANCE WILL BE AT THE CONTRACTOR'S RISK.
- 15. THE CONTRACTOR SHALL OPEN ONLY THAT SECTION OF TRENCH OR ACCESS PITS WHICH CAN BE BACKFILLED AND STABILIZED AT THE END OF EACH WORKING DAY. STEEL PLATES SHALL BE USED ON ANY TRENCH OR ACCESS PITS WHICH MUST REMAIN OPEN OVERNIGHT. THIS REQUIREMENT DOES NOT APPLY TO AREAS COMPLETELY CLOSED AND SECURE FROM VEHICULAR OR PEDESTRIAN TRAFFIC.
- 16. SANITARY SEWER PIPE AND FITTINGS SHALL BE TYPE PSM, POLYVINYL CHLORIDE (PVC)
 MATERIAL WITH A MINIMUM CELL CLASSIFICATION OF 12454B AND COMPLYING WITH ASTM D1784;
 INSIDE NOMINAL DIAMETER AS INDICATED ON THE DRAWINGS; BELL AND SPIGOT STYLE RUBBER
 RING SEALED ELASTOMERIC LOCKED—IN GASKET JOINT COMPLYING WITH ASTM F477.
- SANITARY SEWER PIPE AND FITTINGS 4 INCHES THROUGH 15 INCHES: ASTM D3034 AND F1336 WITH A MINIMUM WALL THICKNESS OF SDR 35. IF THE PIPE COVER EXCEEDS 15 FEET MIN. OF PVC SDR 26 SHALL BE USED.
- 17. SADDLES SHALL BE PVC CORRECTLY CONTOURED FOR OUTSIDE DIAMETER OF PIPE AND INCORPORATING RING GASKET BELL OUTLET.
- 18. PIPE PLUGS SHALL BE DESIGNED FOR PERMANENT INSTALLATION AND SHALL BE REMOVABLE.

 OBTAIN PLUGS FOR VARIOUS TYPES OF PIPE USED FROM THE RESPECTIVE PIPE MANUFACTURER.
- 19. ALL PVC SANITARY SEWER AND FORCE MAINS SHALL BE MARKED WITH LOCATOR TAPE, LABELED "SANITARY SEWER", INSTALLED 18" ABOVE THE PIPE.
- 20. FINAL APPROVED SET OF PLANS AND SPECIFICATIONS SHALL BE MAINTAINED ON THE JOB SITE. FAILURE TO COMPLY WITH THIS PROVISION SHALL BE CONSIDERED CAUSE TO STOP THE WORK.
- 21. THE CONTRACTOR SHALL MAINTAIN ONE COMPLETE SET OF CONTRACT DRAWINGS ON WHICH HE SHALL NOTE, IN RED, THE ALIGNMENTS AND INVERTS OF ALL UNDERGROUND UTILITIES ALL A INSTALLED OR ENCOUNTERED DURING THE PROSECUTION OF THE WORK. ALL DISCREPANCIES BETWEEN THE PLAN LOCATIONS AND ELEVATIONS OF BOTH THE EXISTING AND PROPOSED UTILITIES SHALL BE SHOWN ON THE AS—BUILT DRAWINGS TO BE MAINTAINED BY THE CONTRACTOR IN THE FIELD.
- 2. ROUTINE PERIODIC INSPECTIONS DURING CONSTRUCTION MAY BE PROVIDED BY KENT COUNTY.
 THESE INSPECTIONS DO NOT RELIEVE THE CONTRACTOR FROM HIS OBLIGATION AND
 RESPONSIBILITY FOR CONSTRUCTING A SANITARY SEWER SYSTEM IN STRICT ACCORDANCE WITH
 THE STANDARDS AND SPECIFICATIONS OF THE OWNER.
- 23. AFTER TESTING IS COMPLETE AND ALL COMPONENTS OF THE SANITARY SEWER SYSTEM ARE DEEMED ACCEPTABLE, THE CONTRACTOR SHALL SUBMIT THE AS—BUILT DRAWINGS TO KENT COUNTY. ANY DISCREPANCIES NOTED DURING THE FINAL INSPECTION SHALL BE CORRECTED BY THE CONTRACTOR WITHIN 30 DAYS.
- 24. THE PROPERTY AND RIGHT OF WAY LINES SHOWN ON THESE DRAWINGS ARE APPROXIMATE, AND ARE NOT BASED ON METES AND BOUNDS FIELD RUN SURVEYS OR PROPERTY RECORDS.
- 25. PVC PRESSURE SEWER PIPE 12" AND SMALLER NOMINAL PIPE SIZE DIAMETER SHALL CONFORM TO ASTM D2241, PVC 1120 (12454-B); SDR 21.
- 26. ALL PRESSURE SEWER PIPE JOINTS AND FITTING JOINTS SHALL BE RESTRAINED.
- 27. CONTRACTOR SHALL AT ALL TIMES MAINTAIN A SAFE AND DRY EXCAVATION. AT A MINIMUM THAT INCLUDES SHEETING AND SHORING FOR TRENCHES IN ACCORDANCE WITH OSHA REGULATIONS AND SUFFICIENT DEWATERING FOR A DRY SUBGRADE.

EXISTING UNDERGROUND UTILITIES COORDINATION NOTES:

- 1. THE LOCATION OF UNDERGROUND UTILITIES AS INDICATED ON PLANS HAS BEEN OBTAINED FROM EXISTING RECORDS. NEITHER THE OWNER OR THE ARCHITECT/ENGINEER ASSUMES ANY RESPONSIBILITY WHATEVER IN RESPECT TO ACCURACY, COMPLETENESS, OR SUFFICIENCY OF THE INFORMATION SHOWN. THERE IS NO GUARANTEE, EITHER EXPRESSED OR IMPLIED THAT THE LOCATIONS, SIZE AND TYPE OF MATERIALS OF EXISTING UNDERGROUND UTILITIES INDICATED ARE REPRESENTATIVE OF THOSE TO BE ENCOUNTERED DURING CONSTRUCTION. IT SHALL BE THE CONTRACTOR'S RESPONSIBILITY TO DETERMINE THE ACTUAL LOCATION OF ALL SUCH UTILITIES, INCLUDING SERVICE CONNECTIONS TO UNDERGROUND UTILITIES. PRIOR TO CONSTRUCTION, THE CONTRACTOR SHALL NOTIFY THE OWNER OF HIS OPERATIONAL PLANS. IN THE EVENT OF AN UNEXPECTED UTILITY INTERFERENCE DURING CONSTRUCTION, THE CONTRACTOR SHALL IMMEDIATELY NOTIFY THE OWNER. ANY SUCH MAINS AND/OR SERVICES DISTURBED BY THE CONTRACTOR'S OPERATIONS SHALL BE RESTORED IMMEDIATELY AT HIS EXPENSE.
- 2. PRIOR TO PERFORMING ANY EXCAVATION GREATER THAN 6 INCHES, THE CONTRACTOR SHALL COORDINATE WITH KENT COUNTY DEPARTMENT OF PUBLIC WORKS AND ALL PRIVATE UTILITY COMPANIES TO DETERMINE THE LOCATION OF UNDERGROUND UTILITY LINES. THE CONTRACTOR SHALL BE RESPONSIBLE FOR COORDINATING WITH ALL ORGANIZATIONS THAT CONTROL EXISTING UNDERGROUND UTILITIES IN THE CONSTRUCTION AREA OR WOULD BE AFFECTED BY CONSTRUCTION WORK AROUND THE EXISTING UTILITIES.
- 3. THE CONTRACTOR SHALL NOT START EXCAVATION UNTIL ALL UTILITY LINE LOCATIONS HAVE BEEN STAKED OR OTHERWISE CLEARLY MARKED AND DOCUMENTATION FURNISHED TO THE OWNER. ALL MARKINGS SHALL BE CONSIDERED APPROXIMATE, AND UTILITIES OTHER THAN THOSE SHOWN SHALL BE CONSIDERED TO EXIST.
- 4. THE CONTRACTOR SHALL BE RESPONSIBLE FOR THE DEFINITE LOCATION OF EACH UTILITY WITHIN THE WORK AREA. CARE SHOULD BE EXERCISED DURING EXCAVATION WORK TO AVOID DAMAGING OR DISRUPTING UTILITIES. THE CONTRACTOR SHALL BE RESPONSIBLE FOR REPAIRING (AT CONTRACTOR'S EXPENSE) DAMAGE TO ANY UTILITY CAUSED BY THE
- 5. WHERE EXISTING UNDERGROUND UTILITIES OR OTHER CONSTRUCTION ARE EXPECTED TO BE IN PROXIMITY TO PROPOSED CONSTRUCTION, OR WHEN APPROACHING EXISTING UTILITIES OR STRUCTURES FOR CONNECTIONS, THE CONTRACTOR SHALL DIG TEST PITS TO DETERMINE THE EXACT LOCATION AND INVERTS OF THE EXISTING UTILITY TO ALLOW FOR POSSIBLE CHANGES TO THE PROPOSED UTILITY IN LINE AND/OR GRADE. THE CONTRACTOR SHALL ALSO DIG TEST PITS IN THE LOCATION OF THE PROPOSED CONNECTIONS TO EXISTING UTILITIES AND SHALL MAKE ALL MEASUREMENTS NECESSARY TO ENSURE PROPER CONNECTION. ANY NECESSARY CHANGES IN LINE OR GRADE OF WORK CAUSED BY FAILURE TO TAKE SUCH PRECAUTIONS SHALL BE AT THE EXPENSE OF THE CONTRACTOR.
- 6. WHEN IT IS NECESSARY TO EXCAVATE NEAR OR INTERFERE WITH ANY SEWER LINE, WATER SERVICES, DRAIN PIPE, CATCH BASIN, CULVERT, OR OTHER STRUCTURES, THE CONTRACTOR SHALL MAINTAIN THE SAME IN WORKING ORDER AND SHALL REPAIR AND MAKE GOOD ANY DAMAGE DONE DURING THE PROGRESS OF THE WORK.
- V. WHERE EXISTING UTILITIES CROSS THE TRENCH EXCAVATION, THEY SHALL BE ADEQUATELY SUPPORTED AND PROTECTED FROM DAMAGE DUE TO CONSTRUCTION. ALL METHODS FOR SUPPORTING AND MAINTAINING THESE UTILITIES SHALL BE SUBJECT TO REVIEW BY OWNER. CARE SHALL BE TAKEN TO ENSURE THAT THE EXISTING UTILITY GRADES AND ALIGNMENT ARE MAINTAINED AND THE PIPE JOINTS ARE NOT DISTURBED. BACKFILL SHALL BE CAREFULLY PLACED AND TAMPED TO PREVENT DAMAGE OR FUTURE SETTLEMENT. ANY DAMAGE OR MISALIGNMENT OF THE UTILITIES DUE TO CONSTRUCTION OR SETTLEMENT SHALL BE REPAIRED BY THE CONTRACTOR AT THE CONTRACTOR'S EXPENSE.
- 8. ANY UNPROTECTED CABLE (DIRECT BURIED) ENCOUNTERED THAT IS VERIFIED AS NOT ABANDONED IN PLACE SHALL BE PROTECTED. THE UTILITY OWNER MAY DIRECT THE CABLE BE PLACED IN SPLIT DUCT OF APPROPRIATE SIZE AND CONCRETE ENCASED THROUGH THE AREA OF CONSTRUCTION. CONTRACTOR SHALL TAKE ALL REASONABLE MEASURES TO AVOID HAVING TO CUT AND SPLICE DIRECT BURIED CABLE. THE CONTRACTOR SHALL NOTE SPLIT DUCT PORTIONS ON AS-BUILTS.
- 9. ALL EXCESS EXCAVATED MATERIALS SHALL BE DISPOSED OF OFF COUNTY/STATE PROPERTY EXCEPT FOR CONTAMINATED SOILS OR LIQUIDS. ALL CONTAMINATED SOILS AND LIQUIDS SHALL BE TRANSPORTED TO AN APPROVED RECEIVING SITE AS DIRECTED BY THE ENGINEER, FOR FINAL DISPOSITION.
- 10. INTERRUPTION OF EXISTING UTILITIES SHALL BE IN ACCORDANCE WITH THE SPECIFICATIONS AND/OR AT THE DIRECTION OF THE UTILITY OWNER/S.




SEAL



VANDEMARK & LYNCH, INC.

4305 MILLER ROAD WILMINGTON, DE 19802 302.764.7635

ENGINEERS - PLANNERS - SURVEYORS

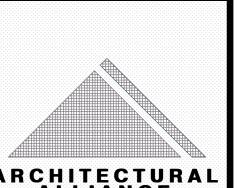

ALLIANCE

ARCHITECTURE • PLANNING INTERIOR DESIGN • GRAPHIC ARTS

DELAWARE
1309 VEALE ROAD
SUITE 22
WILMINGTON, DE 19810
302.478.3777

PENNSYLVANIA 256 EAGLEVIEW BLVD SUITE 194

EXTON, PA 19341

610.640.9000

PROJECT NAME

THE REESE APARTMENTS

8093 S. Dupont Hwy, Felton, DE 19943 Kent County

1	8.31.23	PER KENT COUNTY PUBLIC WORKS
2	10.2.23	PER KENT COUNTY PUBLIC WORKS
MARK	DATE	DESCRIPTION
DE\ // O	IONIO	

REVISIONS

PROJECT NO: 25723.00
DRAWN BY: DJS
CHK'D BY: SHR
DATE: 3/21/23

DRAWING NAME

SANITARY SEWER PLAN CONST. NOTES AND DETAIL

DRAWING NUMBER

CP1 10

SCALE: AS SHOWN
SHEET 10 OF 10

2" TYPE "C" BITUMINOUS CONCRETE

10'-0"

MAX. CROSS SLOPE 1.5%

FINISHED GRADE

6" GRADED AGGREGATE BASE COURSE TYPE "B"

COMPACTED SUBGRADE

TYPICAL DRIVEWAY SECTION

NOT TO SCALE

SANITARY SEWER PLAN
CONSTRUCTION NOTES AND DETAILS
REESE APARTMENTS
8093 SOUTH DUPONT HIGHWAY

NORTH MURDERKILL HUNDRED KENT COUNTY
DELAWARE

SCALE: AS SHOWN MARCH 21, 2023

50 0 25 50 100 20

GRAPHIC SCALE (FEET)