

SHEET NOTES:

- SERVICE EQUIPMENT CABINET, SIZED AS INDICATED SEE SPECIFICATIONS.
- 48" TWO LAMP LED FIXTURE. MOUNT TOWARDS FRONT OF CABINET.
- TERMINATE CONDUIT 4" INSIDE WET WELL. PROVIDE INSULATED TYPE BUSHING & STAINLESS STEEL CABLE STRAIN RELIEF GRIP.
- (4) LIGHT SWITCH FOR INTERIOR CABINET LIGHTS.
- 5 DUPLEX G.F.I. RECEPTACLE.
- 1 $1/2" \times 3"$ ALUMINUM BASE CHANNELS, FULL LENGTH FRONT AND BACK. PROVIDE FINISH TO MATCH CABINET.
- (7) WHITE FINISHED INTERIOR MOUNTING BACK PANEL.
- 8 CONDUIT SEALING BUSHINGS WITH GLAND LOCKING COLLAR, OZ GEDNEY TYPE CS BG, OR EQUAL.
- 9 COOLING AIR FAN PACKAGE: 560 CFM, 1650 RPM, 115V., 1¢, 35 WATTS COMPLETE W/STAINLESS STEEL GRILLE, ALUMINUM AIR FILTER, COMPOSITE AIR PLENUM & COMPOSITE FINGER GUARD. FURNISH HOFFMAN CATALOG NO. A-PA10AXFN, OR EQUAL.
- WITH INTEGRAL CABLE(S) COMPLETE TO JB.
- (11) AIR EXHAUST GRILL ASSEMBLY: CONSISTING OF 11.62" x 13.00" STAINLESS STEEL GRILLE, ALUMINUM AIR FILTER & MOUNTING HARDWARE. FURNISH HOFFMAN CATALOG NO. A-EXGR10, OR EQUAL.
- COOLING AIR FAN THERMOSTAT: ADJUSTABLE RANGE OF 70° F TO 140° F, ANODIZED ALUMINUM HOUSING, RATED 12.5 AMPS AT 120VOLT. FURNISH HOFFMAN CATALOG NO. D-TEMA, OR EQUAL.
- HEATER: 400 WATTS, 115V., 1¢, ANODIZED ALUMINUM HOUSING WITH INTEGRAL THERMOSTAT & FAN. FURNISH HOFFMAN CATALOG NO. D-AH4001B., OR EQUAL.
- $\widehat{\text{(14)}}$ 3/4" DIA. x 10" LONG "L" STAINLESS STEEL ANCHOR BOLT. ASSEMBLY, FRONT AND BACK, SET IN CONCRETE PAD.
- (15) SEE PANEL SCHEDULE, SHEET NO. E-12 FOR BRANCH BREAKER SIZES & USAGE.
- (16) 4 #8 & 1 #10 GND. 1" C.
- (17) 3 #8 & 1 #10 GND. 3/4" C.
- (18) 1 #6 3/4" C. TO GROUND GRID.
- (19) 3 #3 & 1 #8 GND. 1 1/4" C.
- (20) 3 #10 & 1 #10 GND. 3/4" C.
- 21) 2 #8 & 1 #8 GND.
- 22) SECURE TO CABINET UTILIZING VERTICAL CHANNEL SUPPORTS AS DESCRIBED IN NOTE 3, SHEET NO. E-1.
- 23) 5 #14 & 1 #12 GND. 3/4" C. TO PCP.
- PUMP CONTROL PANEL (PCP) SEE SHEETS NO. E-3, THRU E-11, & SPECIFICATION SECTIONS 13318, 13320 AND 13440.
- (25) REFER TO DETAIL, SHEET NO. E-1.
- 12" HIGH X 8" DEEP X 12" WIDE NEMA 4X JUNCTION BOX, STAINLESS STEEL CONSTRUCTION WITH HINGED LOCKABLE COVER, INTERIOR BACKPLATE WITH WHITE FINISH & SQUARE D TERMINAL BLOCKS FOR ALL INCOMING & OUT GOING WIRING
- (27) 3/C #18 SHIELDED CABLE IN 3/4"C. TO PCP.
- (28) 4 #14 & 1 #12 GND.-3/4"C. TO PCP.
- (29) SEE DETAIL, SHEET NO. E-12.
- (30) 1-1/4"C. W/ANTENNA CABLE TO SCADA ANTENNA.
- (31) 3#14 & 1#12 GND. 3/4"C. TO PCP.
- (32) LIGHT SWITCH FOR AREA SITE LIGHT. (33) 1 #1/0 TO GROUND GRID.

SCALE: 3/4" = 1'-0"

PROFESSIONAL **CERTIFICATION:** I HEREBY CERTIFY THAT THESE DOCUMENTS WERE PREPARED OR APPROVED BY ME, AND THAT I AM A DULY LICENSED PROFESSIONAL ENGINEER UNDER THE LAWS OF THE STATE OF DELAWARE, LICENSE No 17123, EXPIRATION


DATE: 06/30/2026.

Georgetown, DE 199 T. 302.297.92 3003 Merritt Mill Ro Salisbury, MD 2180 T. 410.572.883 ww.solutionsipem.com Copyright © 202

Integrated Planning

Engineering & Management, LLC

IIII THE CENSON No. 17123 Date: 8/6/2024

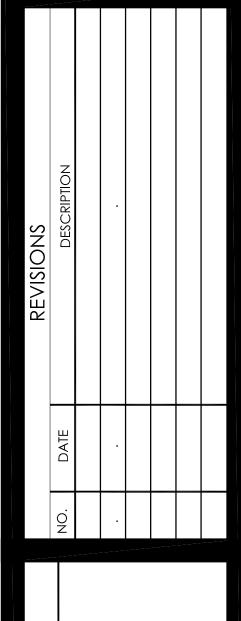

RD

Sheet No.:


G21074-PUMPSTAITON

File Name:

"THIS DRAWING AND THE DESIGN AND CONSTRUCTION FEATURES DISCLOSED ARE PROPRIETARY TO GIPE ASSOCIATES, INC. AND SHALL NOT BE ALTERED OR REUSED IN WHOLE OR IN PART WITHOUT THE EXPRES WRITTEN PERMISSION OF GIPE

ASSOCIATES, INC. Copyright © 2024"

Gipe Associates, Inc. CONSULTING ENGINEERS 1220 East Joppa Road, Suite 102 Towson, Maryland 21286
Baltimore, Maryland
Easton, Maryland
W.O.# 24039

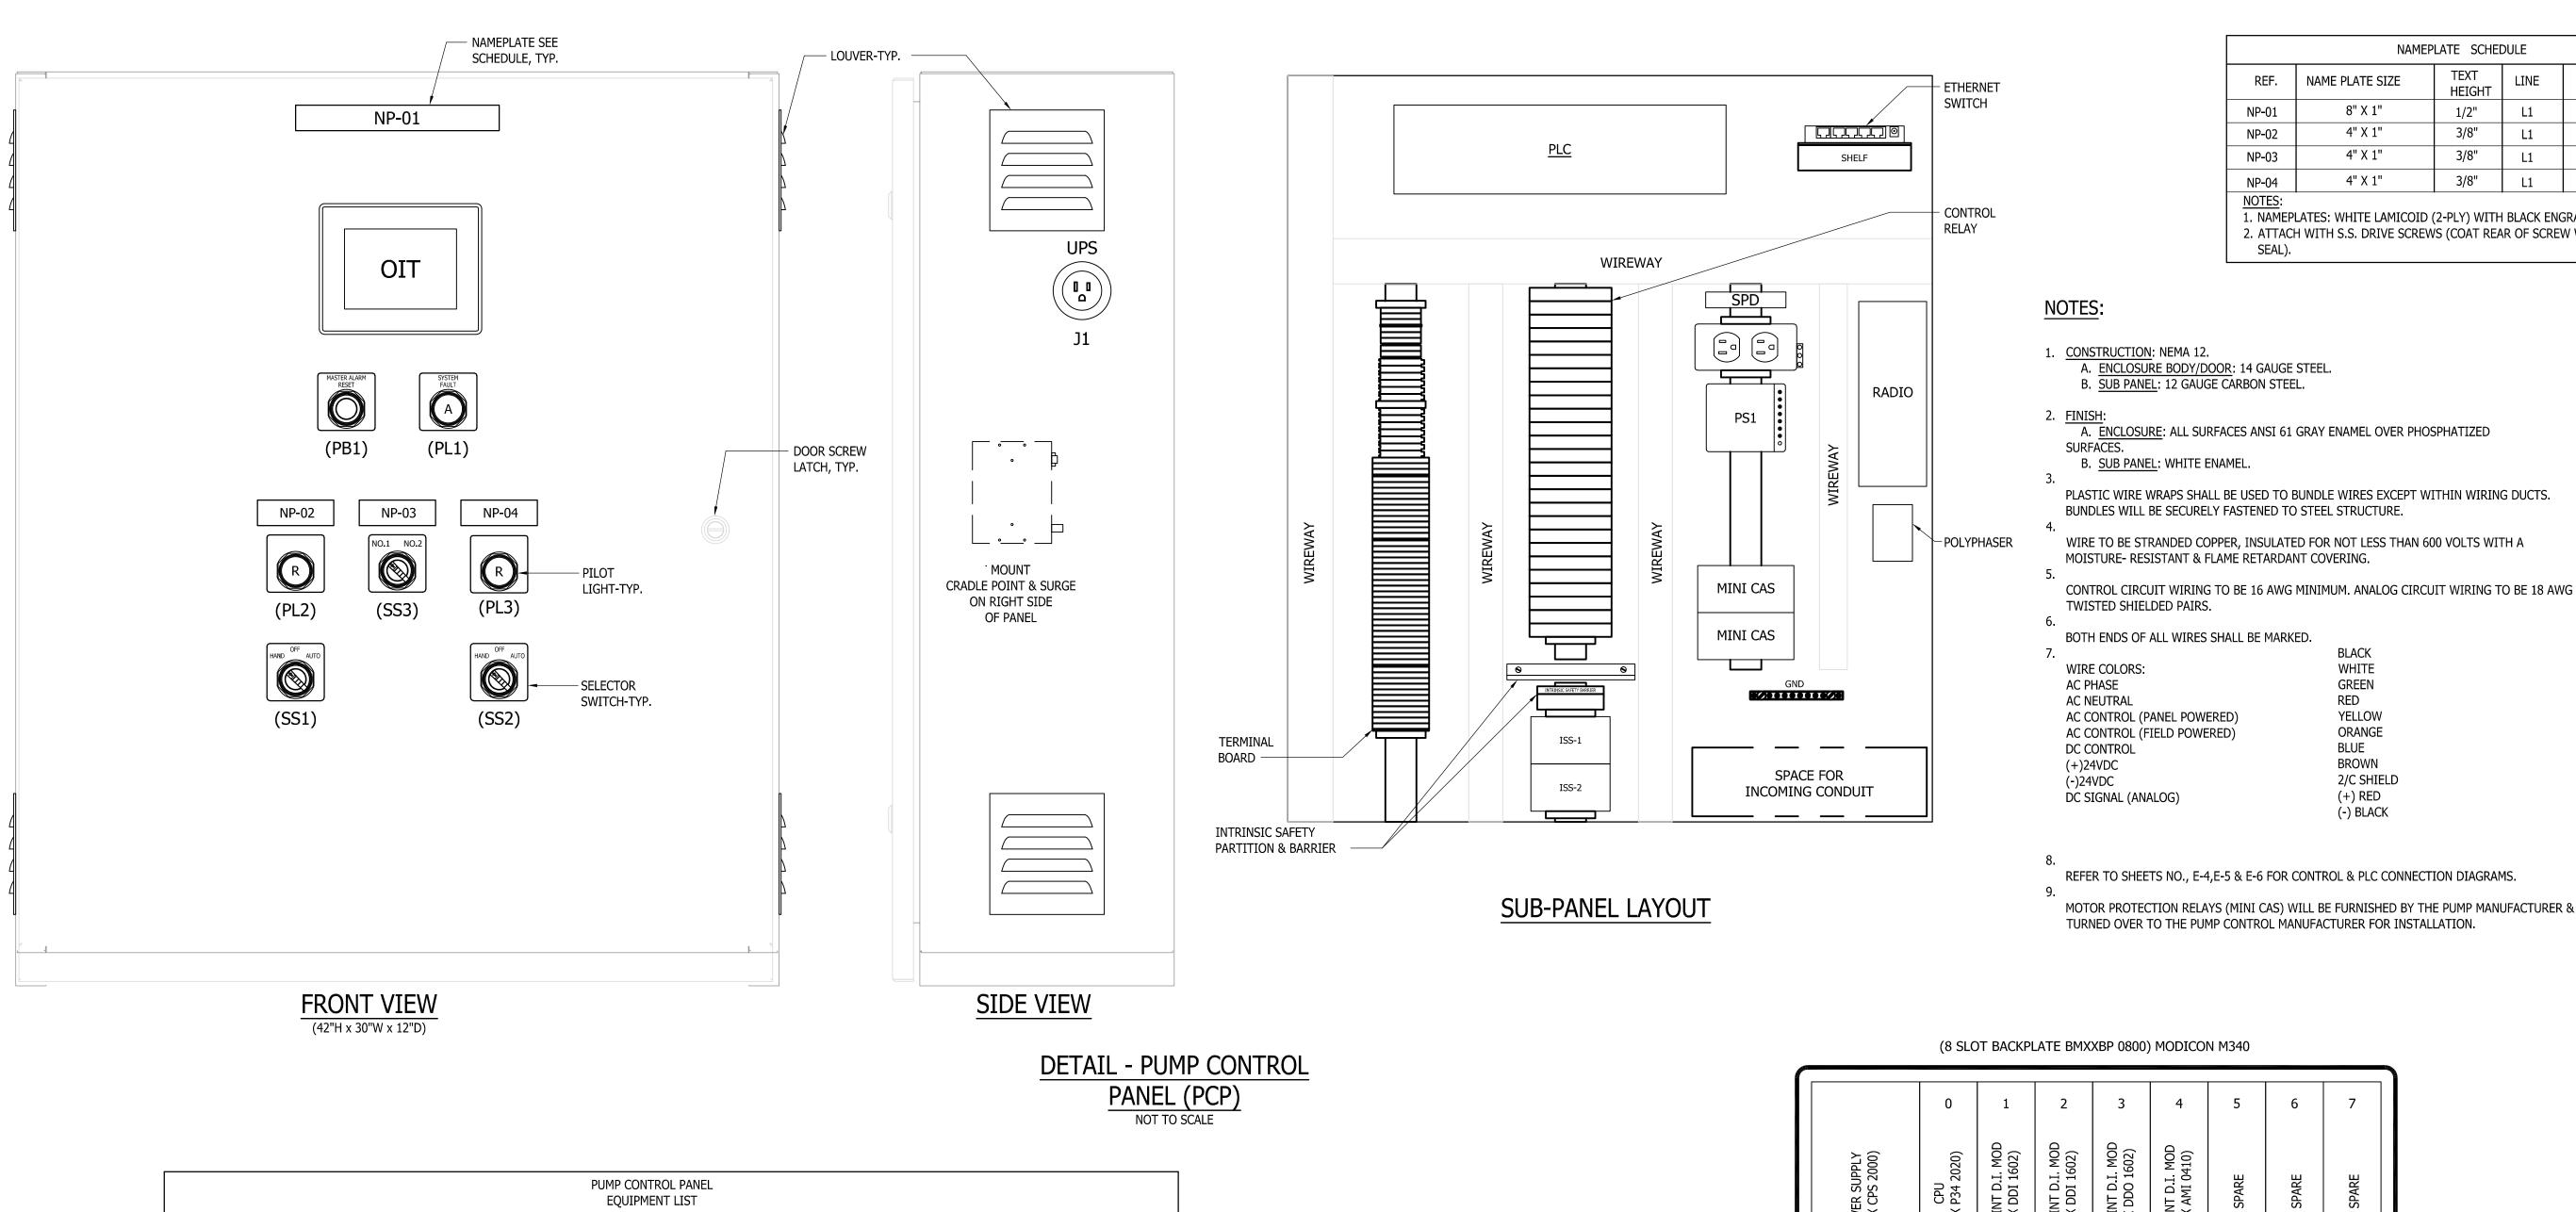

PART DESIGN.

UPS

CR....

OIT

PS1

PL2, PL3

ISB1

QTY.

MANUFACTURER

1 SUB PANEL 38"H x 28.5"W

1 SURGE PROTECTION DEVICE

2 M340 16PT. 24VDC D.I. MODULE 1 M340 16PT. 24VDC D.O. MODULE

1 UNINTERRUPTIBLE POWER SUPPLY, 500VA

1 COLOR TOUCHSCREEN OIT, 5.7", 24VDC

4 20 PIN REMOVABLE TERMINAL BLOCK

26 DPDT RELAY, 24VDC COIL, 2 FORM "C" CONTACTS

1 DPDT RELAY, 120VAC COIL, 2 FORM "C" CONTACTS

6 120VAC FUSE TERMINAL W/BLOWN FUSE INDICATOR

8 24VDC FUSE TERMINAL w/BLOWN FUSE INDICATOR

1 2-POSITION SELECTOR SWITCH, 2 N.O./2 N.C. CONTACTS

1 PILOT LIGHT, NAMEPLATE ENGRAVED "SYSTEM FAULT"

1 PUSH BUTTON, NAMEPLATE ENGRAVED "MASTER ALARM RESET"

1 DATA-LINC 900 MHZ-YAGI ANTENNA w/MOUNTING BRACKET

2 3-POSITION SELECTOR SWITCH, NAMEPLATE ENGRAVED "HAND/OFF/AUTO"

1 2-POSITION SELECTOR SWITCH, NAMEPLATE ENGRAVED "P1 SELECTED P2"

1 M340 POWER SUPPLY 120 VAC, 20W
1 M340 PROCESSOR w/MODBUS PORT AND ETHERNET PORT

4 LOUVER PLATE KIT

1 M340 8 SLOT RACK

1 M340 4PT. A.I. MODULE

1 24VDC POWER SUPPLY

10 SINGLE LEVEL TERMINAL

48 DOUBLE LEVEL TERMINAL

10 END STOP, CLEAR

USE w/SS1,SS2,SS3 3 1 N.O./1 N.C. CONTACT BLOCK

PL1 1 PILOT LIGHT, AMBER
PL2, PL3 2 PILOT LIGHT, RED

1 20A CIRCUIT BREAKER

USE w/PL2, PL3 2 PILOT LIGHT, NAMEPLATE ENGRAVED "RUN"

3 SINGLE LEVEL END BARRIER

4 DOUBLE LEVEL END BARRIER

1 DIN RAIL MOUNTED RECEPTACLE

SS1,SS2,SS3,SS5 3 3-POSITION SELECTOR SWITCH, 2 N.O./2 N.C. CONTACTS

1 PUSH BUTTON, 1 N.O./1 N.C. CONTACT

2 INTRINSICALLY SAFE SWITCH

2 FLOAT SWITCH w/40 FT. CABLE

1 INTRINSIC SAFETY BARRIER

1 PHASE MONITORING RELAY

1 GROUND BAR

RADIO 1 DATA-LINC

1 RJ45 FEEDTHRU RECEPTACLE/D-SIZED

LT-1 1 LEVEL TRANSDUCER 0-5 PSIG w/SURGE PROTECTOR PSI

5 FUSE, 2A

F4.5.12-18 9 FUSE, 1A

ENCLOSURE w/MOUNTING PANEL, 42"H x 30"W x 12"D

DESCRIPTION

MANUFACTURER

SCHAEFER'S

SCHAEFER'S

SCHAEFER'S

PHOENIX CONTACT

APC

WEIDMULLER

WEIDMULLER

TELEMECANIQUE

MODICON

MODICON MODICON

MODICON

MODICON

MODICON

MODICON

WOERTZ

PHOENIX CONTACT

PHOENIX CONTACT

WOERTZ

WOERTZ

PHOENIX CONTACT

PHOENIX CONTACT

PHOENIX CONTACT

PHOENIX CONTACT

PHOENIX CONTACT

WOERTZ

WOERTZ

SQUARE D

NEUTRIK

DATA-LINC

SYMCOM

STAHL

MODEL NO.

SPLN1-423012

SPLN1P-4230

SP-VK34

2856812

BE550G

8530631001

8530661001

XBTGT2220

BMX XBP 0800

BMX CPS 2000

BMX P34 2020

BMX DDI 1602

BMX DDO 1602

BMX AMI 0410

BMX FTB 2010

45700K/24S

3046100

3046090

WF520F/2

WF520F/1

3044102

3047028

3044814

3047293

800886

WRO-15STDRGY

WCB-1P-2-20

9001KS11BH2

9001KS43BH2

9001KA1

9001KP1A31

9001KP1R31

9001KN124WP

9001KN160WP

9001KN199WP

9001KN199WP

9001KN199WP

9001KR1BH13

NE8FDP

A-Y11B

ISS-100

9001/01-280-100-101

D167-6


SRM 6230


REFER TO SPECIFICATIONS

REFER TO SPECIFICATIONS

REFER TO SPECIFICATIONS

DATA-LINC

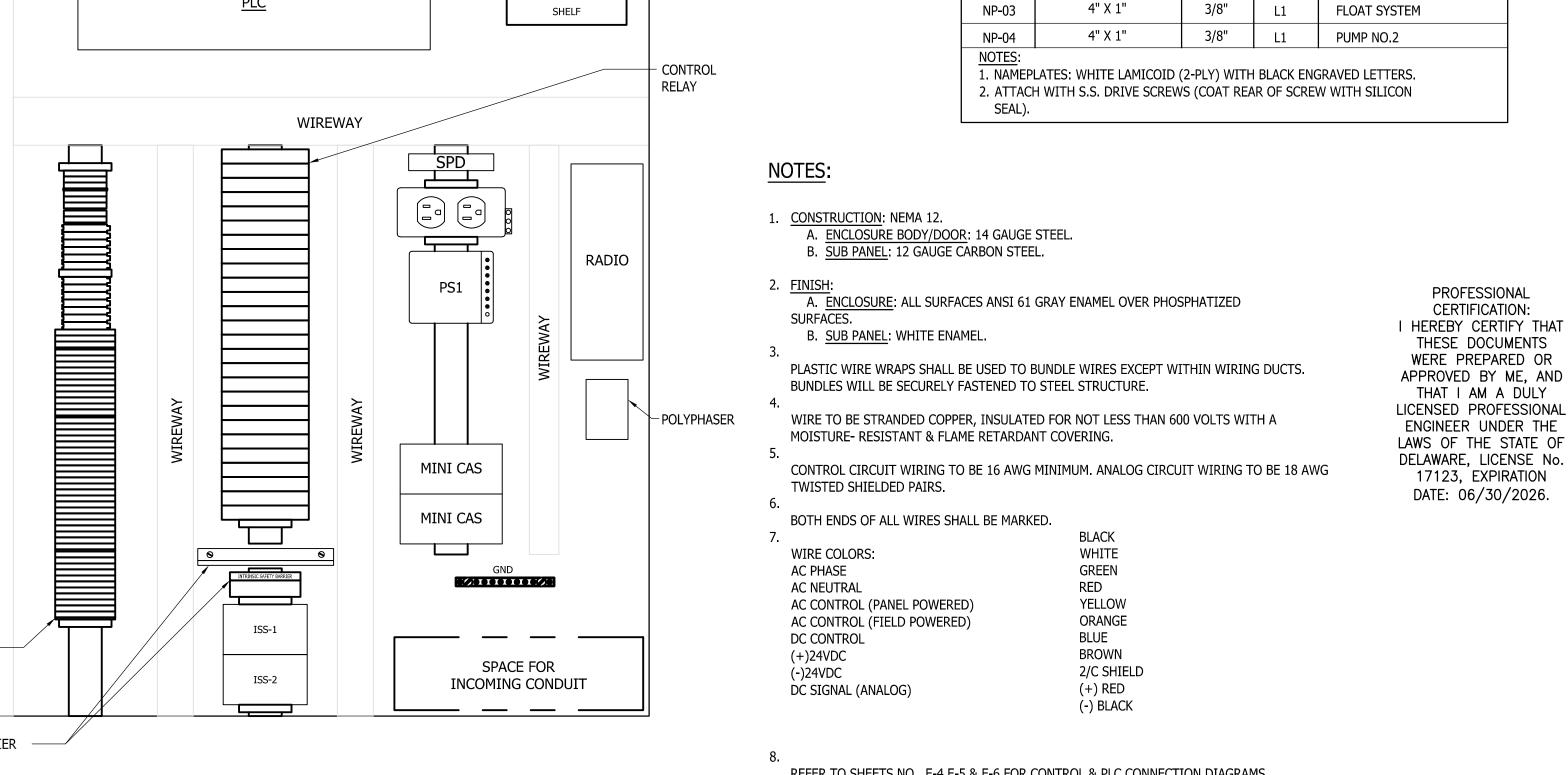

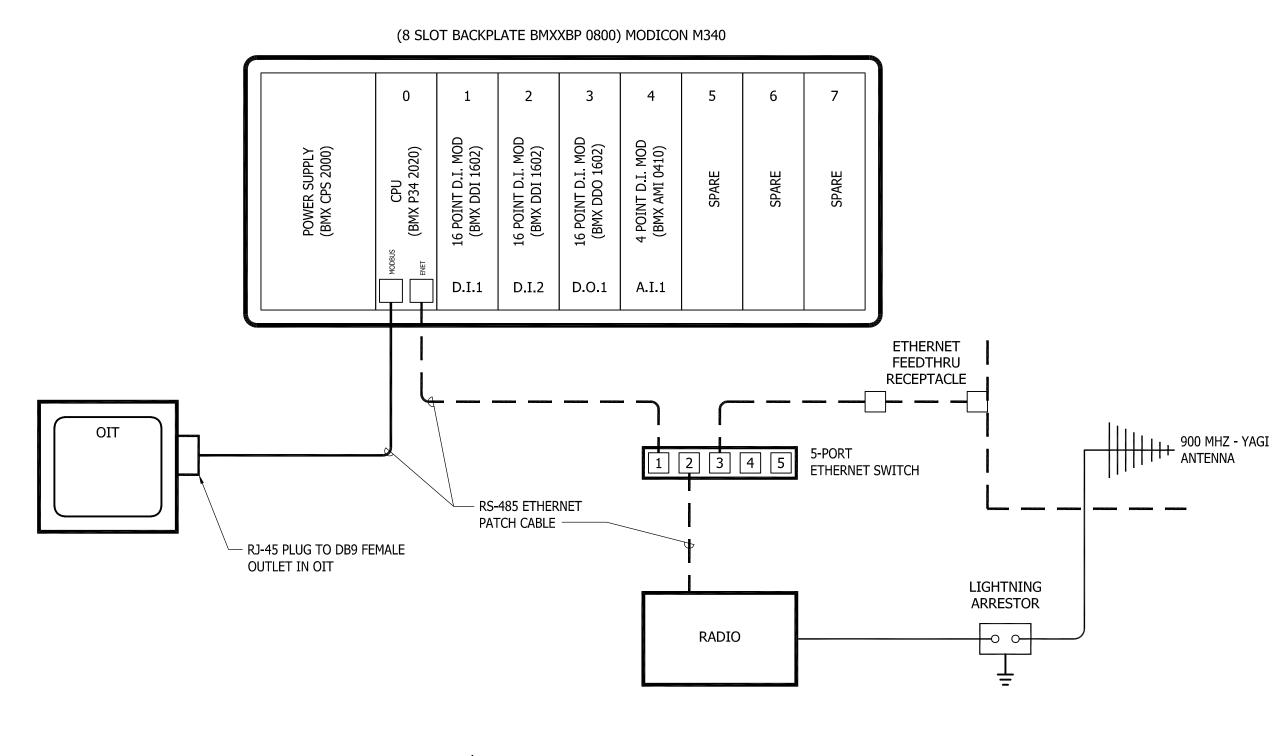

↑ PLC BLOCK DIAGRAM

Gipe Associates, Inc. CONSULTING ENGINEERS 1220 East Joppa Road, Suite 102 Towson, Maryland 21286
Baltimore, Maryland
Easton, Maryland
W.O.# 24039

TEXT

HEIGHT

3/8"

LINE

L1

L1

TEXT

PUMP CONTROL PANEL

PUMP NO.1

ASSOCIATES, INC. Copyright © 2024"

Sheet No.:

File Name: G21074-PUMPSTAITON

"THIS DRAWING AND THE DESIGN AND CONSTRUCTION FEATURES DISCLOSED ARE PROPRIETARY TO GIPE ASSOCIATES, INC. AND SHALL NOT BE ALTERED OR REUSED IN WHOLE OR IN PART WITHOUT THE EXPRES WRITTEN PERMISSION OF GIPE

HASE **ARD** EEW

solutions

Engineering & Management, LLC

ww.solutionsipem.com Copyright © 202

IIII CENS

Date: 8/6/2024


No. 17123

Georgetown, DE 199 T. 302.297.92

3003 Merritt Mill Ro Salisbury, MD 2180

T. 410.572.883

Integrated Planning

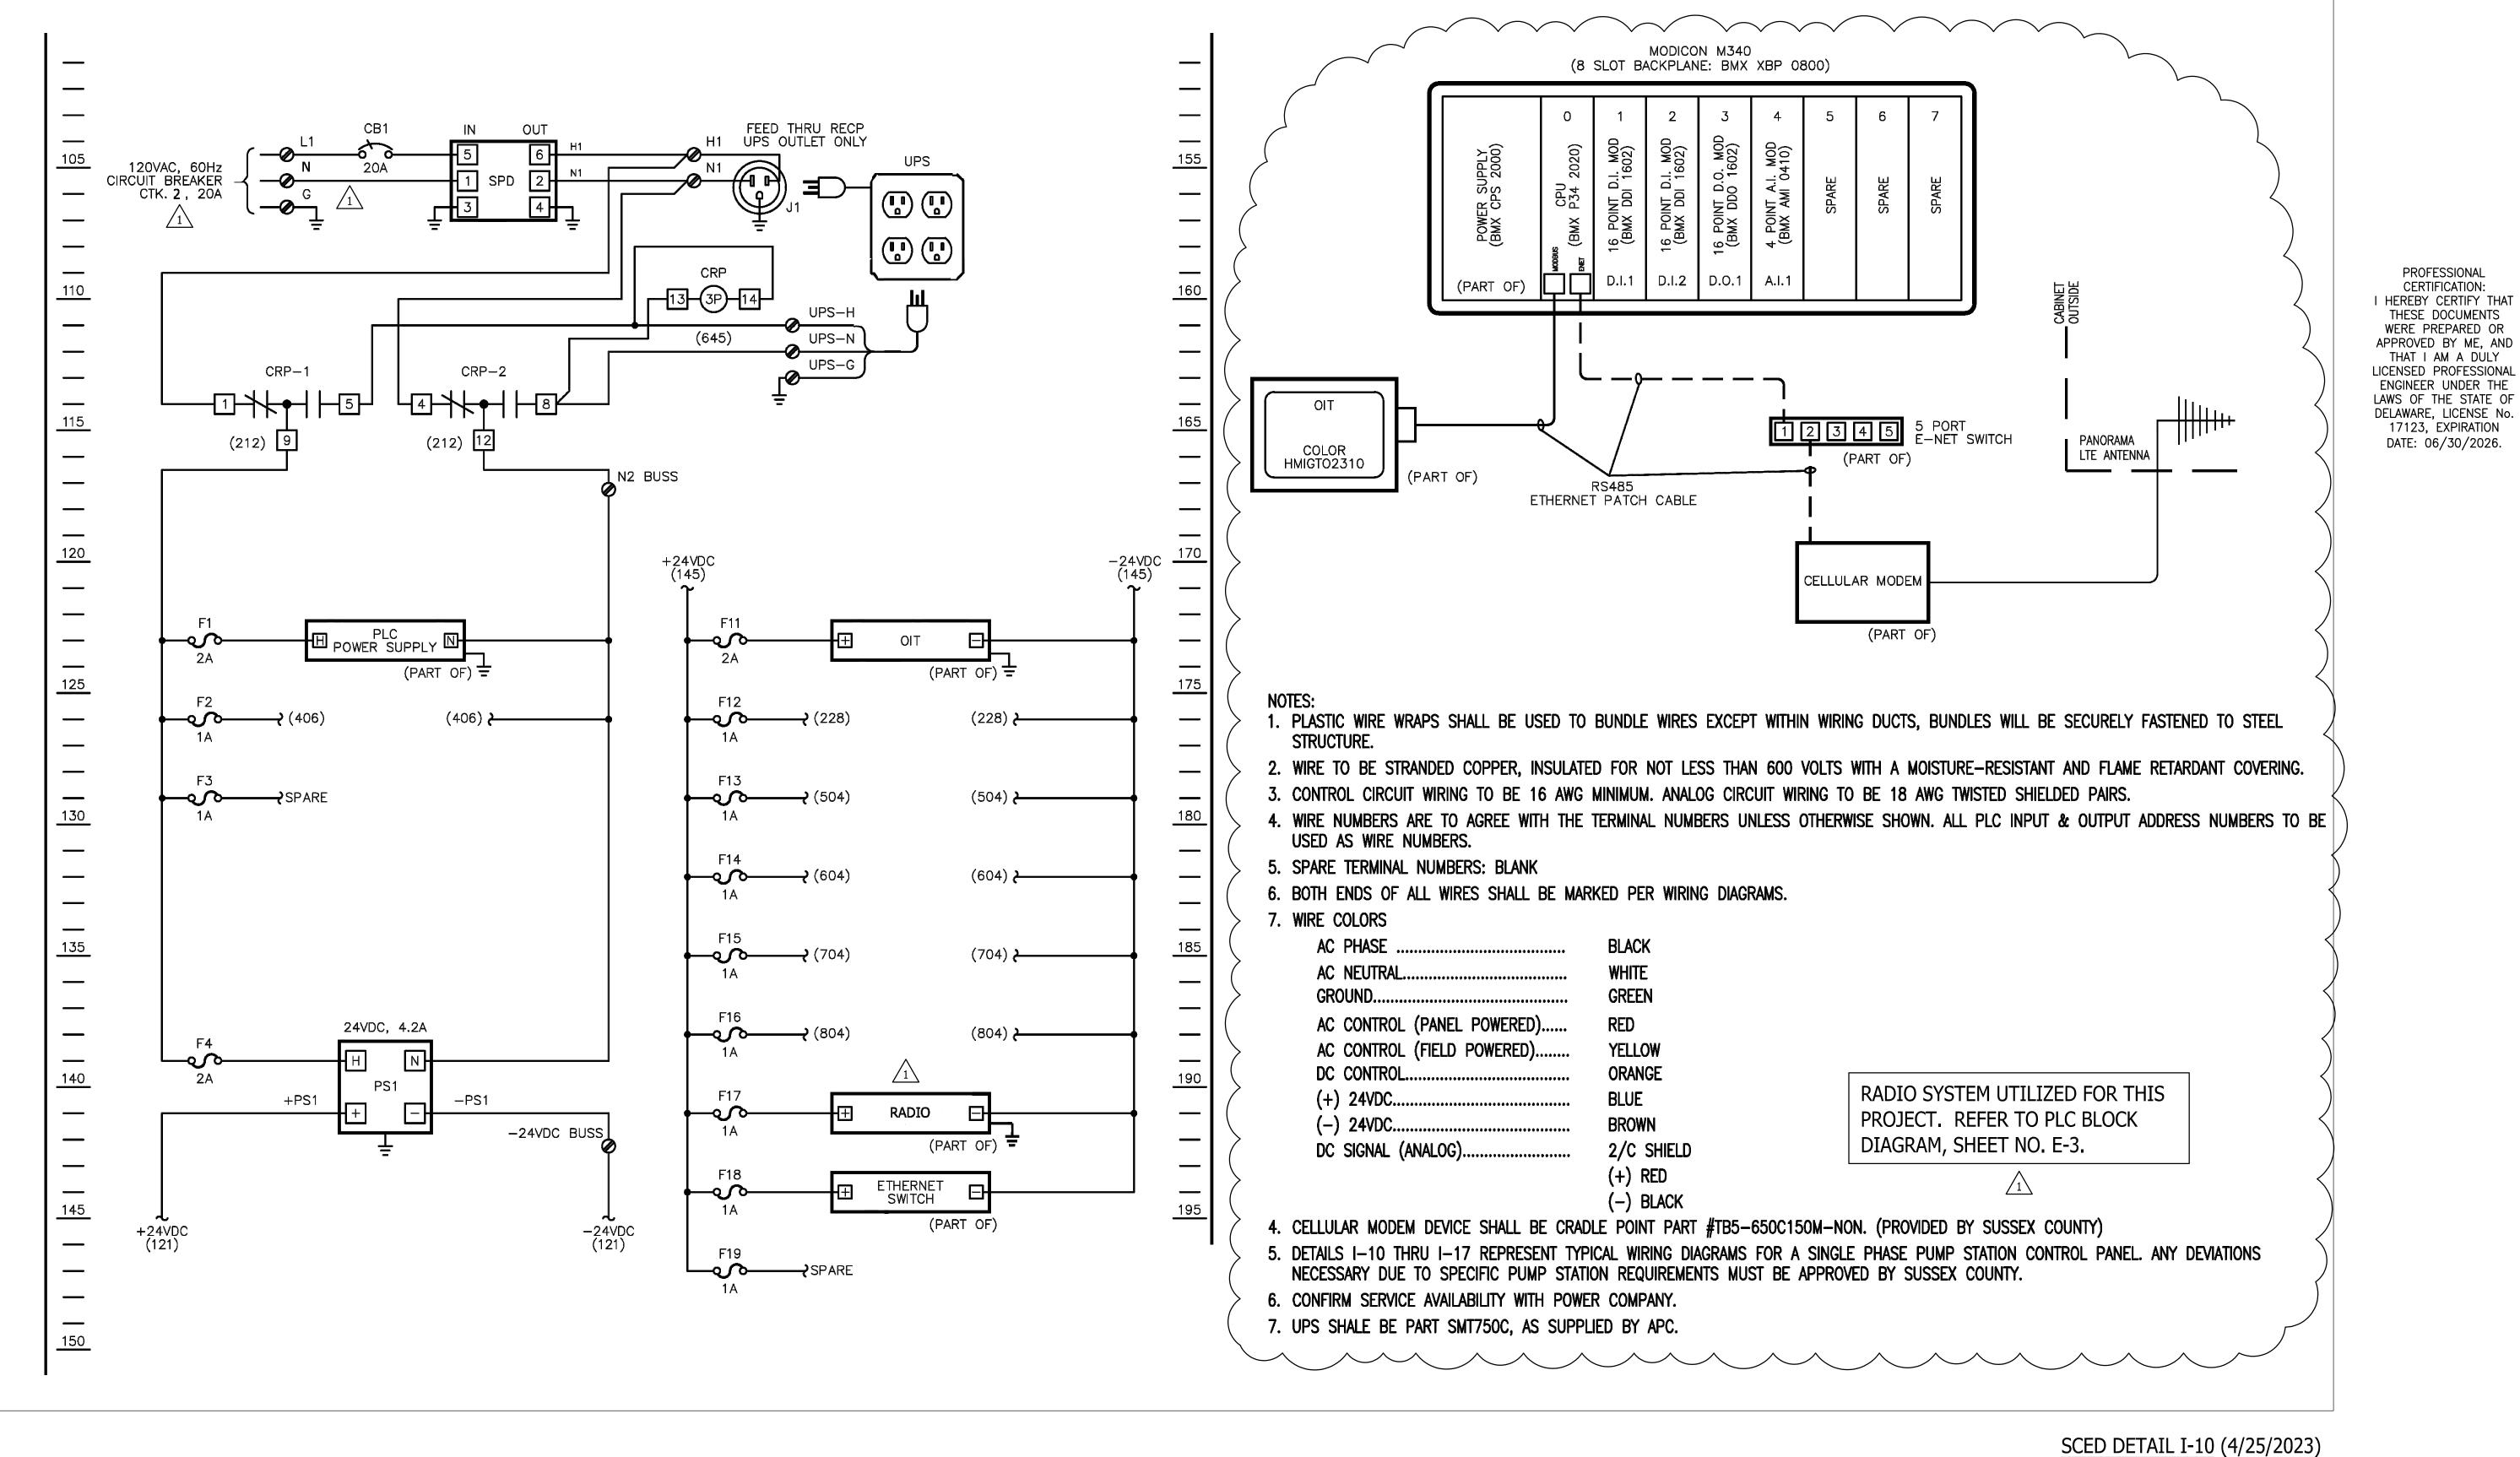

ARD EEW


3003 Merritt Mill Ro Sa**l**isbury, MD 2180 T. 410.572.883

Date: 8/6/2024


Gipe Associates, Inc. CONSULTING ENGINEERS 1220 East Joppa Road, Sulte 102

"THIS DRAWING AND THE DESIGN AND CONSTRUCTION FEATURES DISCLOSED ARE PROPRIETARY TO GIPE ASSOCIATES, INC. AND SHALL NOT BE ALTERED OR REUSED IN WHOLE OR IN PART WITHOUT THE EXPRES WRITTEN PERMISSION OF GIPE ASSOCIATES, INC. Copyright © 2024"

E-4 File Name: G21074-PUMPSTAITON

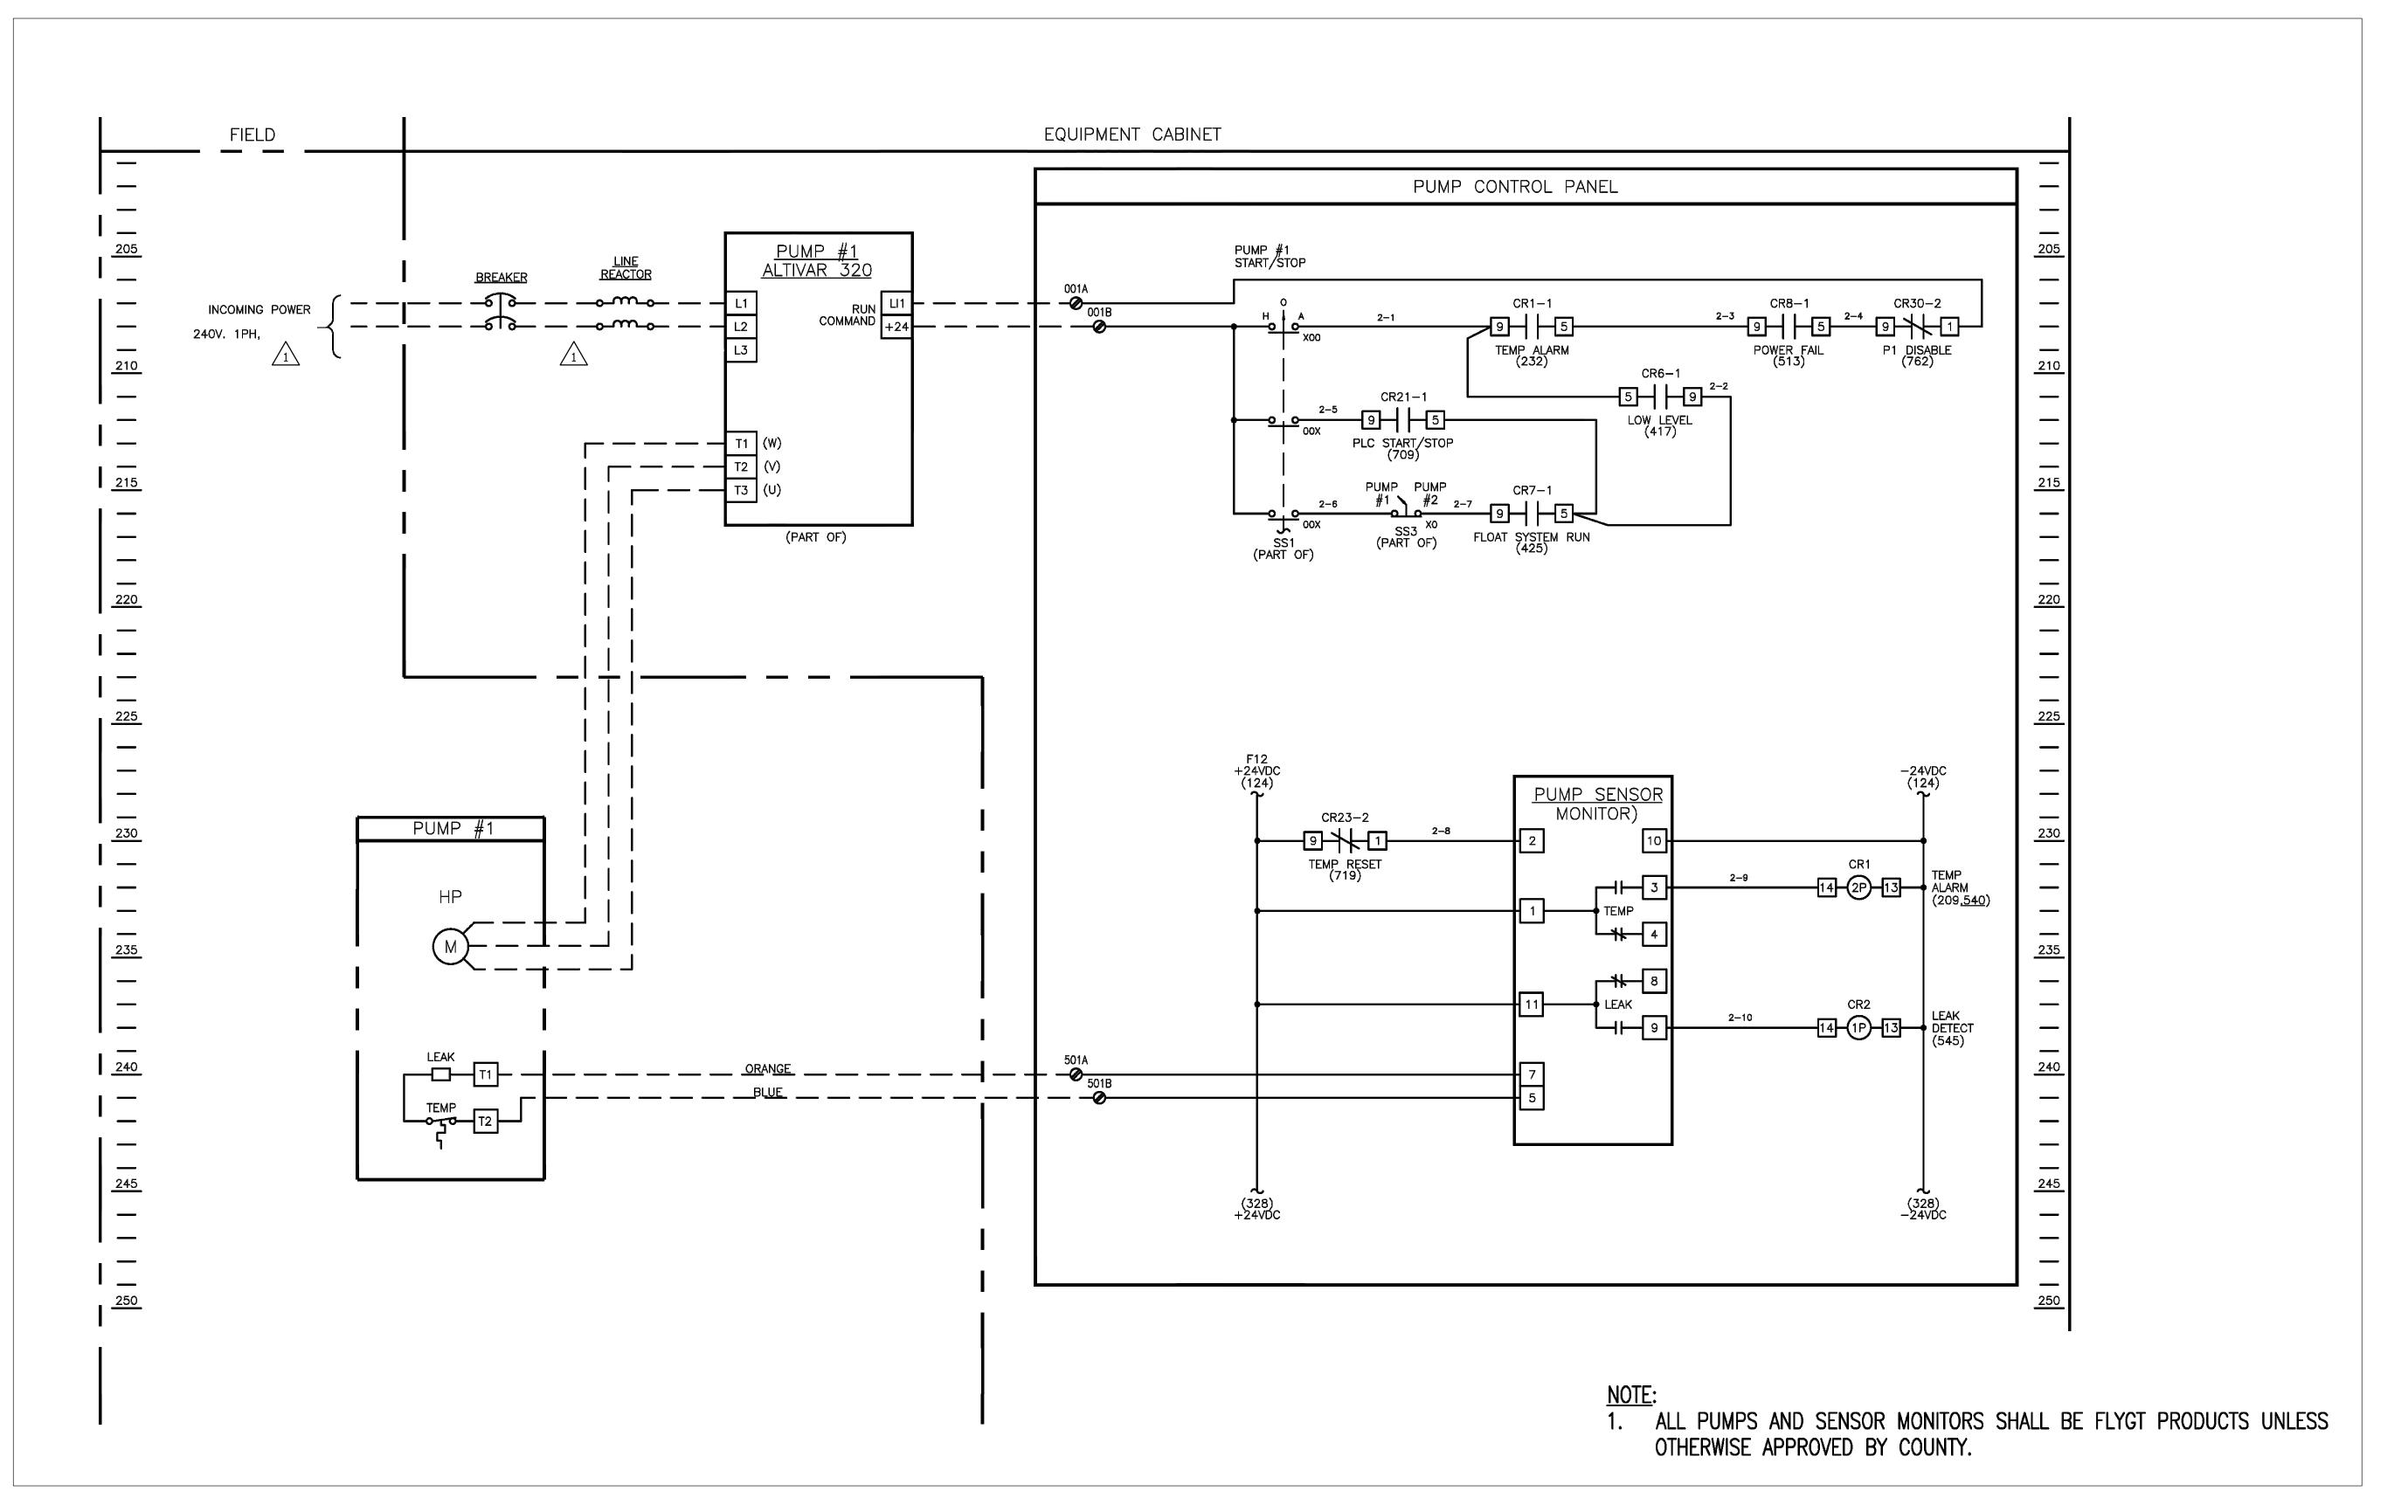

SCED DETAIL I-11 (4/25/2023)

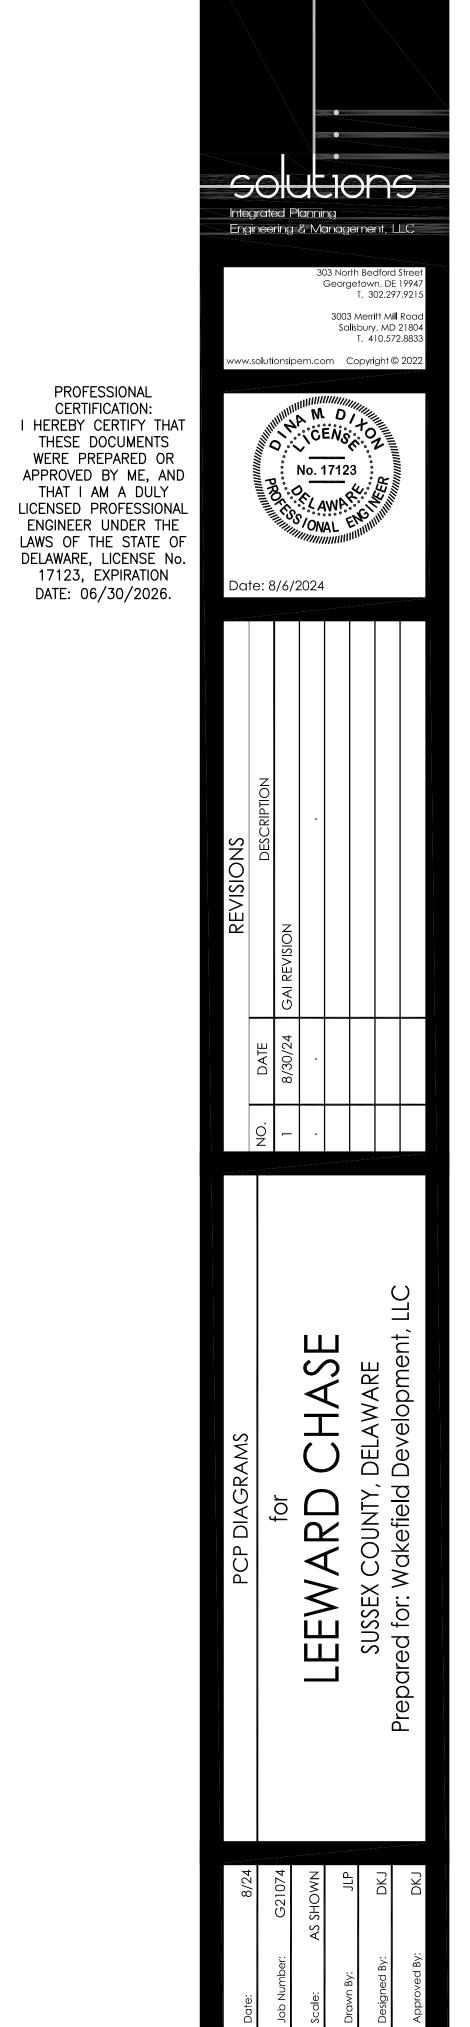


File Name: G21074-PUMPSTAITON


Gipe Associates, Inc.
CONSULTING ENGINEERS

1220 East Joppa Road, Suite 102
Towson, Maryland 21286
Baltimore, Maryland 410.832.2420
Easton, Maryland 410.822.8688
W.O.# 24039

"THIS DRAWING AND THE DESIGN AND CONSTRUCTION FEATURES DISCLOSED ARE PROPRIETARY TO GIPE ASSOCIATES, INC. AND SHALL NOT BE ALTERED OR REUSED IN WHOLE OR IN PART WITHOUT THE EXPRESS WRITTEN PERMISSION OF GIPE ASSOCIATES, INC. Copyright © 2024"

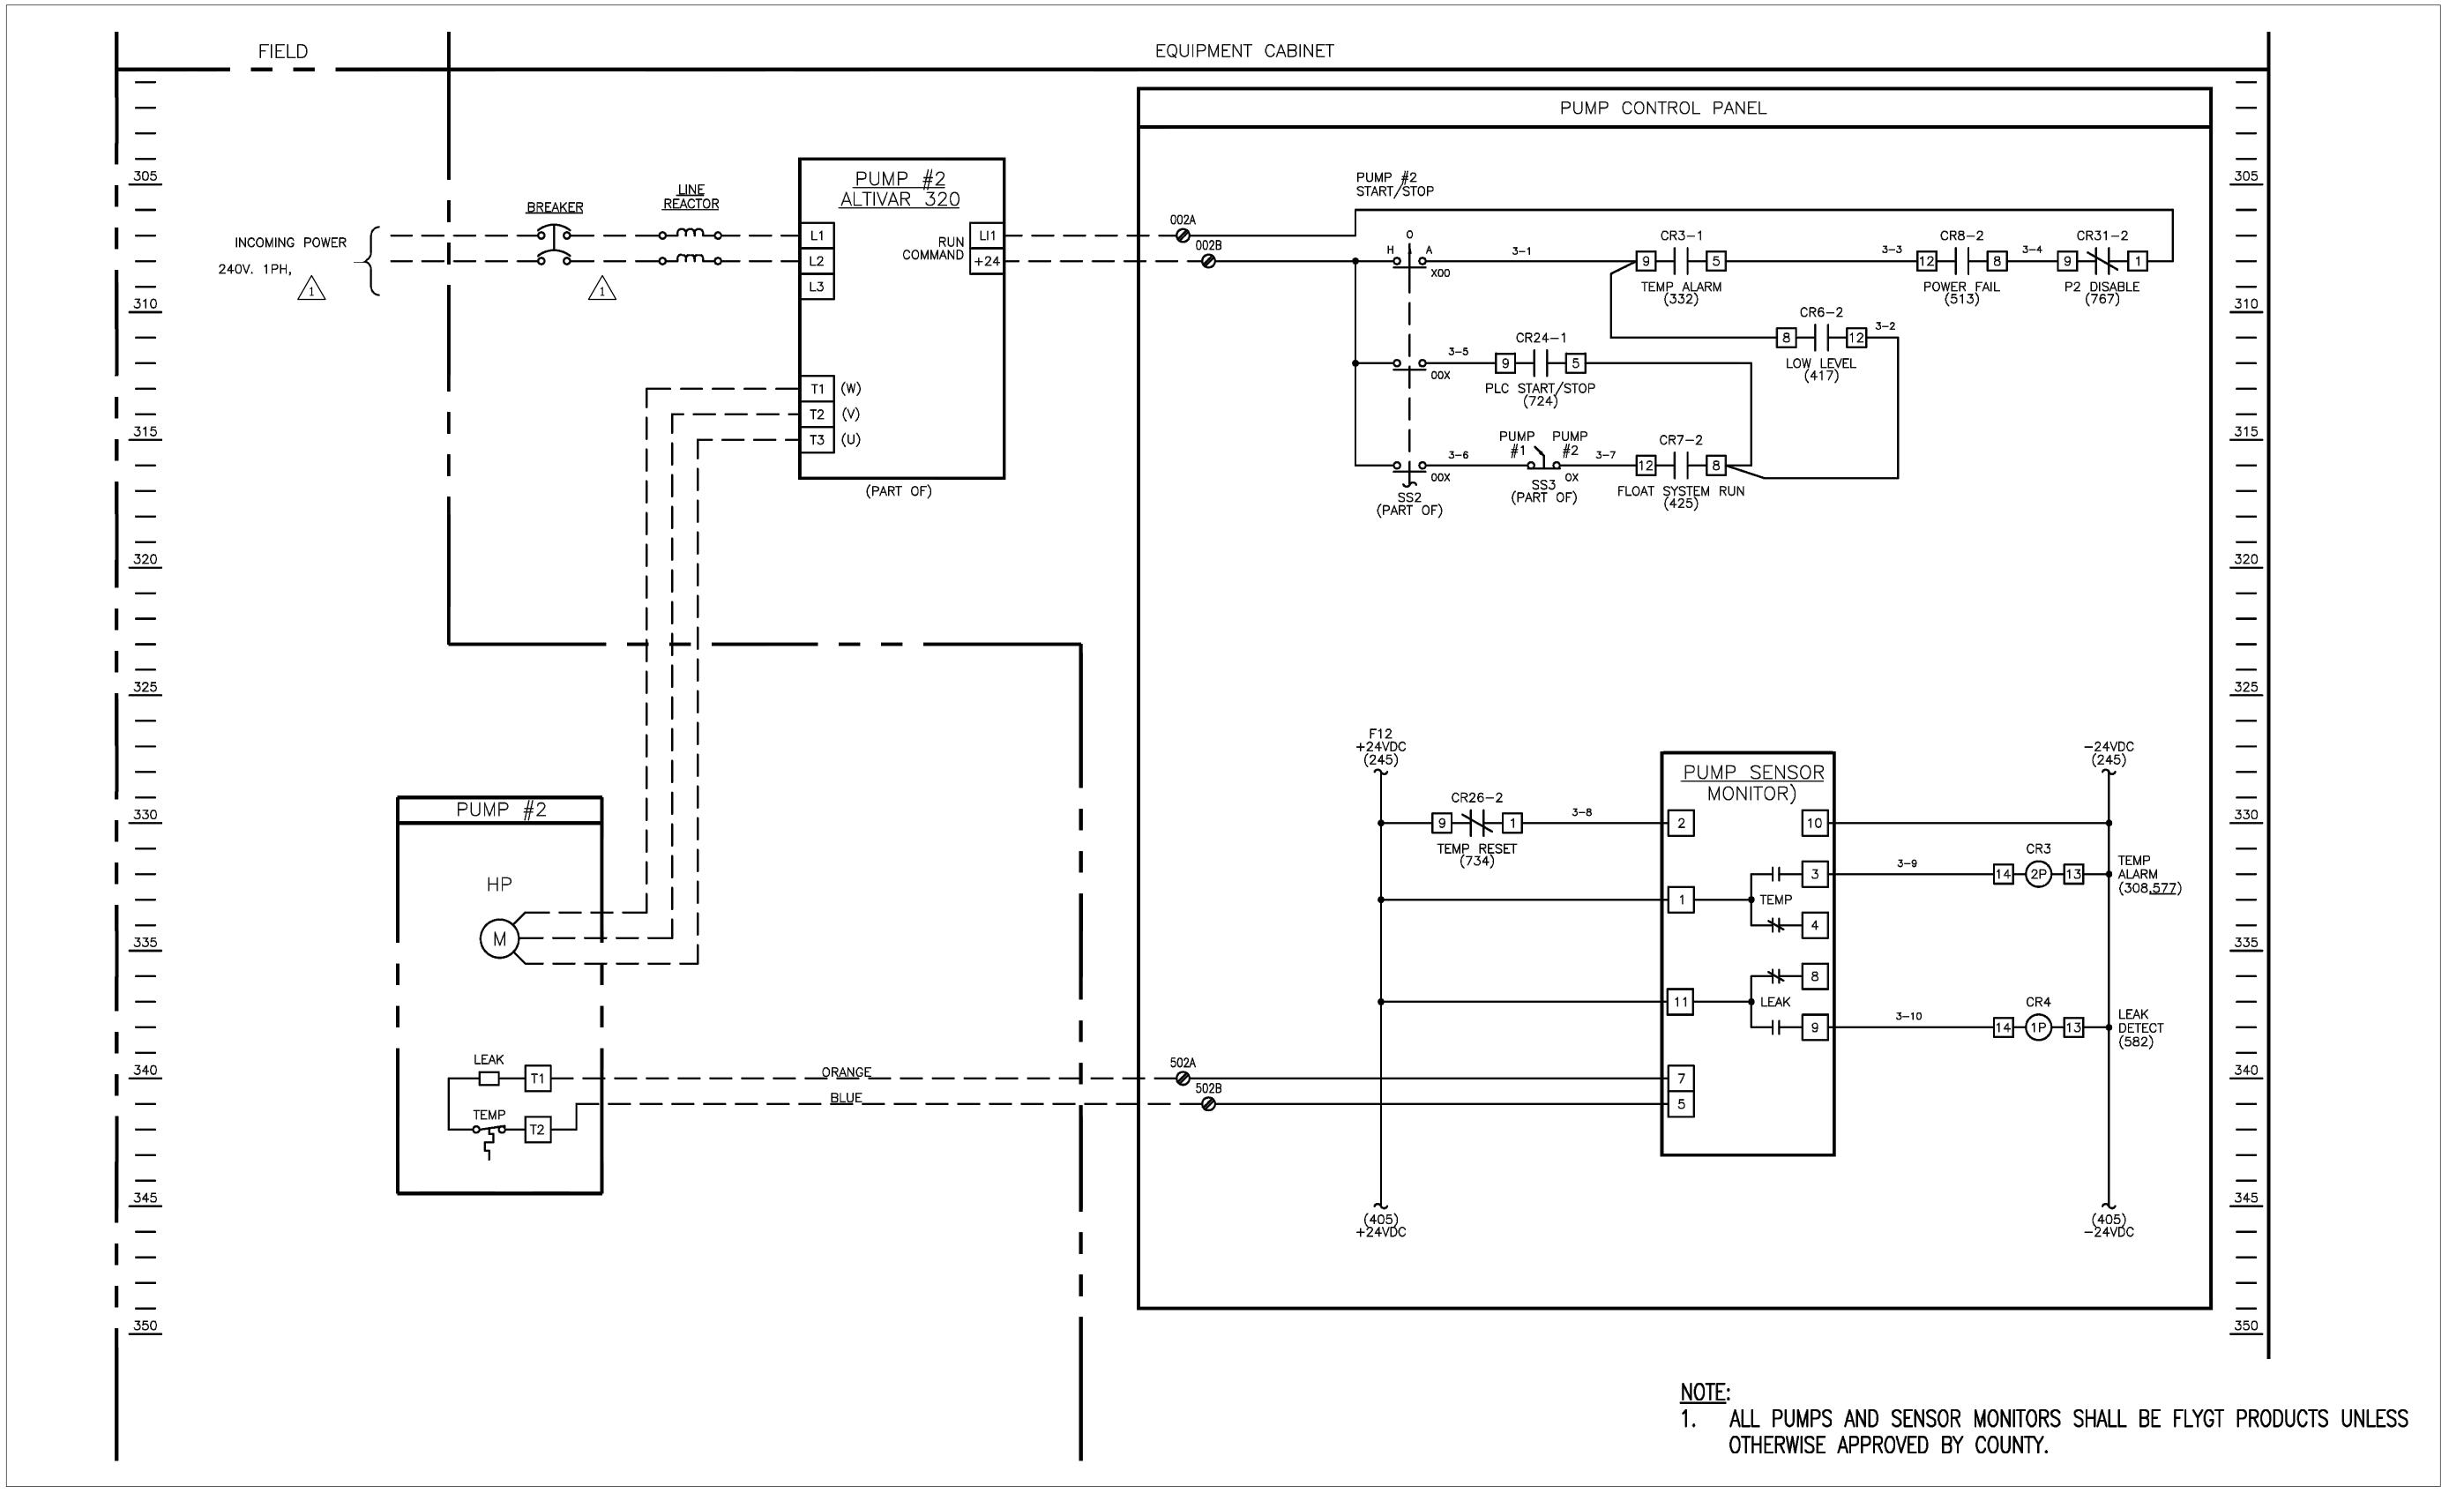

SCED DETAIL I-12 (4/25/2023)

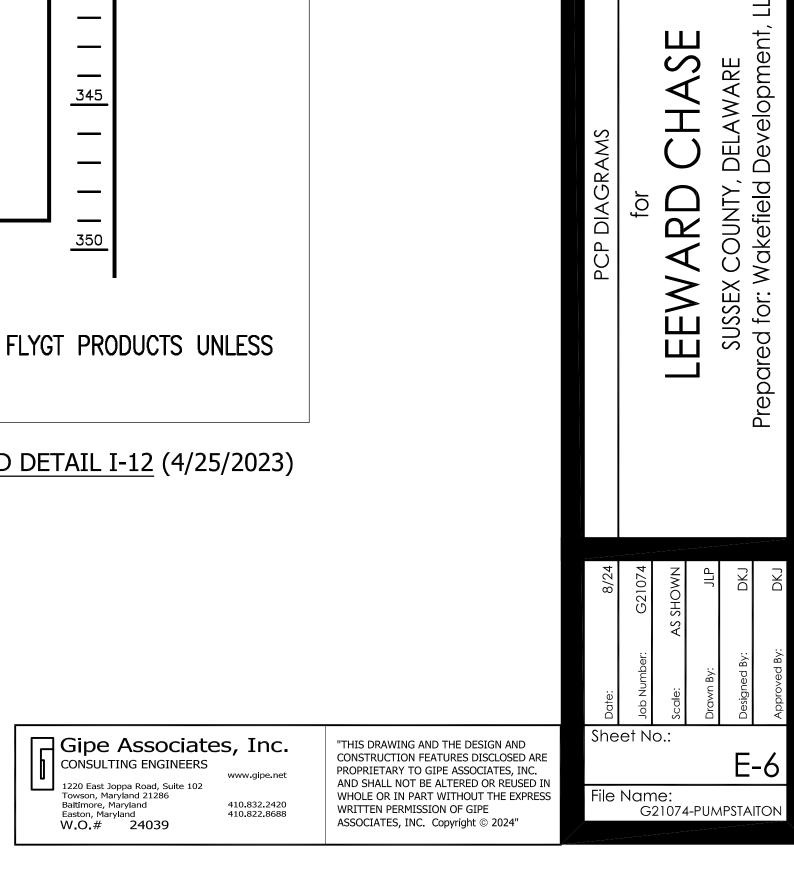

Integrated Planning

Date: 8/6/2024

PROFESSIONAL

CERTIFICATION:

CERTIFICATION:

I HEREBY CERTIFY THAT
THESE DOCUMENTS
WERE PREPARED OR
APPROVED BY ME, AND
THAT I AM A DULY
LICENSED PROFESSIONAL
ENGINEER UNDER THE
LAWS OF THE STATE OF
DELAWARE, LICENSE No.
17123, EXPIRATION


DATE: 06/30/2026.

Engineering & Management, LLC

ww.solutionsipem.com Copyright © 2022

Georgetown, DE 19947 T. 302.297.9215

3003 Merritt Mill Road Salisbury, MD 21804 T. 410.572.8833

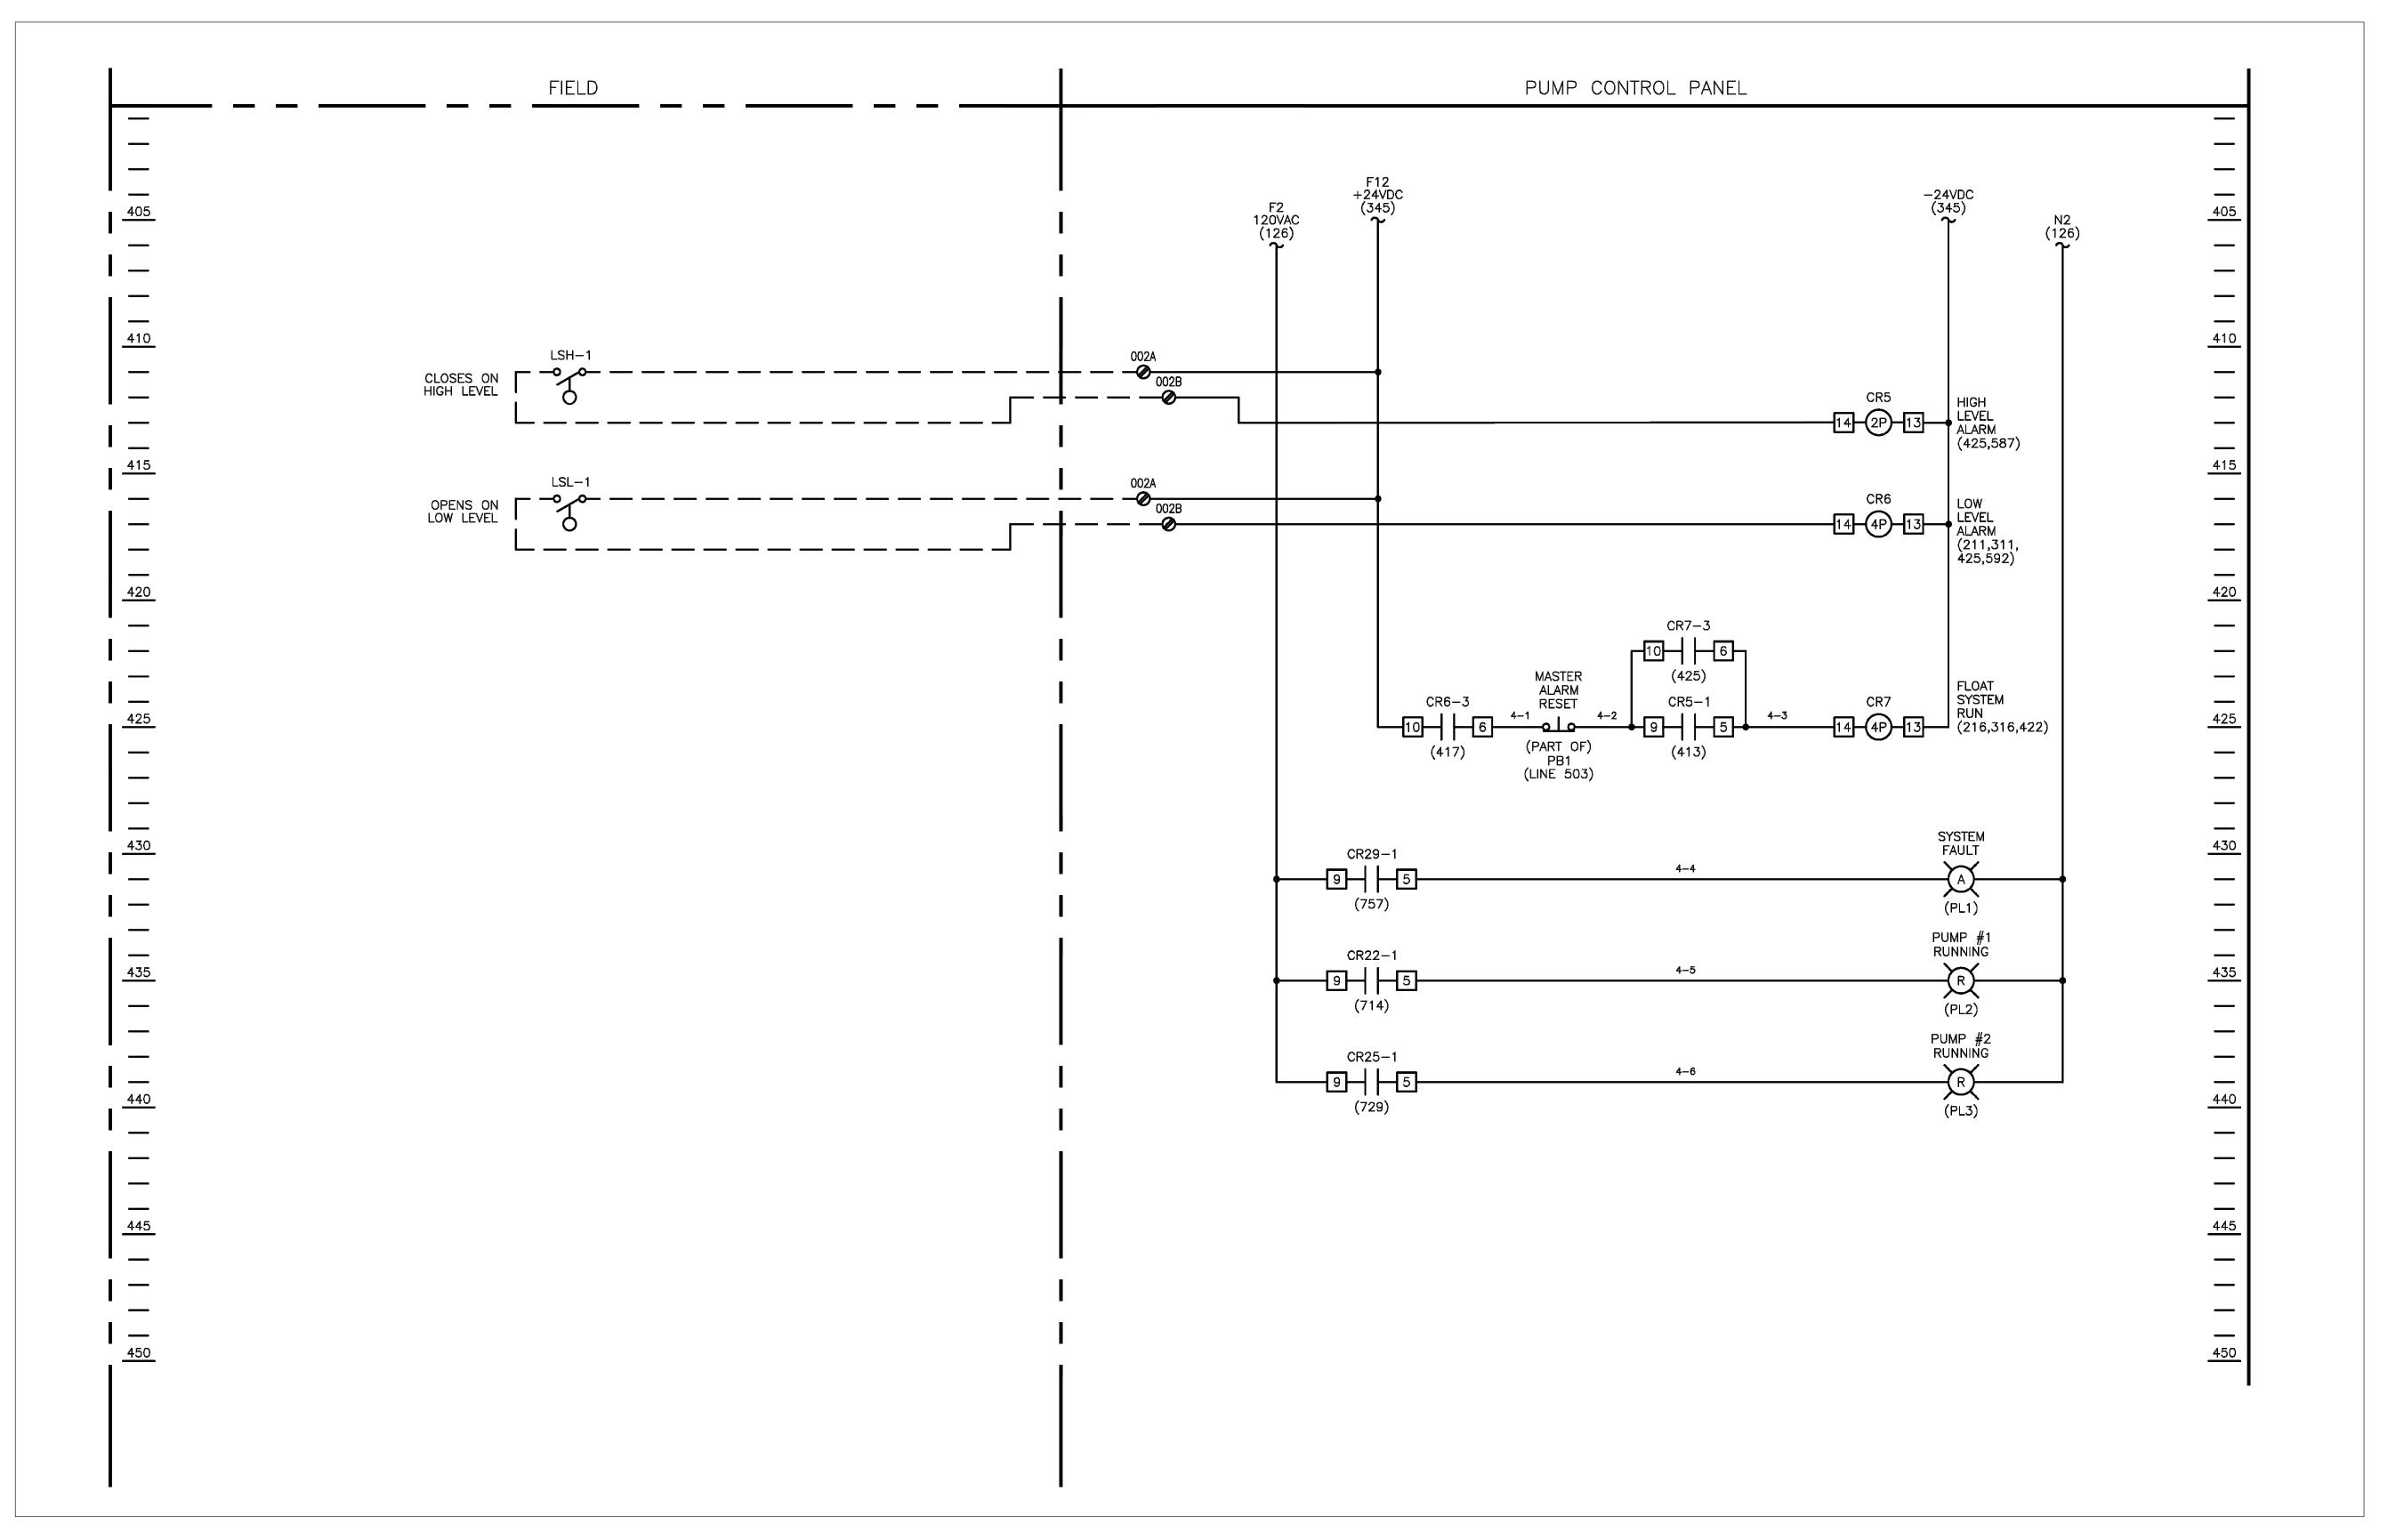

SCED DETAIL I-13 (4/25/2023)

Gipe Associates, Inc.
CONSULTING ENGINEERS

1220 East Joppa Road, Suite 102
Towson, Maryland 21286
Baltimore, Maryland 410.832.2420
Easton, Maryland 410.822.8688
W.O.# 24039 "THIS DRAWING AND THE DESIGN AND CONSTRUCTION FEATURES DISCLOSED ARE PROPRIETARY TO GIPE ASSOCIATES, INC. AND SHALL NOT BE ALTERED OR REUSED IN WHOLE OR IN PART WITHOUT THE EXPRESS WRITTEN PERMISSION OF GIPE ASSOCIATES, INC. Copyright © 2024" Sheet No.: File Name: G21074-PUMPSTAITON


PROFESSIONAL
CERTIFICATION:
I HEREBY CERTIFY THAT
THESE DOCUMENTS
WERE PREPARED OR
APPROVED BY ME, AND
THAT I AM A DULY
LICENSED PROFESSIONAL
ENGINEER UNDER THE
LAWS OF THE STATE OF
DELAWARE, LICENSE No.
17123, EXPIRATION
DATE: 06/30/2026. Date: 8/6/2024

Integrated Planning Engineering & Management, LLC

www.solutionsipem.com Copyright © 2022

303 North Bedford Stree Georgetown, DE 19947 T. 302.297.9215

3003 Merritt Mill Road Salisbury, MD 21804 T. 410.572.8833

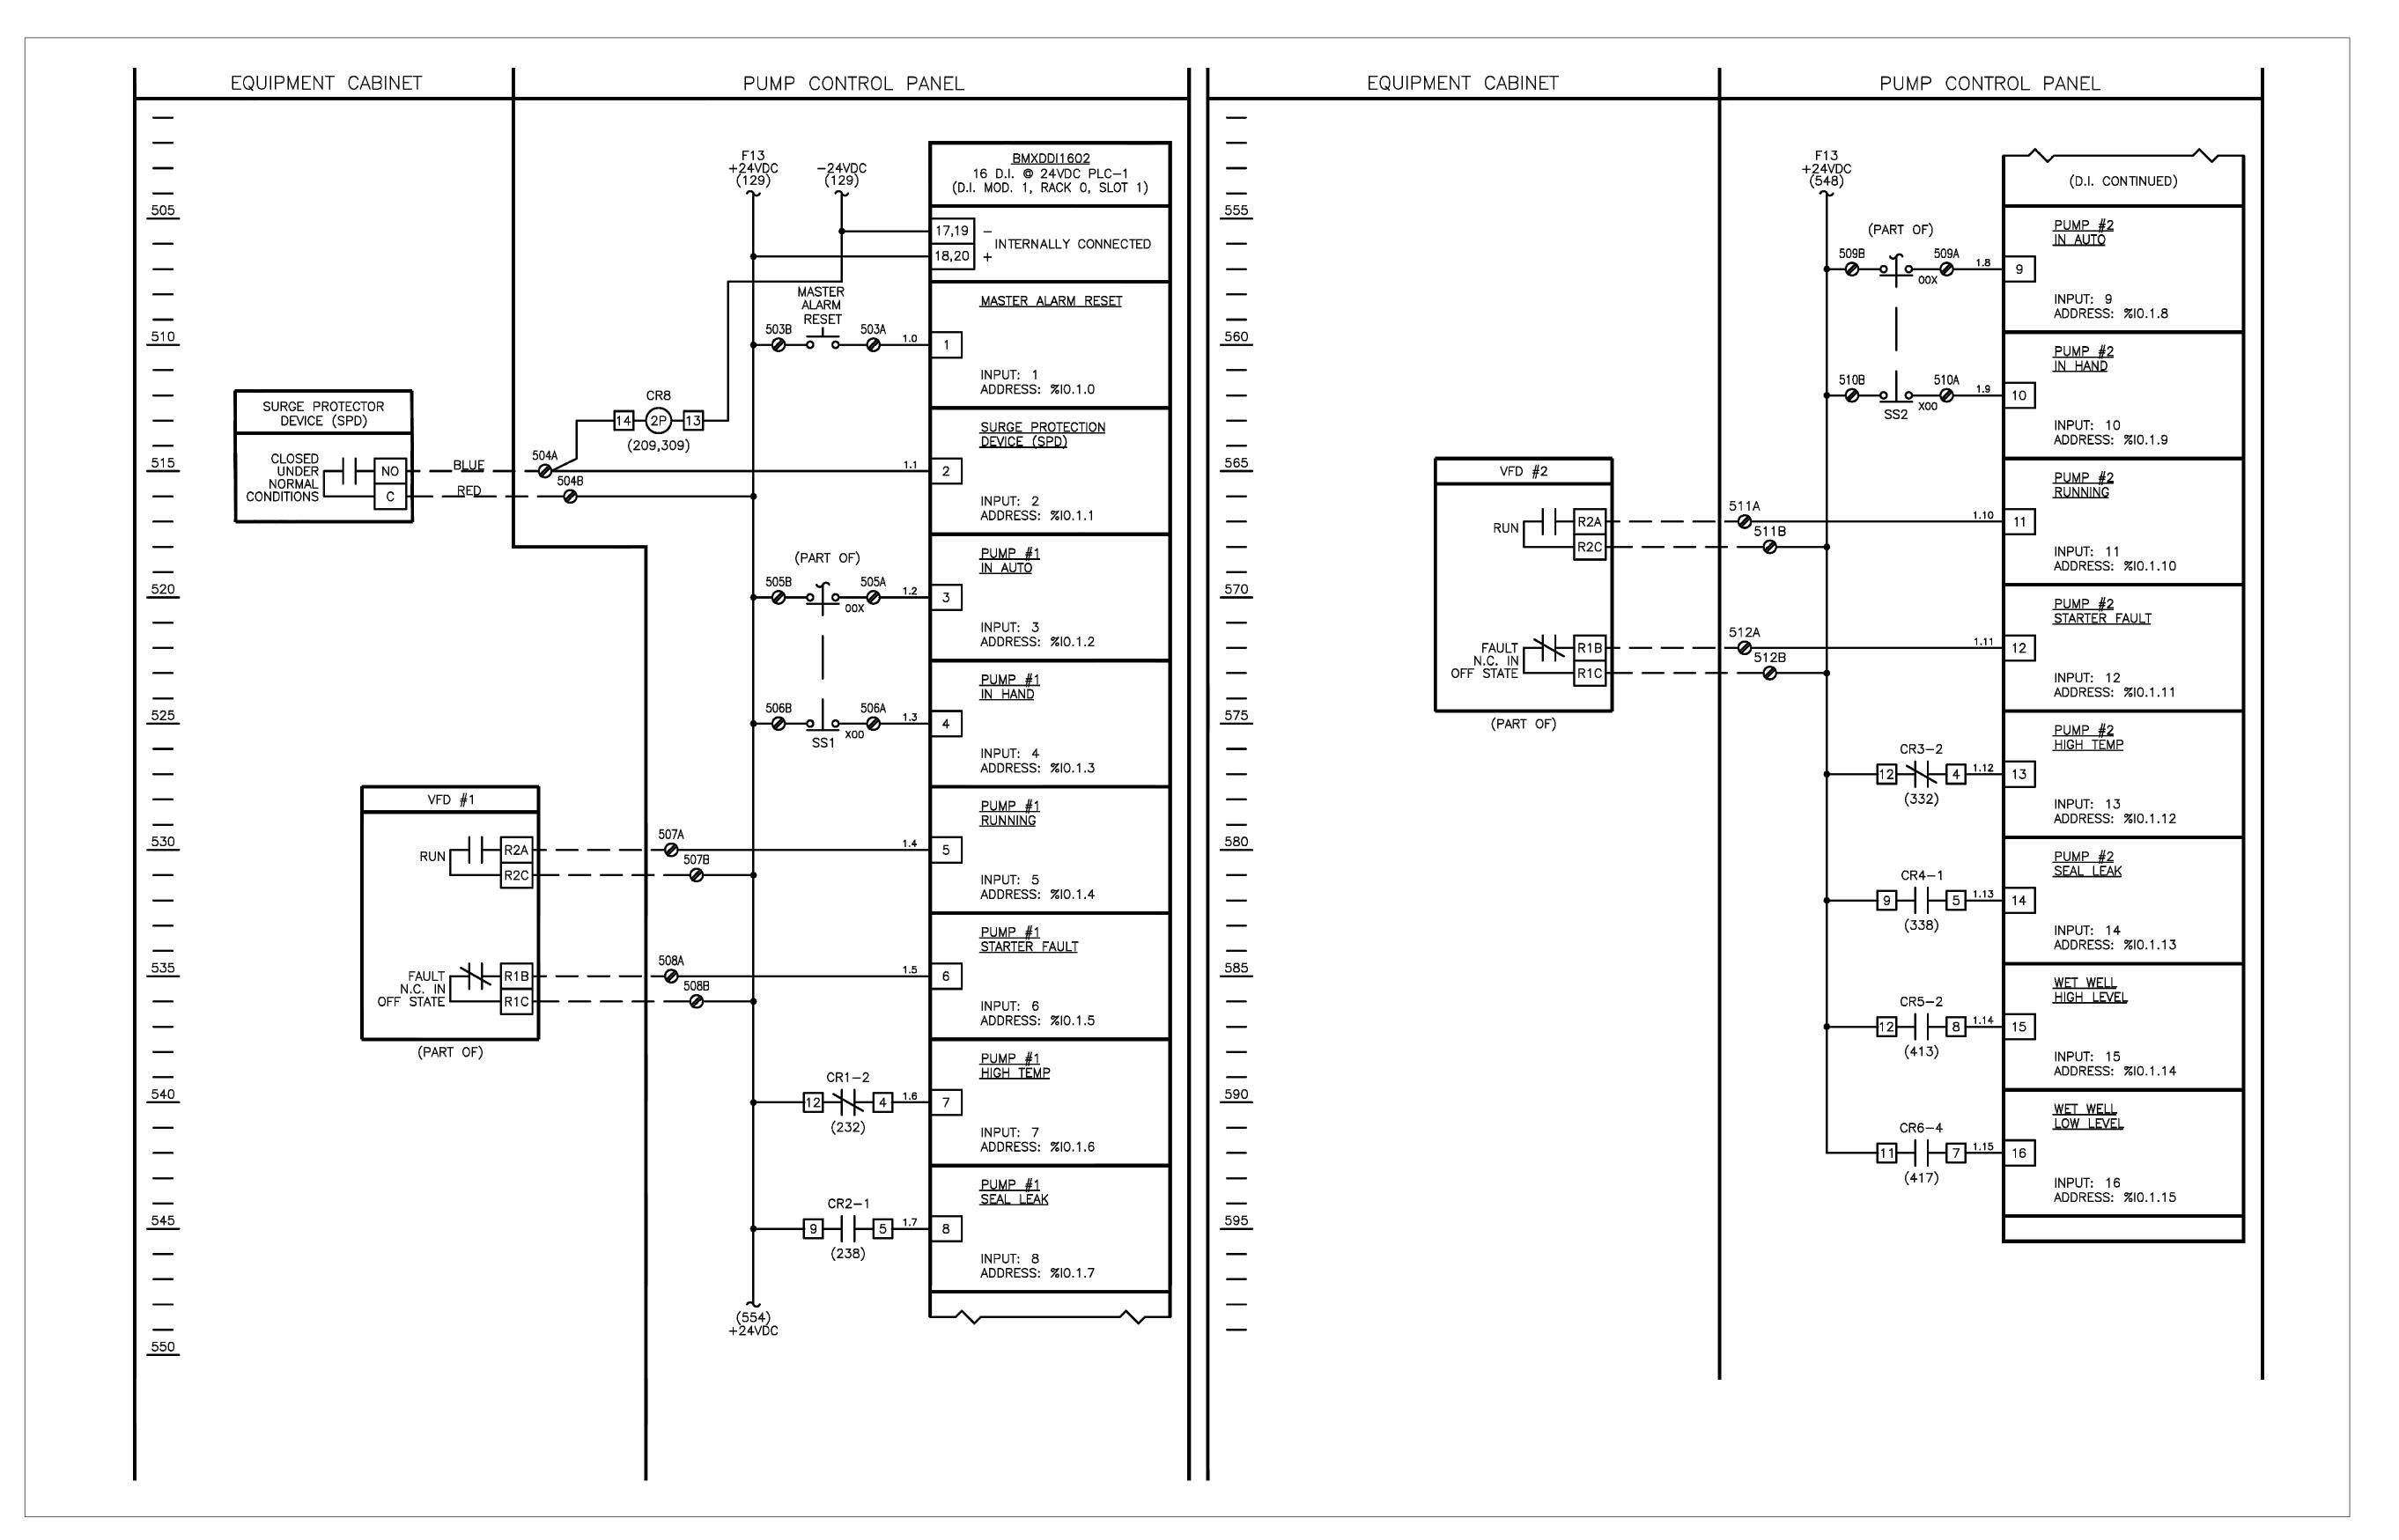

SCED DETAIL I-14 (4/25/2023)

Integrated Planning Engineering & Management, LLC Georgetown, DE 1994 T. 302.297.921 3003 Merritt Mill Roa Salisbury, MD 21804 T. 410.572.8833 ww.solutionsipem.com Copyright © 2022 PROFESSIONAL **CERTIFICATION:** CERTIFICATION:

I HEREBY CERTIFY THAT
THESE DOCUMENTS
WERE PREPARED OR
APPROVED BY ME, AND
THAT I AM A DULY
LICENSED PROFESSIONAL
ENGINEER UNDER THE
LAWS OF THE STATE OF
DELAWARE, LICENSE No.
17123, EXPIRATION No. 17123 Date: 8/6/2024 DATE: 06/30/2026. /ARD Sheet No.: "THIS DRAWING AND THE DESIGN AND CONSTRUCTION FEATURES DISCLOSED ARE E-8


Gipe Associates, Inc.
CONSULTING ENGINEERS

1220 East Joppa Road, Suite 102
Towson, Maryland 21286
Baltimore, Maryland 410.832.2420
Easton, Maryland 410.822.8688
W.O.# 24039


WRITTEN PERMISSION OF GIPE ASSOCIATES, INC. Copyright © 2024"

PROPRIETARY TO GIPE ASSOCIATES, INC. AND SHALL NOT BE ALTERED OR REUSED IN WHOLE OR IN PART WITHOUT THE EXPRESS

File Name: G21074-PUMPSTAITON

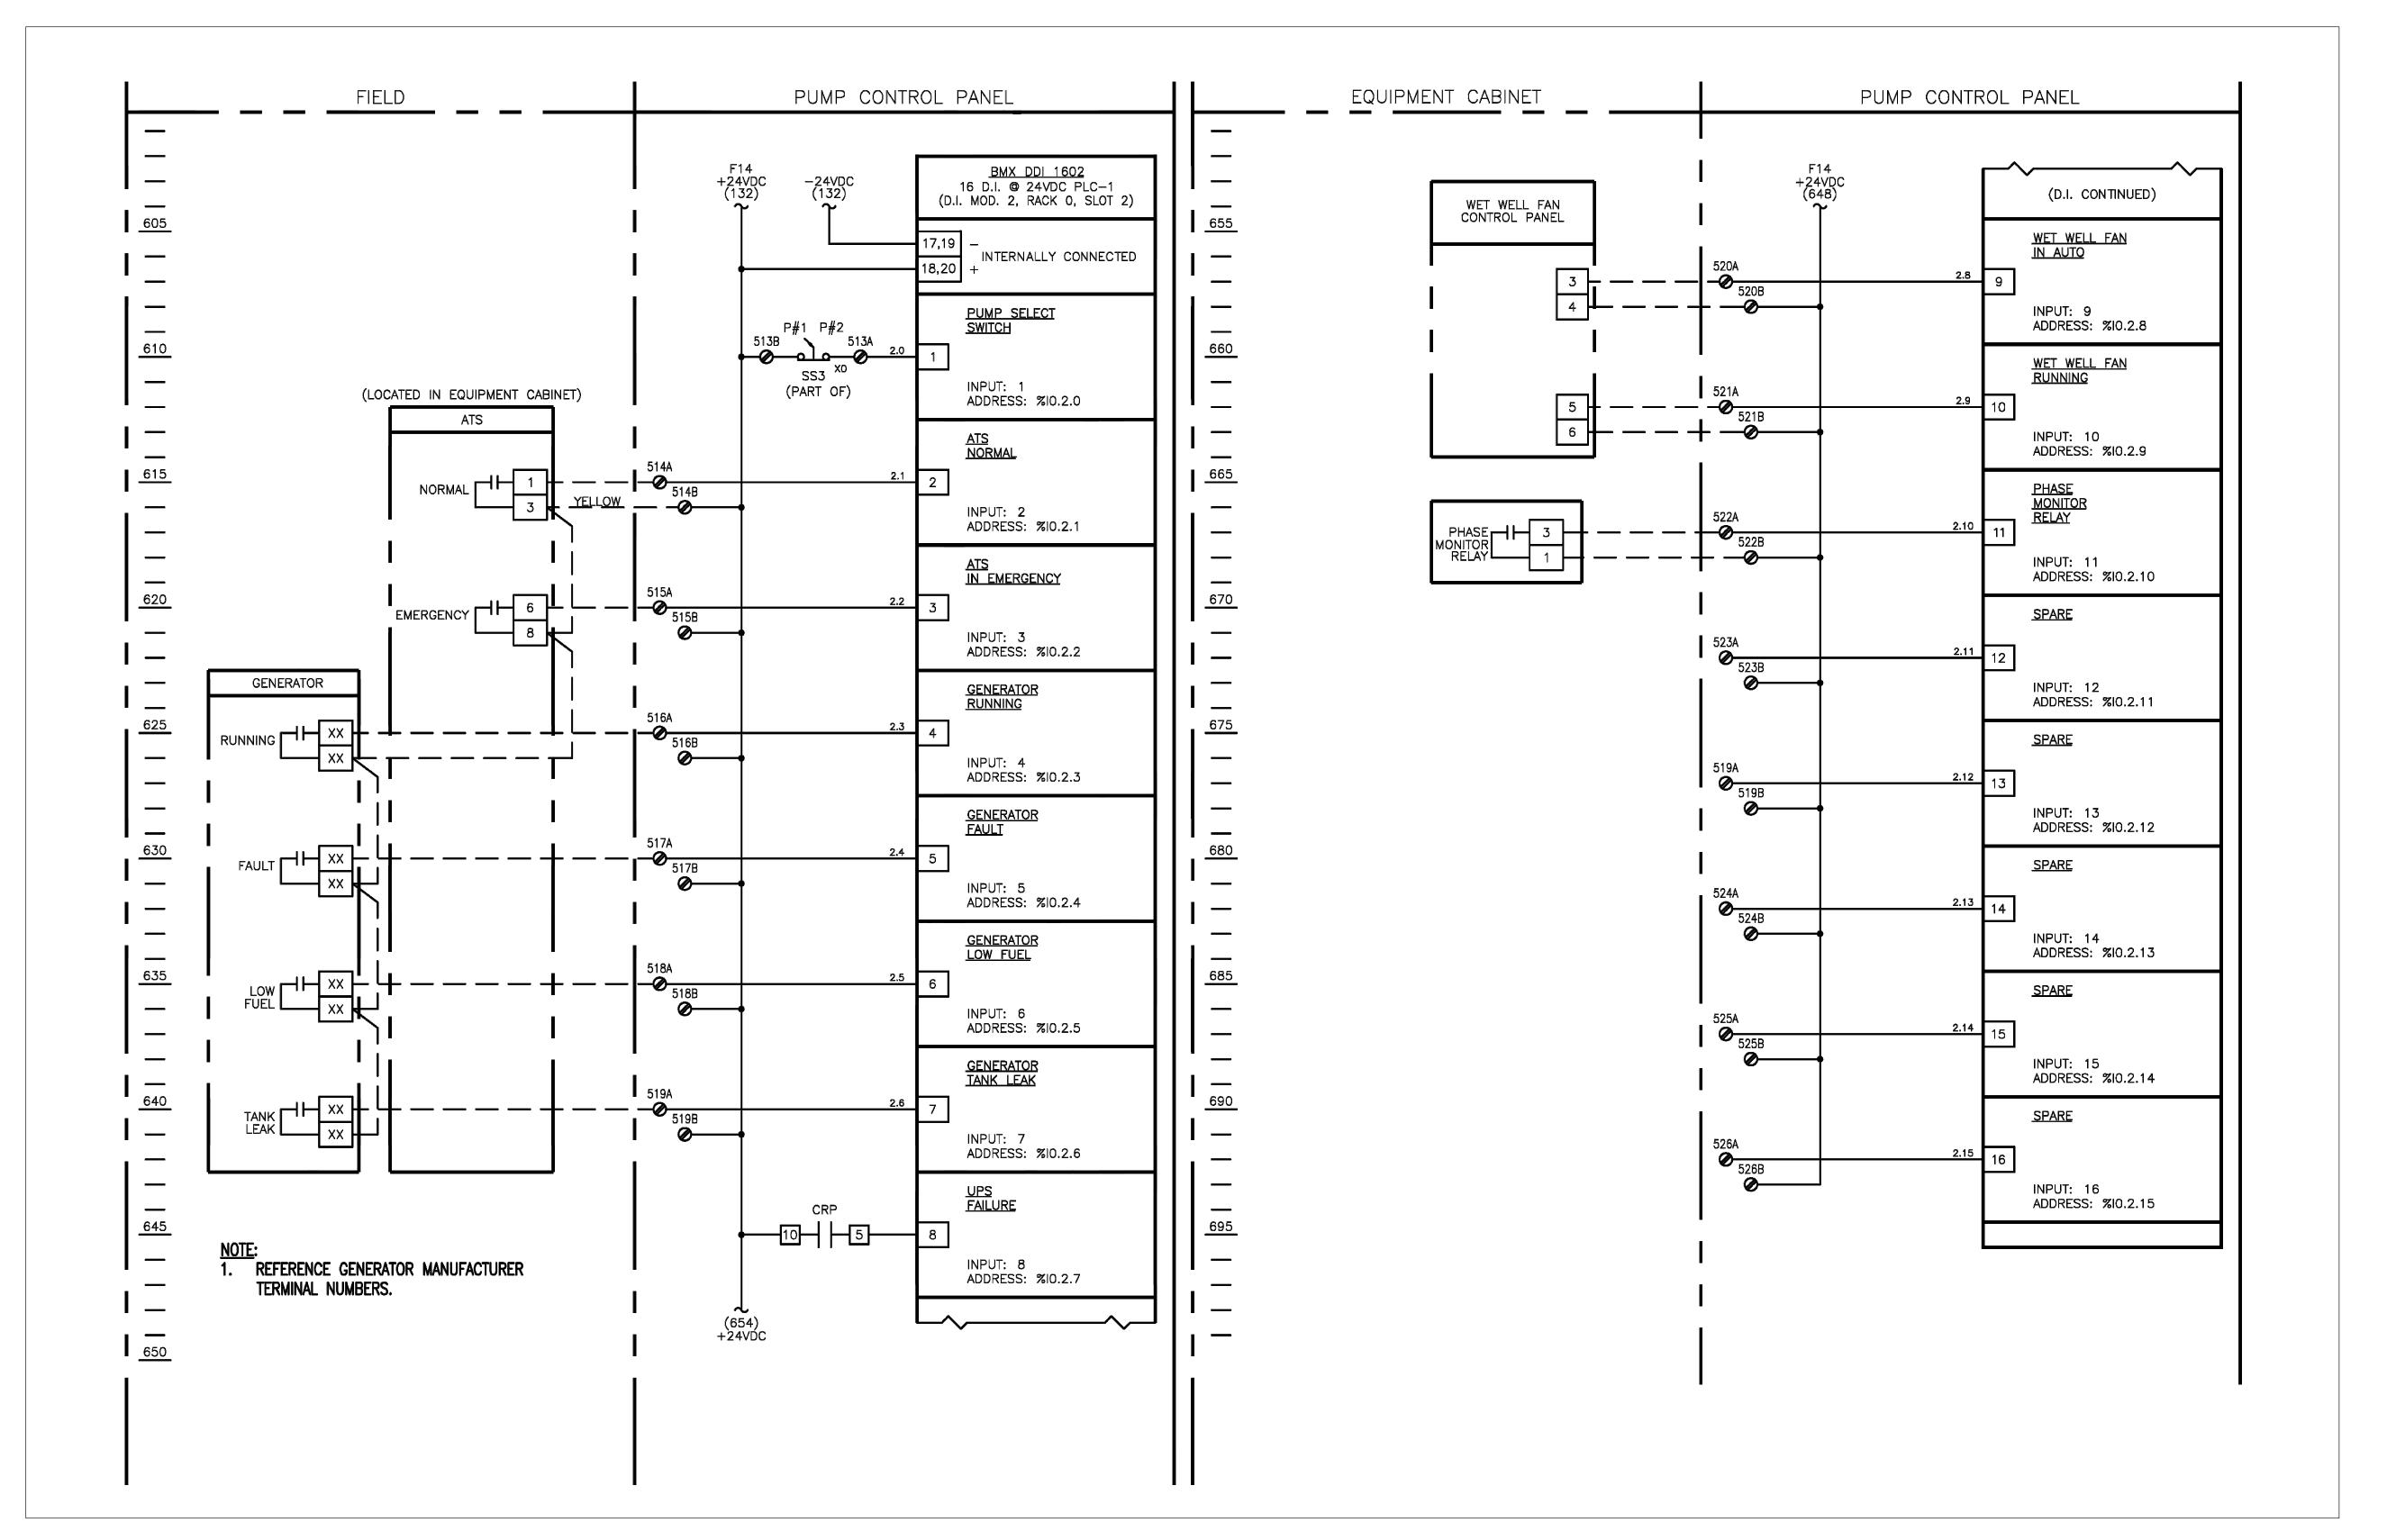

SCED DETAIL I-15 (4/25/2023)

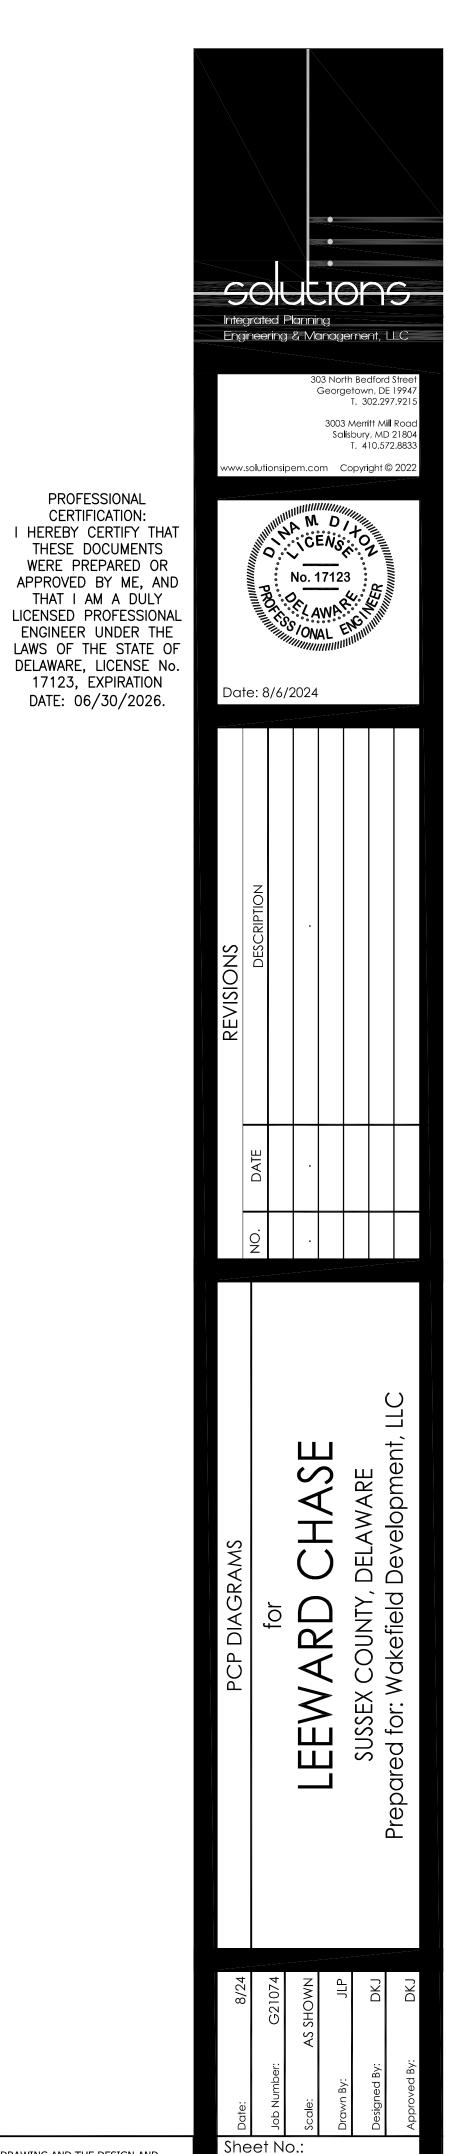

Gipe Associates, Inc.
CONSULTING ENGINEERS

1220 East Joppa Road, Suite 102
Towson, Maryland 21286
BaltImore, Maryland 410.832.2420
Easton, Maryland 410.822.8688
W.O.# 24039


"THIS DRAWING AND THE DESIGN AND WRITTEN PERMISSION OF GIPE ASSOCIATES, INC. Copyright © 2024"

CONSTRUCTION FEATURES DISCLOSED ARE PROPRIETARY TO GIPE ASSOCIATES, INC. AND SHALL NOT BE ALTERED OR REUSED IN WHOLE OR IN PART WITHOUT THE EXPRESS

E-9

G21074-PUMPSTAITON

File Name:

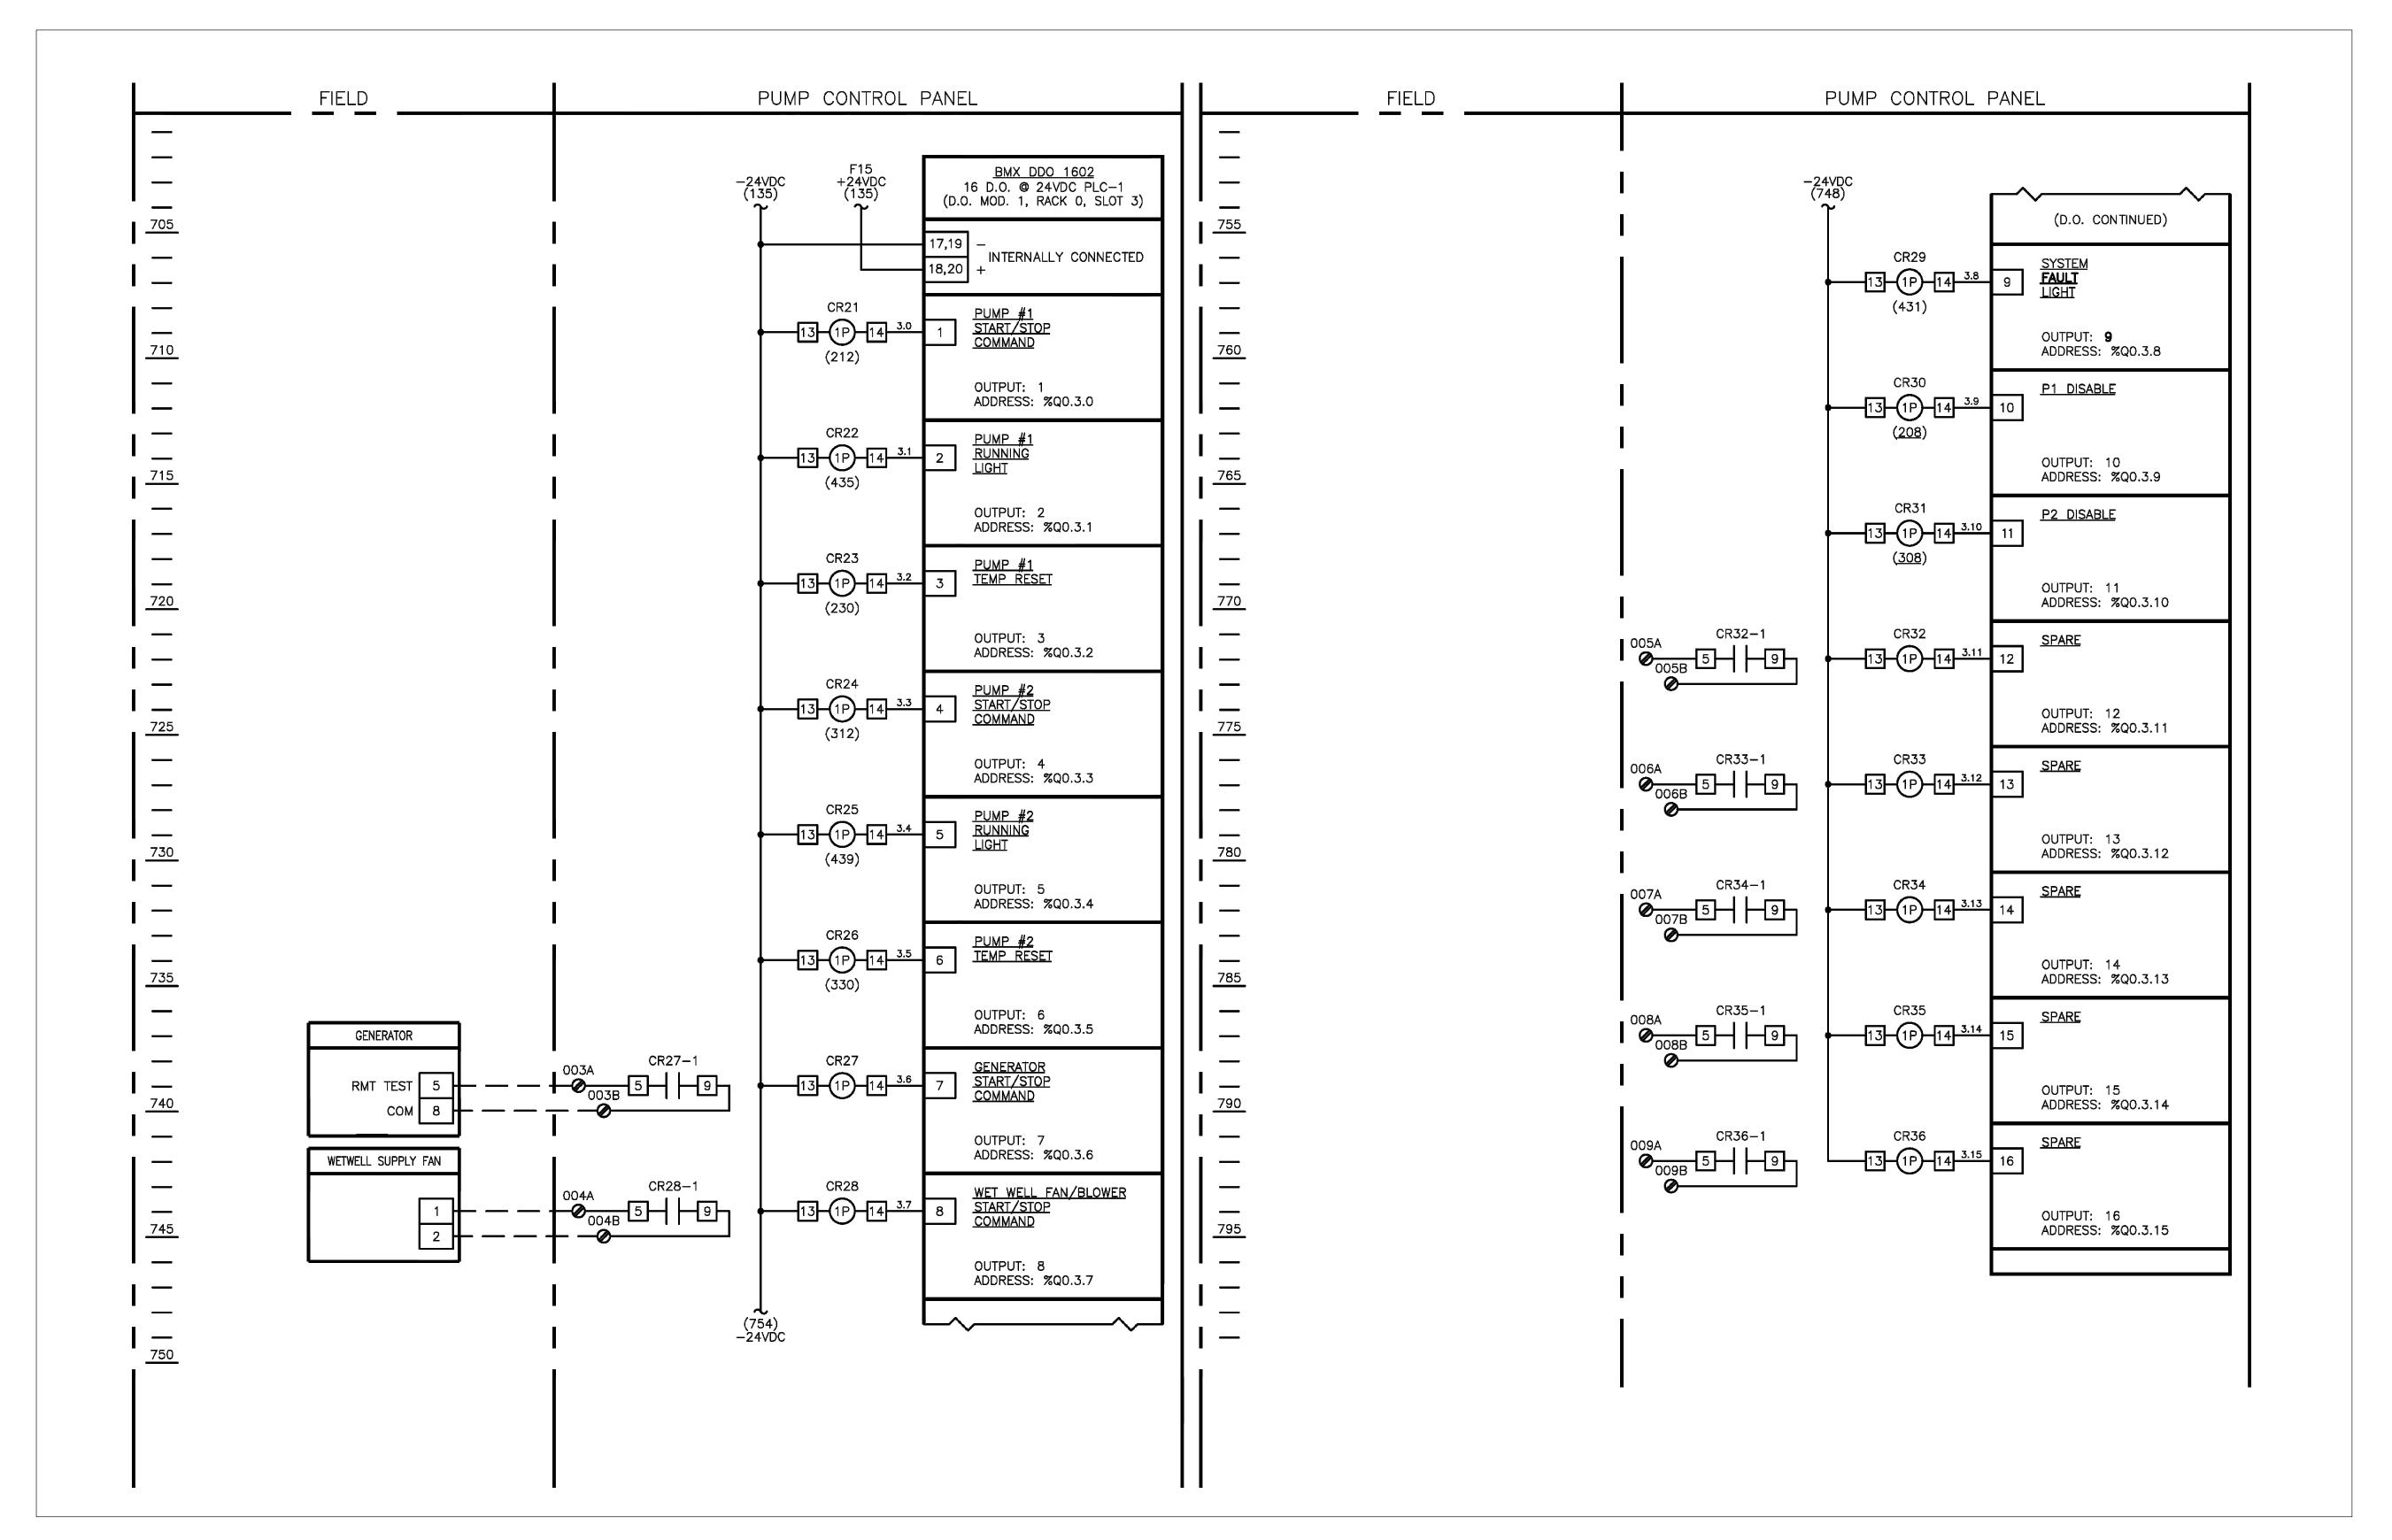

SCED DETAIL I-16 (4/25/2023)

Integrated Planning Engineering & Management, LLC Georgetown, DE 19947 T. 302.297.9215 3003 Merritt Mill Roa Sa**l**isbury, MD 21804 T. 410.572.8833 ww.solutionsipem.com Copyright © 2022 PROFESSIONAL No. 17123 **CERTIFICATION:** I HEREBY CERTIFY THAT THESE DOCUMENTS
WERE PREPARED OR
APPROVED BY ME, AND THAT I AM A DULY LICENSED PROFESSIONAL ENGINEER UNDER THE LAWS OF THE STATE OF DELAWARE, LICENSE No. 17123, EXPIRATION Date: 8/6/2024 DATE: 06/30/2026. 'ARD Sheet No.: E-10

Gipe Associates, Inc.
CONSULTING ENGINEERS


1220 East Joppa Road, Suite 102
Towson, Maryland 21286
Baltmore, Maryland 410.832.2420
Easton, Maryland 410.822.8688
W.O.# 24039

WRITTEN PERMISSION OF GIPE ASSOCIATES, INC. Copyright © 2024"

"THIS DRAWING AND THE DESIGN AND CONSTRUCTION FEATURES DISCLOSED ARE PROPRIETARY TO GIPE ASSOCIATES, INC. AND SHALL NOT BE ALTERED OR REUSED IN WHOLE OR IN PART WITHOUT THE EXPRESS

File Name:

G21074-PUMPSTAITON

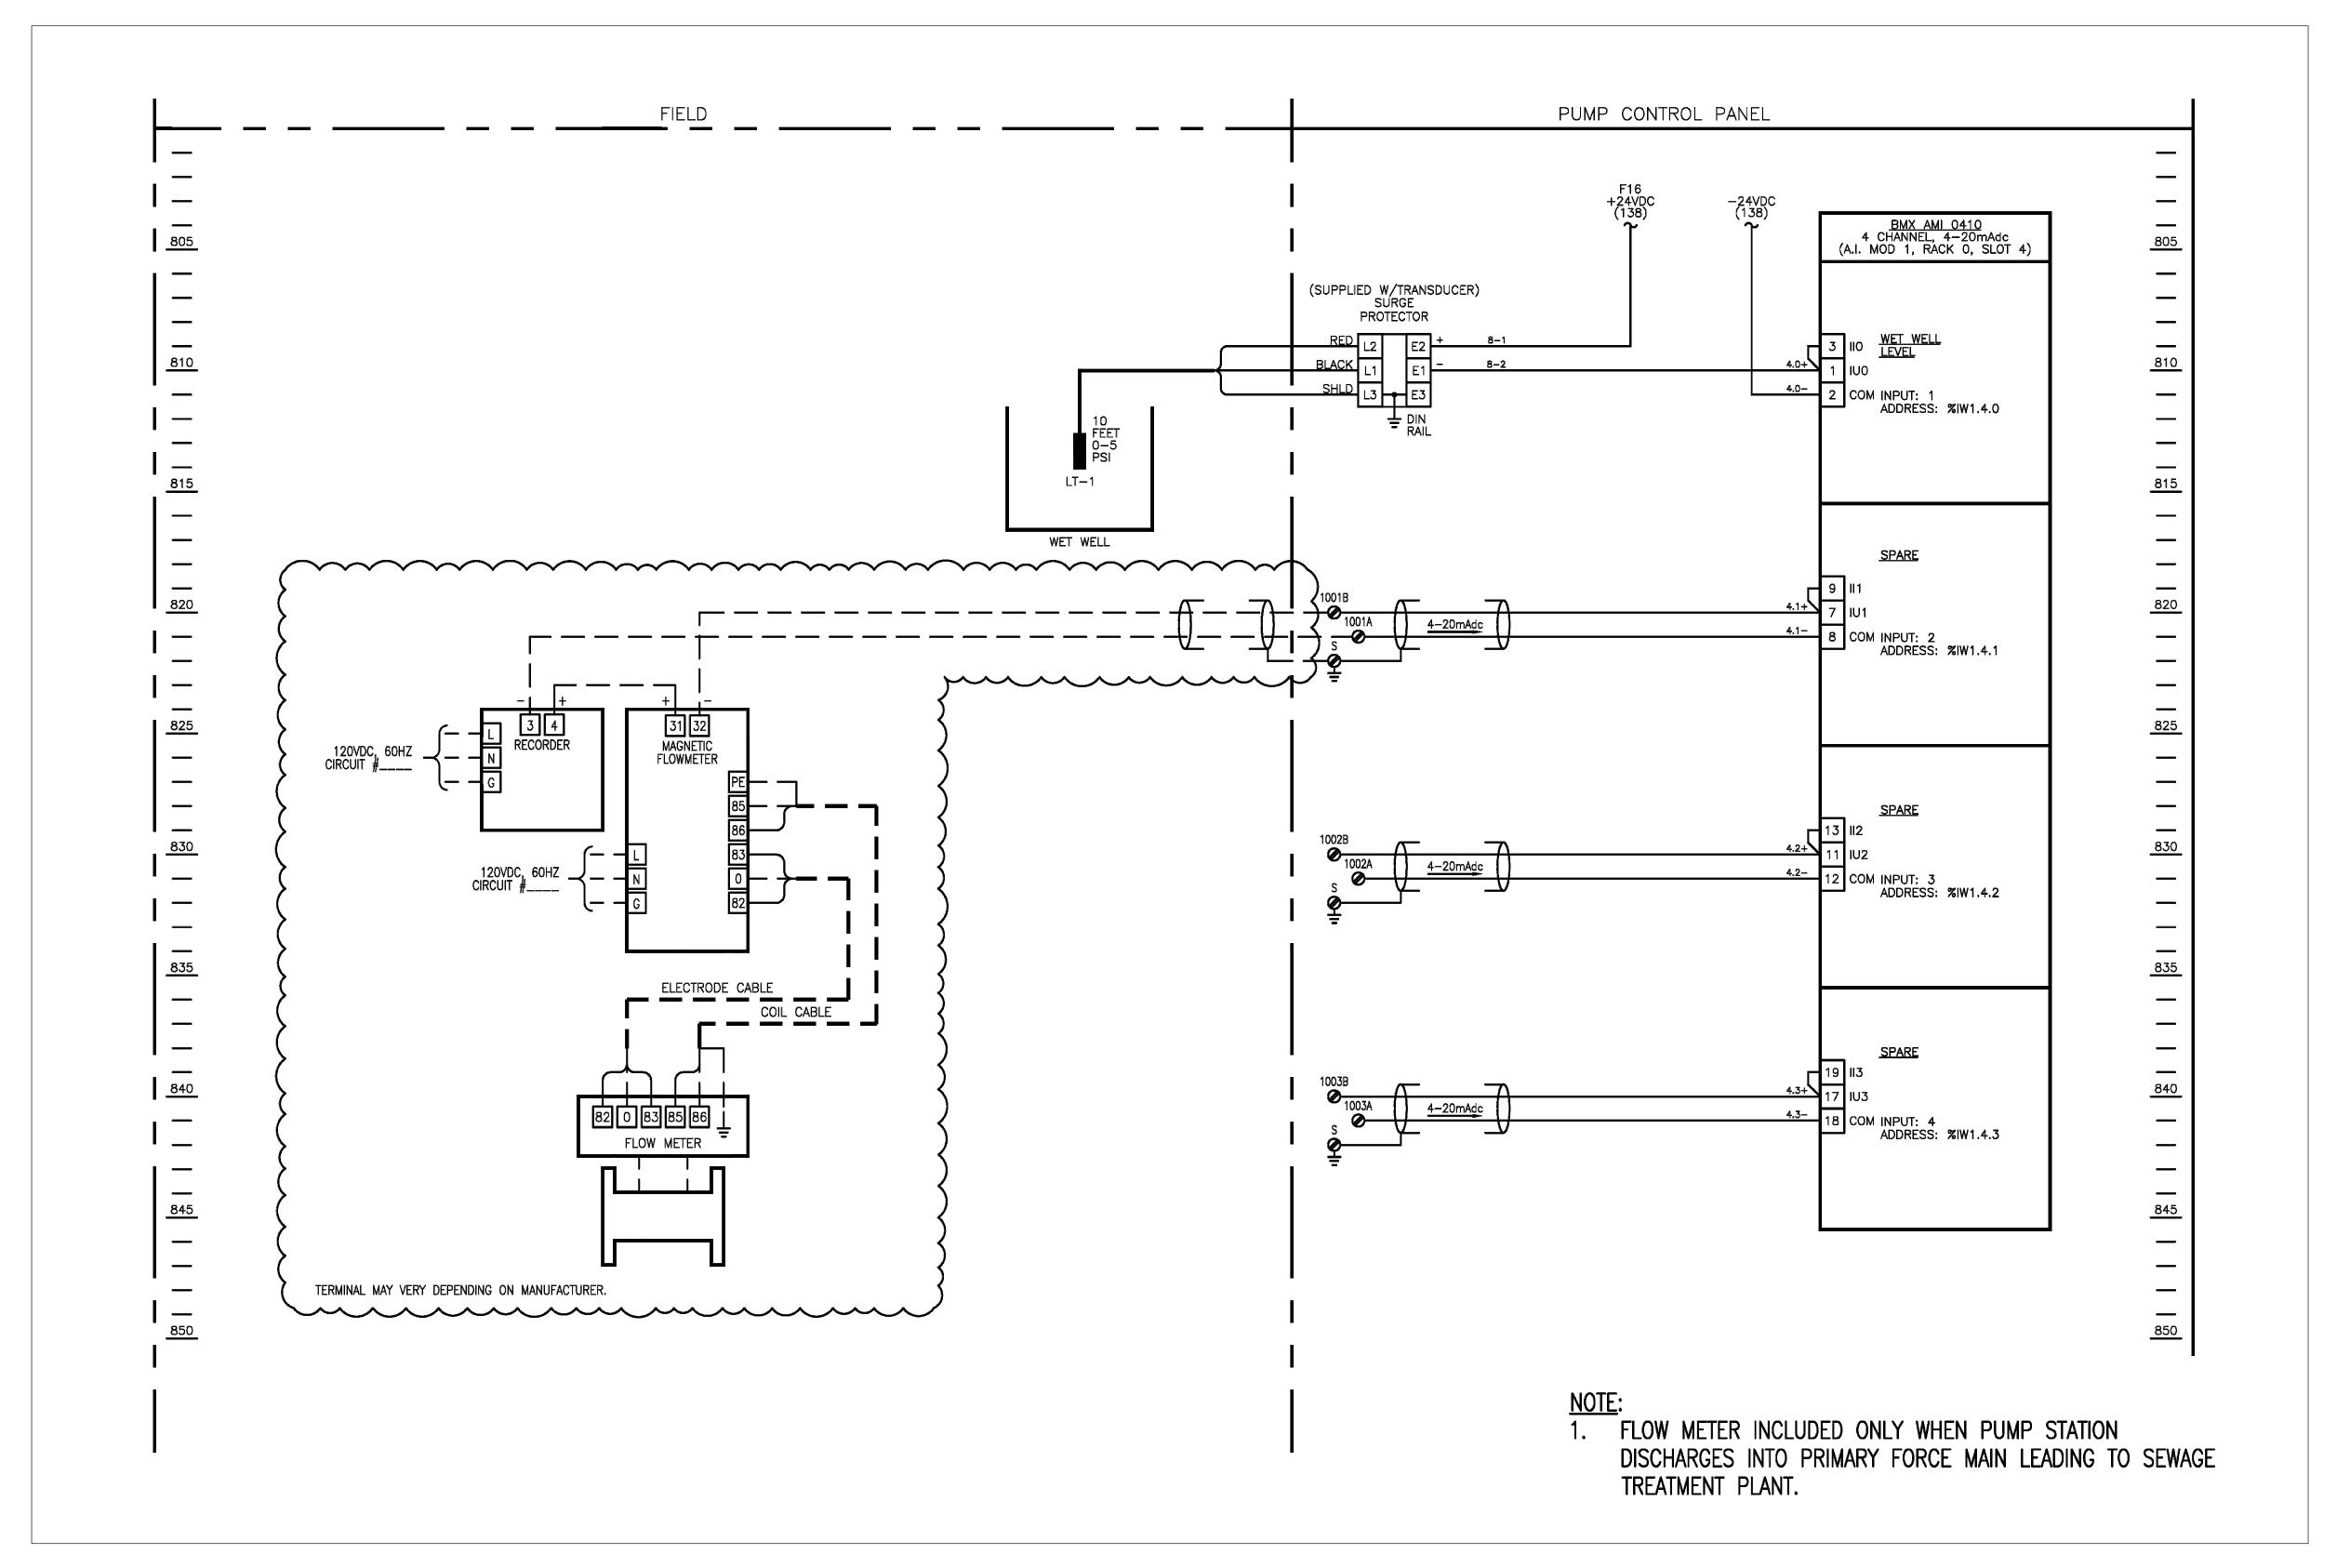

SCED DETAIL I-17 (4/25/2023)

Integrated Planning Engineering & Management, LLC 3003 Merritt Mill Roa Salisbury, MD 21804 T. 410.572.8833 PROFESSIONAL **CERTIFICATION:** CERTIFICATION:


I HEREBY CERTIFY THAT
THESE DOCUMENTS
WERE PREPARED OR
APPROVED BY ME, AND
THAT I AM A DULY
LICENSED PROFESSIONAL
ENGINEER UNDER THE
LAWS OF THE STATE OF
DELAWARE, LICENSE No.
17123, EXPIRATION Date: 8/6/2024 DATE: 06/30/2026. "THIS DRAWING AND THE DESIGN AND E-1 CONSTRUCTION FEATURES DISCLOSED ARE PROPRIETARY TO GIPE ASSOCIATES, INC. AND SHALL NOT BE ALTERED OR REUSED IN File Name: G21074-PUMPSTAITON

Gipe Associates, Inc.
CONSULTING ENGINEERS

1220 East Joppa Road, Suite 102
Towson, Maryland 21286
Baltmore, Maryland 410.832.2420
Easton, Maryland 410.822.8688
W.O.# 24039

WRITTEN PERMISSION OF GIPE ASSOCIATES, INC. Copyright © 2024"

WHOLE OR IN PART WITHOUT THE EXPRESS

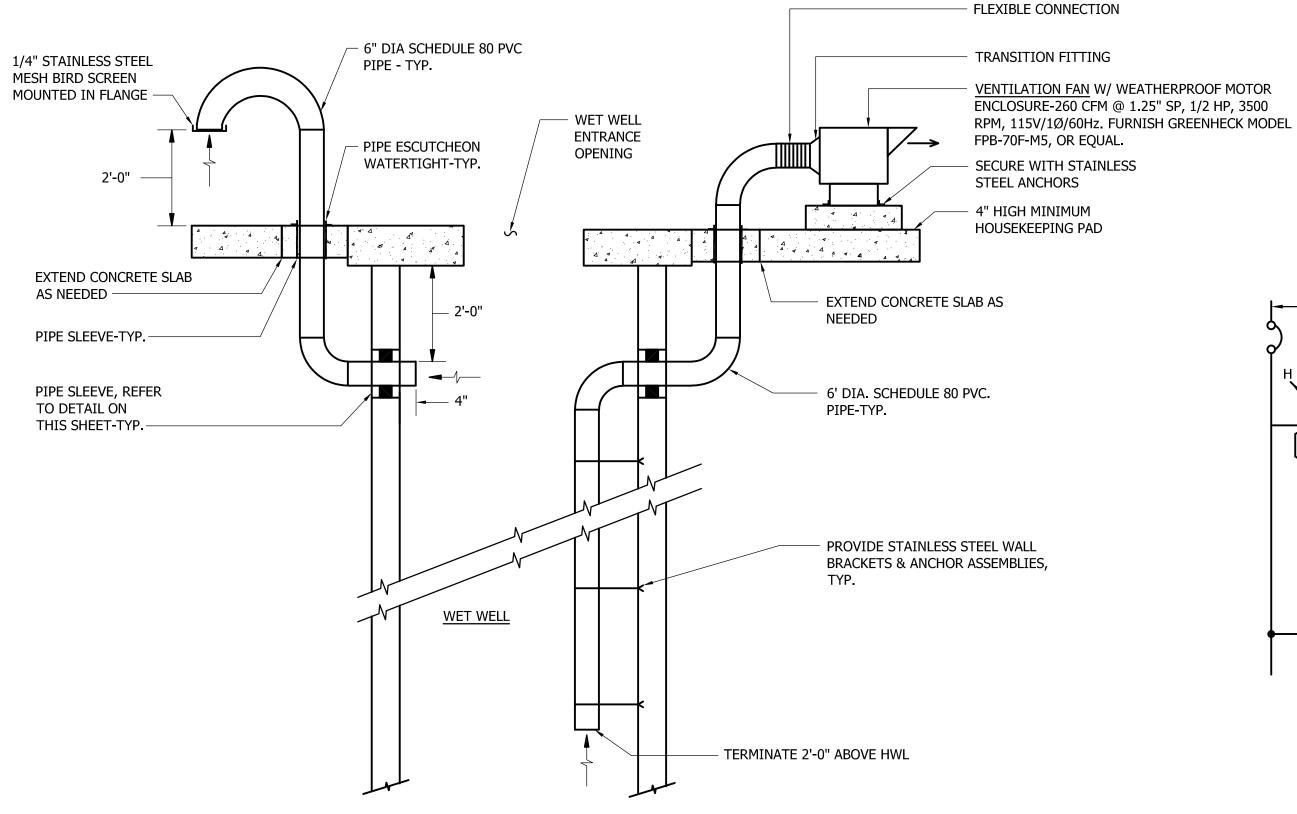


FAN INSTALLATION NO SCALE

WET WELL SUPPLY FAN CONTROL DIAGRAM DETAIL - WET WELL VENTILATION

WALL SLEEVE STANDARD WEIGHT GALVANIZED PIPE SLEEVE WITH ANCHOR COLLAR AND WATER STOP PLATE HYDROSTATIC PIPE WALL CLOSURE LINK SEAL BY THUNDERLINE OR HYDRO-STATIC APPROVED EQUAL SIZE PER MANUFACTURERS PIPE WALL CLOSURE — RECOMMENDATIONS -CARRIER PIPE

DETAIL -TYPICAL PIPE SLEEVE THRU EXTERIOR WALL

1. DETAIL TYPICAL FOR ABOVE GRADE AND **BELOW GRADE**

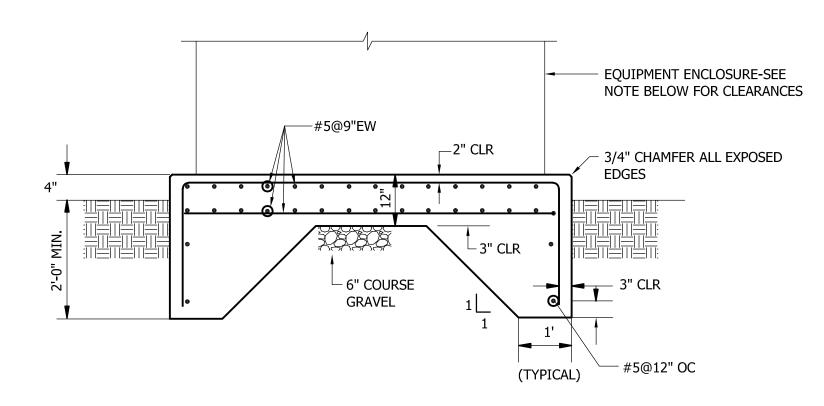


DETAIL - TYPICAL GENERATOR/SERVICE EQUIPMENT CONCRETE PAD

SCALE: NONE

CLEARANCES:

1. GENERATOR - 12" ON ALL SIDES.

2. SERVICES EQUIPMENT CABINET - 5'-0" ON POWER SIDE & CONTROL SIDE & 6" BOTH ENDS.

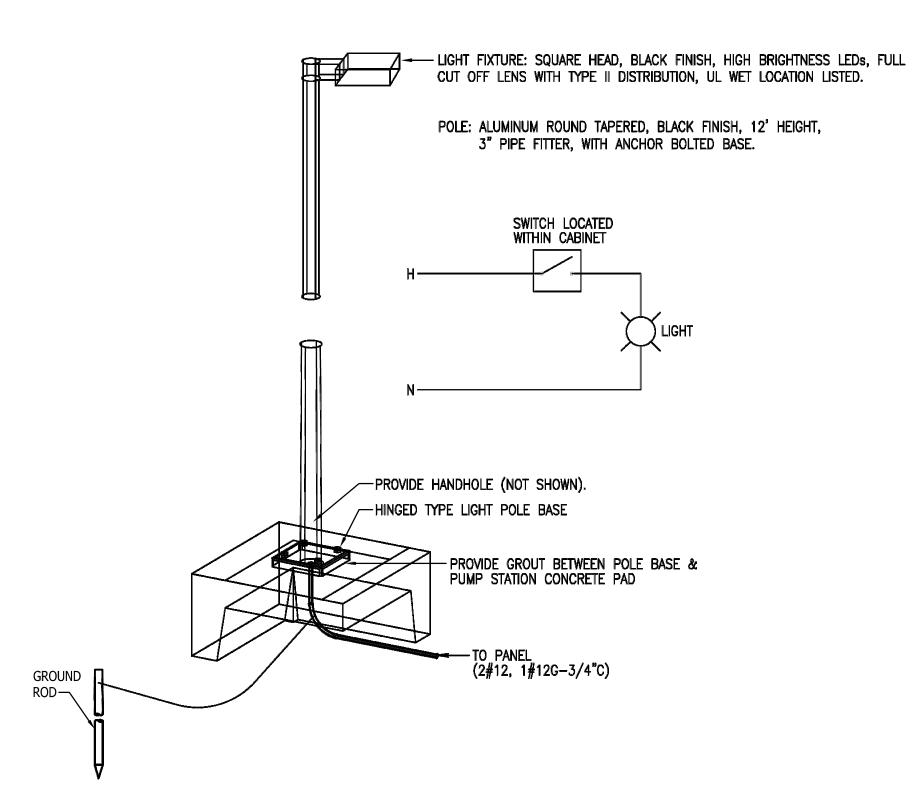

120 VOLTS FROM PANEL LC

CIRCUIT NO. 9

- INPUT CONTROL FROM

— THERMAL STARTER

AT FAN

PCP/PLC

LOCATED IN PCP


DETAIL - SITE LIGHT - SCED DETAIL E-2 (REV. 12/21)

PANEL SCHEDULE: "LC" 240/120V., 1 PHASE, 3 WIRE									
CIRC. NO.	FOR	BREAKERS			CIRC.	FOD	BREAKERS		
		FRM.	Р	TRIP	NO.	FOR	FRM.	Р	TRIP
1	S.E.C. LIGHTS	100	1	20	2	PCP	100	1	20
3	S.E.C. RECEPTACLE	100	1	20	4	SPARE	100	1	20
5	S.E.C. HEATERS	100	1	20	6	GEN. BLOCK HEATER	100	1	20
7	S.E.C. COOLING FANS	100	1	20	8	GEN. BATTERY CHARGER	100	1	20
9	W.W. SUPPLY FAN	100	1	20	10	SITE LIGHT	100	1	20
11	SPACE W/BUS	-	1	-	12	SPACE W/BUS	-	1	-
13	SPACE W/BUS	-	1	-	14	SPACE W/BUS	-	1	-
	1	1	l		1			1	

- 1 - 16 SPACE W/BUS

PROVIDE 900 MHZ - YAGI ANTENNA - SEE NOTE 4 BELOW

PROFESSIONAL **CERTIFICATION:** I HEREBY CERTIFY THAT THESE DOCUMENTS WERE PREPARED OR APPROVED BY ME, AND THAT I AM A DULY LICENSED PROFESSIONAL ENGINEER UNDER THE LAWS OF THE STATE OF DELAWARE, LICENSE No. 17123, EXPIRATION DATE: 06/30/2026.

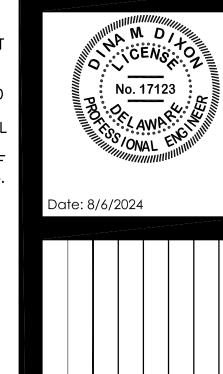

solutions

Engineering & Management, LLC


ww.solutionsipem.com Copyright © 202

Georgetown, DE 1994 T. 302.297.92

3003 Merritt Mill Roc

Sa**l**isbury, MD 21804 T. 410.572.883

Integrated Planning

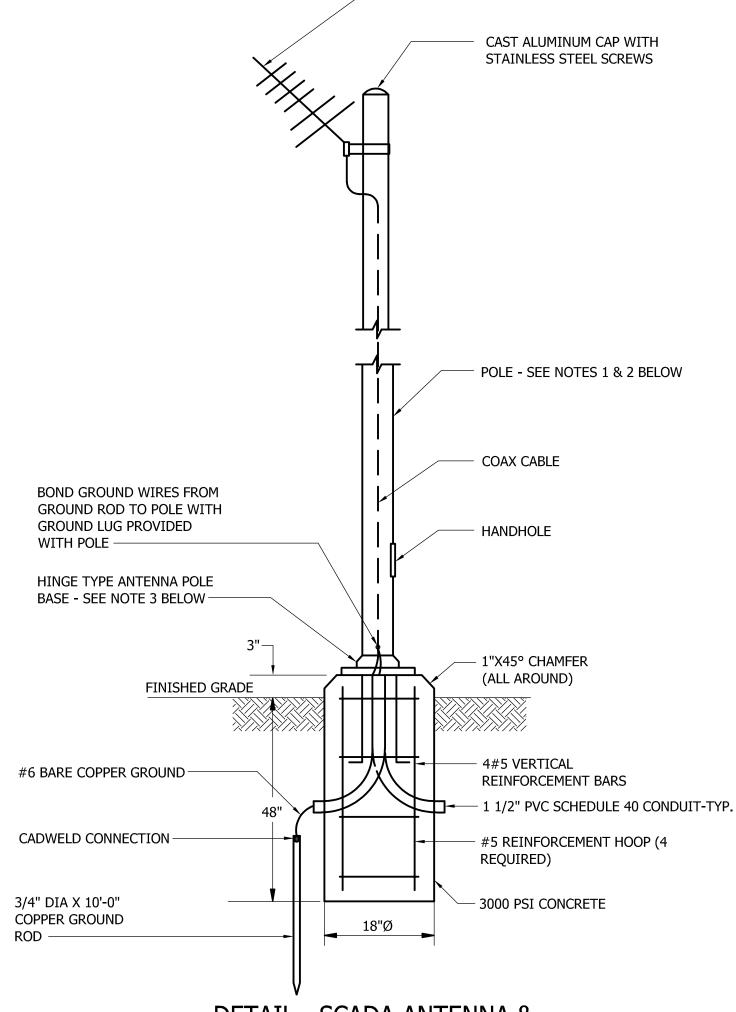

DETAIL - SCADA ANTENNA & POLE/FOUNDATION SCALE: NONE

SCED DETAIL I-13 (4/25/2023)

<u>NOTES</u>

15 | SPACE W/BUS

POWER RELAY

- 1. POLE HEIGHT WILL SHALL BE 20'-40' AND SHALL BE DETERMINED BY THE COUNTY DURING CONSTRUCTION AFTER COORDINATES HAVE BEEN SUBMITTED AND A RADIO PATH REPORT HAS BEEN COMPLETED BY THE COUNTY.
- 2. POLES SHALL BE HINGED ALUMINUM FOR ANTENNA HEIGHTS 20' AND BELOW. POLES
- SHALL BE NON HINGED ALUMINUM FOR ANTENNA HEIGHTS GREATER THAN 20'.
- 3. MOUNTING STUDS SHALL BE POURED INTO CONCRETE BASE PER MANUFACTURES
- RECOMMENDATIONS. LAGS OR DRIVE PINS WILL NOT BE PERMITTED. 4. THE CONTRACTOR SHALL ADJUST THE DIRECTION OF THE ANTENNA AS DIRECTED BY THE

Gipe Associates, Inc. consulting Engineers 1220 East Joppa Road, Suite 102 Towson, Maryland 21286
Baltimore, Maryland
Easton, Maryland
W.O.# 24039

"THIS DRAWING AND THE DESIGN AND CONSTRUCTION FEATURES DISCLOSED ARE PROPRIETARY TO GIPE ASSOCIATES, INC. AND SHALL NOT BE ALTERED OR REUSED IN WHOLE OR IN PART WITHOUT THE EXPRESS WRITTEN PERMISSION OF GIPE

ASSOCIATES, INC. Copyright © 2024"

ARD

Sheet No.:

File Name:

E-12

G21074-PUMPSTAITON