


	 PE	
ALL DIMENSIONS MUST BE VERIFIED BY CONTRACTOR AND OWNER MUST BE NOTIFIED OF ANY DISCREPANCIES BEFORE PROCEEDING WITH WORK		

ALL DOCUMENTS PREPARED BY PENNONI ASSOCIATES ARE INSTRUMENTS OF SERVICE IN RESPECT OF THE PROJECT. THEY ARE NOT INTENDED OR REPRESENTED TO BE SUITABLE FOR REUSE BY OWNER OR OTHERS ON THE EXTENSIONS OF THE PROJECT OR ON ANY OTHER PROJECT. ANY REUSE WITHOUT WRITTEN VERIFICATION OR ADAPTATION BY PENNONI ASSOCIATES FOR THE SPECIFIC PURPOSE INTENDED WILL BE AT OWNERS
SOLE RISK AND WITHOUT LIABILITY OR LEGAL EXPOSURE TO PENNONI ASSOCIATES; AND OWNER SHALL INDEMNIFY AND HOLD HARMLESS PENNONI ASSOCIATES FROM ALL CLAIMS, DAMAGES, LOSSES ANI EXPENSES ARISING OUT OF OR RESULTING THEREFROM

RIBER21006 2024-05-29 1" = 100' DTR

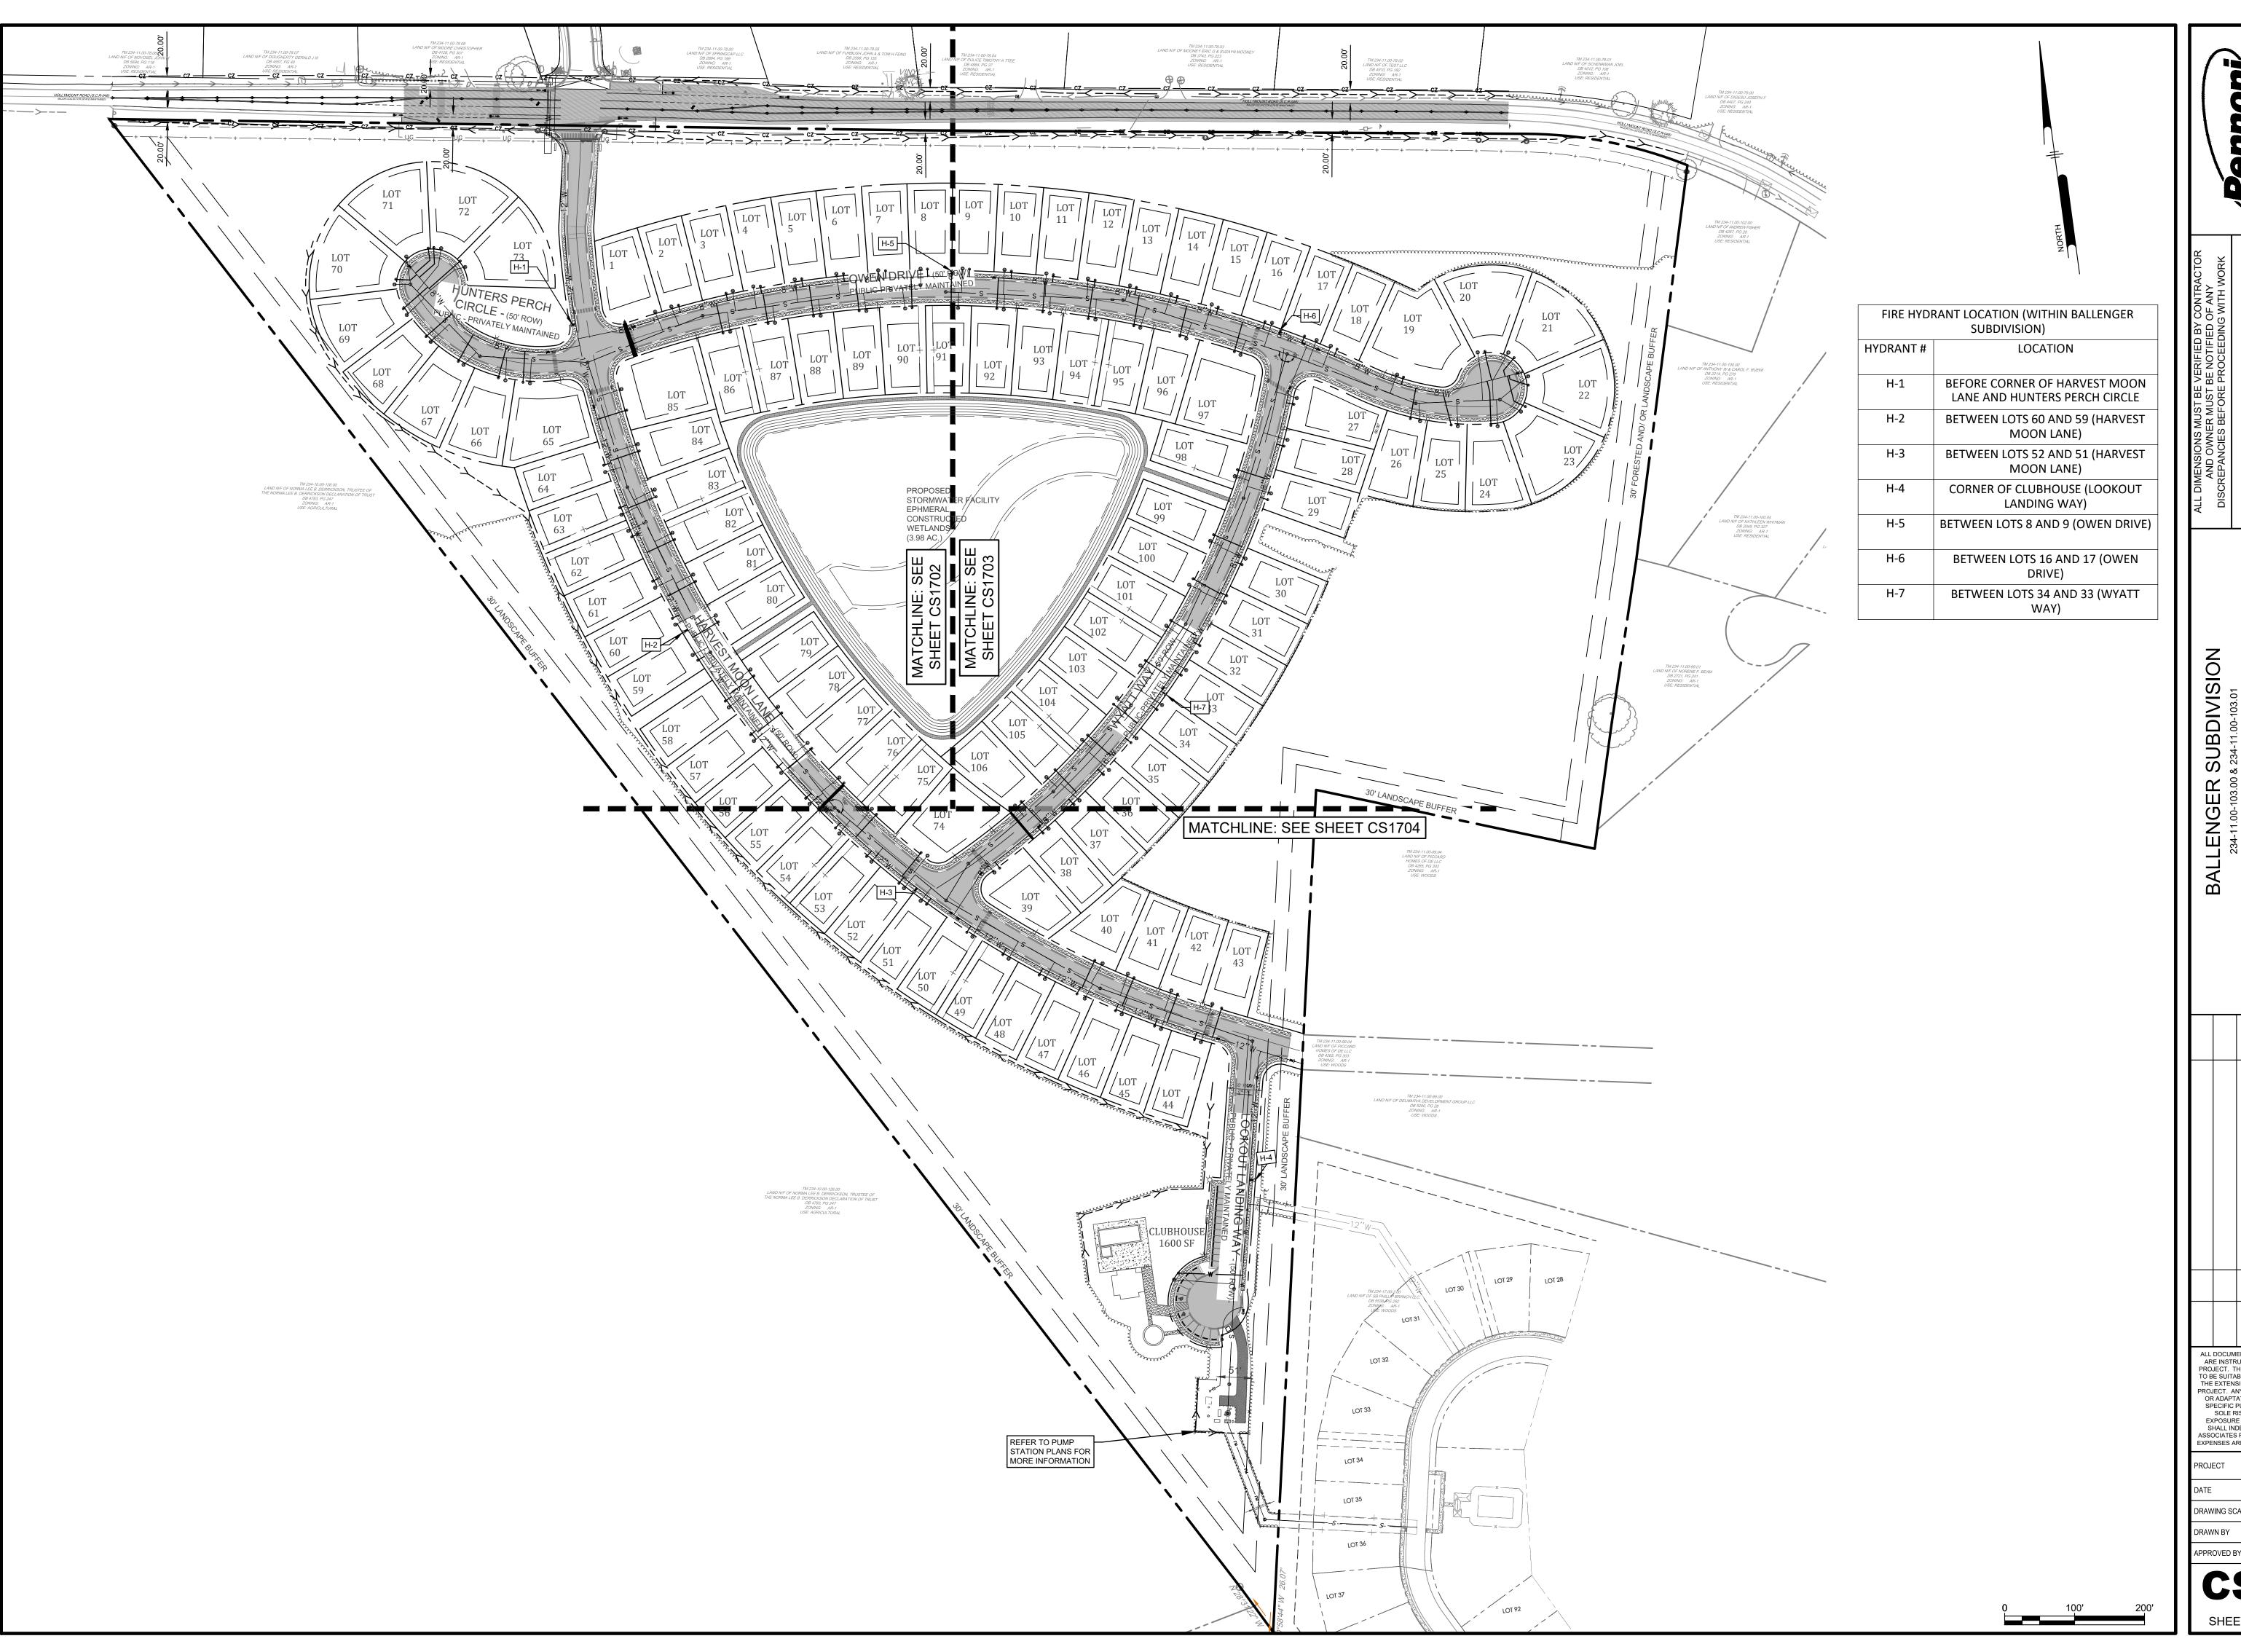


ALL DOCUMENTS PREPARED BY PENNONI ASSOCIATES ARE INSTRUMENTS OF SERVICE IN RESPECT OF THE PROJECT. THEY ARE NOT INTENDED OR REPRESENTED TO BE SUITABLE FOR REUSE BY OWNER OR OTHERS ON THE EXTENSIONS OF THE PROJECT OR ON ANY OTHER PROJECT. ANY REUSE WITHOUT WRITTEN VERIFICATION OR ADAPTATION BY PENNONI ASSOCIATES FOR THE SPECIFIC PURPOSE INTENDED WILL BE AT OWNERS SOLE RISK AND WITHOUT LIABILITY OR LEGAL EXPOSURE TO PENNONI ASSOCIATES; AND OWNER SHALL INDEMNIFY AND HOLD HARMLESS PENNONI ASSOCIATES FROM ALL CLAIMS, DAMAGES, LOSSES AND EXPENSES ARISING OUT OF OR RESULTING THEREFROM

RIBER21006 2024-05-29 1"= 100'

**CS1700** 

	SA	NITARY SEWER STRUCTUR	RE TABLE	
ID	RIM ELEVATION	INV IN (FROM)	INV OUT (TO)	TY
MH-1	23.00	8.96 ( 8" DIP CL52 @ 0.28%) MH-2	8.86 (10" DIP) WW-1	48"
MH-2	25.94	9.44 ( 8" DIP CL52 @ 0.28%) MH-3	9.34 (8" DIP) MH-1	48"
MH-3	24.44	10.52 ( 8" SDR-26 PVC @ 0.28%) MH-4	10.42 (8" DIP) MH-2	48"
MH-4	23.63	11.26 ( 8" SDR-26 PVC @ 0.28%) MH-5	11.16 (8" SDR-26) MH-3	48"
MH-5	23.29	12.07 ( 8" SDR-26 PVC @ 0.28%) MH-6 12.08 ( 8" SDR-26 PVC @ 0.28%) MH-14	11.97 (8" SDR-26) MH-4	48"
MH-6	22.07	12.75 ( 8" SDR-26 PVC @ 0.28%) MH-7	12.65 (8" SDR-26) MH-5	48"
MH-7	23.03	13.65 ( 8" SDR-26 PVC @ 0.28%) MH-8	13.55 (8" SDR-26) MH-6	48"
MH-8	22.53	14.49 ( 8" SDR-26 PVC @ 0.28%) MH-9	14.39 (8" SDR-26) MH-7	48"
MH-9	23.34	15.11 ( 8" SDR-26 PVC @ 0.28%) MH-10 15.11 ( 8" SDR-26 PVC @ 0.28%) MH-12	15.01 (8" SDR-26) MH-8	48"
MH-10	23.23	15.54 ( 8" SDR-26 PVC @ 0.40%) MH-11	15.54 (8" SDR-26) MH-9	48"
MH-11	23.72		16.11 (8" SDR-26) MH-10	48"
MH-12	22.45	15.71 ( 8" SDR-26 PVC @ 0.40%) MH-13	15.61 (8" SDR-26) MH-9	48"
MH-13	22.31		16.97 (8" SDR-26) MH-12	48"
MH-14	22.51	12.35 ( 8" SDR-26 PVC @ 0.28%) MH-15	12.25 (8" SDR-26) MH-5	48"
MH-15	21.83	12.90 ( 8" SDR-26 PVC @ 0.28%) MH-16	12.80 (8" SDR-26) MH-14	48"
MH-16	21.85	13.37 ( 8" SDR-26 PVC @ 0.28%) MH-17	13.37 (8" SDR-26) MH-15	48"
MH-17	21.37	13.86 ( 8" SDR-26 PVC @ 0.28%) MH-18	13.76 (8" SDR-26) MH-16	48"
MH-18	21.28	14.54 ( 8" SDR-26 PVC @ 0.28%) MH-19	14.42 (8" SDR-26) MH-17	48"
MH-19	22.29	15.24 ( 8" SDR-26 PVC @ 0.28%) MH-20 15.24 ( 8" SDR-26 PVC @ 0.96%) MH-22	15.14 (8" SDR-26) MH-18	48"
MH-20	21.43	16.03 ( 8" SDR-26 PVC @ 0.40%) MH-21	15.93 (8" SDR-26) MH-19	48"
MH-21	22.17		17.05 (8" SDR-26) MH-20	48"
MH-22	22.50	17.23 ( 8" SDR-26 PVC @ 0.59%) MH-23	17.13 (8" SDR-26) MH-19	48"
MH-23	22.99		17.94 (8" SDR-26) MH-22	48"
MH-24	24.07		14.12 (8" SDR-26)	48"
WW-1	23.08	8.25 ( 10" DIP CL52 @ 1.46%) MH-1		60"

ID	FROM	INV OUT	TO	INV IN	DIAMETER	MATERIAL	LENGTH	SLOPE
	STRUCTURE	1144 001	STRUCTURE	114 V 114	(in)	IVIATEINIAE	(ft)	OLOI L
SS-1	MH-11	16.11	MH-10	15.54	8"	SDR-26 PVC	142.98'	0.40%
SS-2	MH-10	15.54	MH-9	15.11	8"	SDR-26 PVC	154.21'	0.28%
SS-3	MH-9	15.01	MH-8	14.49	8"	SDR-26 PVC	187.29'	0.28%
SS-4	MH-8	14.39	MH-7	13.65	8"	SDR-26 PVC	264.24'	0.28%
SS-5	MH-7	13.55	MH-6	12.75	8"	SDR-26 PVC	284.90'	0.28%
SS-6	MH-6	12.65	MH-5	12.07	8"	SDR-26 PVC	206.96'	0.28%
SS-7	MH-5	11.97	MH-4	11.26	8"	SDR-26 PVC	253.79'	0.28%
SS-8	MH-4	11.16	MH-3	10.52	8"	SDR-26 PVC	230.37'	0.28%
SS-9	MH-3	10.42	MH-2	9.44	8"	DIP CL52	355.27'	0.28%
SS-10	MH-2	9.34	MH-1	8.96	8"	DIP CL52	136.64'	0.28%
SS-11	MH-1	8.86	WW-1	8.25	10"	DIP CL52	41.71'	1.46%
SS-12	MH-21	17.05	MH-20	16.03	8"	SDR-26 PVC	253.93'	0.40%
SS-13	MH-20	15.93	MH-19	15.24	8"	SDR-26 PVC	246.96'	0.28%
SS-14	MH-19	15.14	MH-18	14.54	8"	SDR-26 PVC	215.53'	0.28%
SS-15	MH-18	14.42	MH-17	13.86	8"	SDR-26 PVC	198.00'	0.28%
SS-16	MH-17	13.76	MH-16	13.37	8"	SDR-26 PVC	140.98'	0.28%
SS-17	MH-16	13.37	MH-15	12.90	8"	SDR-26 PVC	165.33'	0.28%
SS-18	MH-15	12.80	MH-14	12.35	8"	SDR-26 PVC	159.08'	0.28%
SS-19	MH-14	12.25	MH-5	12.08	8"	SDR-26 PVC	61.47'	0.28%
SS-20	MH-23	17.94	MH-22	17.23	8"	SDR-26 PVC	120.34'	0.59%
SS-21	MH-22	17.13	MH-19	15.24	8"	SDR-26 PVC	197.09'	0.96%
SS-22	MH-13	16.97	MH-12	15.71	8"	SDR-26 PVC	314.66'	0.40%
SS-23	MH-12	15.61	MH-9	15.11	8"	SDR-26 PVC	177.49'	0.28%
SS-24	MH-24	14.12		13.81	8"	C900 PVC FM	48.63'	0.64%

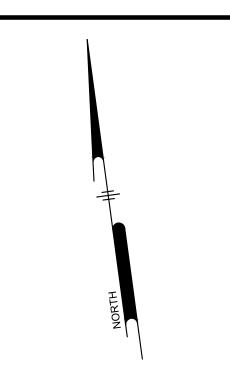

## **SITE INFORMATION:**

SITE ADDRESS:
30558 HOLLYMOUNT ROAD
HARBESON, DE 19951

OWNER ADDRESS:
WARRINGTON ALTON F. HEIRS
31160 EDGEWATER DRIVE

LEWES, DE 19958

DEVELOPER ADDRESS:
RIBERA DEVELOPMENT, LLC.
8684 VETERANS HIGHWAY, SUITE 203
MILLERSVILLE, MD 21108

ENGINEER:
PENNONI ASSOCIATES, INC.
18072 DAVIDSON DRIVE
MILTON, DE 19968

## **UTILITY NOTES:**

- ALL WORK SHALL COMPLY WITH APPLICABLE STATE, FEDERAL AND LOCAL CODES. ALL NECESSARY LICENSES AND PERMITS SHALL BE OBTAINED BY THE CONTRACTOR AT HIS EXPENSE UNLESS PREVIOUSLY OBTAINED BY THE OWNER.
- THE CONTRACTOR SHALL IMMEDIATELY INFORM THE ENGINEER OF ANY DISCREPANCIES OR ERRORS THEY DISCOVER IN THE PLAN.
- UTILITIES ENTER THE PREMISES FROM PUBLIC STREETS OR RIGHTS OF WAY.
   PROPOSED UTILITY SERVICE AND CONNECTIONS (SANITARY SEWERS) SUBJECT TO FINAL DESIGN AND
- APPROVAL.

  5. CONTRACTOR SHALL MAINTAIN A MINIMUM OF 10' HORIZONTAL SEPARATION BETWEEN THE WATER AND SEWER
- 5. CONTRACTOR SHALL MAINTAIN A MINIMUM OF TO HORIZONTAL SEPARATION BETWEEN THE WATER AND SEWER MAINS.
   6. ALL FIRE LANES, FIRE HYDRANTS, AND FIRE DEPARTMENT CONNECTIONS SHALL BE MARKED IN ACCORDANCE
- WITH THE STATE FIRE PREVENTION REGULATIONS.

  7. PROVIDE A FLOW TEST ON NEW HYDRANT TO FIRE MARSHALL ONCE IT HAS BEEN INSTALLED AND PRIOR TO OPERATIONS.
- OPERATIONS.

  8. THE DISTANCE BETWEEN THE FIRE HYDRANT AND THE FIRE LANE SHALL NOT BE GREATER THAN SEVEN FEET.

  8.1 THE STEAMER CONNECTION OF ALL FIRE HYDRANTS SHALL BE SO POSITIONED SO AS TO BE FACING THE
- 8.1. THE STEAMER CONNECTION OF ALL FIRE HYDRANTS SHALL BE SO POSITIONED SO AS TO BE FACING THE STREET OR FIRE LANE.
- 8.2. THE CENTER OF ALL HOSE OUTLETS ON FIRE HYDRANTS SHALL NOT BE LESS THAN 18" ABOVE FINAL GRADE.
  8.3. FIRE HYDRANTS SHALL BE COLOR CODED IN ACCORDANCE WITH THE DELAWARE STATE FIRE PREVENTION
- REGULATIONS.

  9. CONTRACTOR SHALL MAINTAIN A MINIMUM OF 18" VERTICAL SEPARATION BETWEEN THE WATER AND SEWER
- MAINS, AND A MINIMUM 12" VERTICAL SEPARATION BETWEEN STORM AND SEWER MAINS.

  10. WATER AND SEWER SERVICE WILL BE INSTALLED IN PHASES, REFER TO PHASING CONSTRUCTION PLAN, SHEET
- 10. WATER AND SEWER SERVICE WILL BE INSTALLED IN PHASES, REFER TO PHASING CONSTRUCTION PLAN, SHEET CS0901

  11. ALL FACILITIES TO MEET ARTESIAN WATER COMPANY AND ARTESIAN WASTEWATER MANAGEMENT INC.
- 11. ALL FACILITIES TO MEET ARTESIAN WATER COMPANY AND ARTESIAN WASTEWATER MANAGEMENT, IN STANDARDS AND SPECIFICATIONS.
- 12. THE PROPOSED FORCE MAIN SHALL BE INSTALLED BY OPEN CUT.13. ALL SEWER SERVICE LATERALS SHALL BE 6".
- 14. ALL WATER SERVICE CONNECTIONS FOR THE RESIDENTIAL LOTS TO BE SERVICED WITH A MINIMUM OF § LATERAL AND METER FOR DOMESTIC SERVICES AND A 2" LATERAL AND METER FOR THE PUMP STATION AND CLUBHOUSE.
   15. WATER SERVICES CANNOT BE TAPPED AT SAME LOCATION ON THE WATER MAIN. MAINTAIN 18" HORIZONTAL
- SEPARATION FOR SERVICES OF LOTS ON OPPOSITE SIDES OF THE ROAD AND ALL PIPE JOINTS.

  16. ALL SERVICES SHALL BE LOCATED 5' MINIMUM FROM LOT CORNER.
- ALL SERVICES SHALL BE LOCATED 5' MINIMUM FROM LOT CORNER.
   MAINTAIN A MINIMUM OF 5' SEPARATION BETWEEN THE WATER AND SEWER SERVICE LATERALS.
   NO OBJECTS, STANDS, DISPLAYS, OR OTHER IMPEDIMENTS SHALL BE LOCATED WITHIN THE DEMARCATION
- AREA.
  19. PROPOSED ELECTRIC AND TELECOMMUNICATION CONNECTIONS TO BE DETERMINED WITH COORDINATION
- PROPOSED ELECTRIC AND TELECOMMUNICATION CONNECTIONS TO BE DETERMINED WITH COORDINATION FROM UTILITY PROVIDERS.
   PROPOSED ONSITE FIRE HYDRANT LOCATIONS AND FIRE WATER SUPPLY LINE LOCATIONS TO BE COORDINATED
- IN THE FIELD WITH THE STATE FIRE MARSHALL.
  21. THE PROPOSED RESIDENTIAL DWELLINGS AND CLUBHOUSE SHALL NOT BE PROTECTED WITH AUTOMATIC SPRINKLERS IN ACCORDANCE WITH THE DELAWARE STATE FIRE PREVENTION REGULATIONS AND NFPA 13.

## **ARTESIAN GENERAL NOTES:**

- WATER SUPPLY BY ARTESIAN WATER COMPANY. ALL WORK AND MATERIALS SHALL BE IN ACCORDANCE WITH ARTESIAN WATER COMPANY STANDARDS AND SPECIFICATIONS.
- 2. ALL WATER MAINS SHALL BE LOCATED AT LEAST 10 FEET HORIZONTALLY FROM SANITARY SEWER AND SHALL HAVE A MINIMUM VERTICAL SEPARATION OF 18 INCHES.
- THE ENTIRE WATER DISTRIBUTION SYSTEM MUST BE IN COMPLIANCE WITH THE STANDARDS AND SPECIFICATIONS OF THE DELAWARE STATE DIVISION OF PUBLIC HEALTH.
   FIXTURE LOCATIONS SHALL BE IN ACCORDANCE WITH THE STANDARDS AND SPECIFICATIONS OF ARTESIAN
- WATER COMPANY.
  5. EXISTING UTILITIES ARE SHOWN IN ACCORDANCE WITH THE BEST AVAILABLE INFORMATION. IT SHALL BE THE
- CONTRACTOR'S RESPONSIBILITY TO VERIFY AND ALLOW FOR UTILITY LOCATION.

  6. THE CONTRACTOR SHALL TAKE ALL NECESSARY PRECAUTIONS TO PROTECT ALL EXISTING UTILITIES AND MAINTAIN UNINTERRUPTED SERVICE. ANY DAMAGE DONE TO EXISTING UTILITIES DUE TO HIS/HER NEGLIGENCE
- SHALL BE IMMEDIATELY REPAIRED AT HIS/HER EXPENSE.

  7. PLAN LOCATIONS AND DIMENSIONS SHALL BE STRICTLY ADHERED TO UNLESS OTHERWISE SPECIFIED BY
  ENCINEER THE CONTRACTOR SHALL ADJUST WATERLINE LOCATIONS AS REQUIRED TO AVOID CONFLICTS WITH
- ENGINEER. THE CONTRACTOR SHALL ADJUST WATERLINE LOCATIONS AS REQUIRED TO AVOID CONFLICTS WITH OTHER UTILITIES.

  8. THE CONTRACTOR SHALL BE RESPONSIBLE FOR REPLACEMENT OF DAMAGED OR DESTROYED LANDSCAPE.
- 9. THIS DRAWING DOES NOT INCLUDE NECESSARY COMPONENTS FOR CONSTRUCTION SAFETY. ALL CONSTRUCTION MUST BE PREFORMED IN COMPLIANCE WITH THE OCCUPATIONAL SAFETY AND HEALTH ACT OF 1970 AND ALL RULES AND REGULATIONS THERETO APPURTENANT.

  10. DISINEECTION REQUIREMENTS SHALL MEET THE STANDARDS AND SPECIFICATIONS OF THE STATE
- 10. DISINFECTION REQUIREMENTS SHALL MEET THE STANDARDS AND SPECIFICATIONS OF THE STATE ENVIRONMENTAL PROTECTION AGENCY OR EQUIVALENT TO THE AMERICAN WATER WORKS ASSOCIATION
- STANDARD C60-08.

  11. ALL PIPES SHALL HAVE A MINIMUM COVER OF 3.5 FEET.

CO. AND INSTALLED BY THE DEVELOPER AT HIS COST.

- 11. ALL PIPES SHALL HAVE A MINIMUM COVER OF 3.5 FEET.

  12. THE CONTRACTOR SHALL PROVIDE PRESSURE REDUCING VALVES IN UNITS, IF NECESSARY.

  13. THE CONTRACTOR SHALL PROVIDE BUTTRESSES FOR ALL HORIZONTAL AND VERTICAL BENDS AS REQUIRED
- PER STANDARDS AND SPECIFICATIONS OF THE ARTESIAN WATER COMPANY.


  14. EROSION CONTROL FOR WORK RELATED TO THE INSTALLATION OF WATERLINE IS THE RESPONSIBILITY OF THE
- CONTRACTOR AND SHALL BE PREFORMED IN ACCORDANCE WITH THE DELAWARE EROSION AND SEDIMENT CONTROL HANDBOOK OF JULY 2023 OR LATEST ISSUE.
- 15. THE CONTRACTOR SHALL INSTALL AIR RELEASE VALVES AS SPECIFIED IN FIELD.
  16. ALL CUL-DE-SACS TO HAVE MINIMUM 38 FOOT CLEAR PAVED RADIUS.
  17. ALL DWELLINGS ARE REQUIRED TO HAVE METER PITS WHICH ARE TO BE PURCHASED FROM ARTESIAN WATER

SEE SHEET CS6002 FOR WATER DETAILS

SEE SHEET
CS4501 FOR
WATER PROFILES

SEE SHEET
CS6003 FOR
SANITARY
SEWER DETAILS

SEE SHEET
CS4601 FOR
SANITARY
SEWER PROFILES

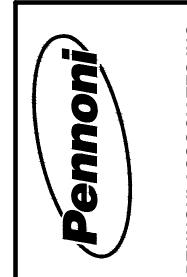

ALL DIMENSIONS MUST BE VERIFIED BY CONTRACTOR
AND OWNER MUST BE NOTIFIED OF ANY
DISCREPANCIES BEFORE PROCEEDING WITH WORK

OTES AND DETAIL
ELOPMENT, LLC

 $\mathbf{\Omega}$ 

 $\mathbf{\Omega}$ 

UTILITY PLAN NOTES
RIBERA DEVELOPM

 2024-10-07
 3
 REVISED PER ARTESIAN COMMENTS
 LFS

 2024-08-08
 2
 REVISED PER SCED COMMENTS
 LFS

 2024/07/29
 1
 REVISED PER AWMI COMMENTS
 VPL

 DATE
 NO.
 REVISIONS
 BY

ALL DOCUMENTS PREPARED BY PENNONI ASSOCIATES
ARE INSTRUMENTS OF SERVICE IN RESPECT OF THE
PROJECT. THEY ARE NOT INTENDED OR REPRESENTEL
TO BE SUITABLE FOR REUSE BY OWNER OR OTHERS OF
THE EXTENSIONS OF THE PROJECT OR ON ANY OTHER
PROJECT. ANY REUSE WITHOUT WRITTEN VERIFICATIO
OR ADAPTATION BY PENNONI ASSOCIATES FOR THE
SPECIFIC PURPOSE INTENDED WILL BE AT OWNERS
SOLE RISK AND WITHOUT LIABILITY OR LEGAL
EXPOSURE TO PENNONI ASSOCIATES; AND OWNER
SHALL INDEMNIFY AND HOLD HARMLESS PENNONI


SHALL INDEMNIFY AND HOLD HARMLESS PENNONI
ASSOCIATES FROM ALL CLAIMS, DAMAGES, LOSSES AN
EXPENSES ARISING OUT OF OR RESULTING THEREFRO


PROJECT RIBER21006

DRAWING SCALE AS SHOWN
DRAWN BY EWW

APPROVED BY AMD

IFFT 13 OF 4

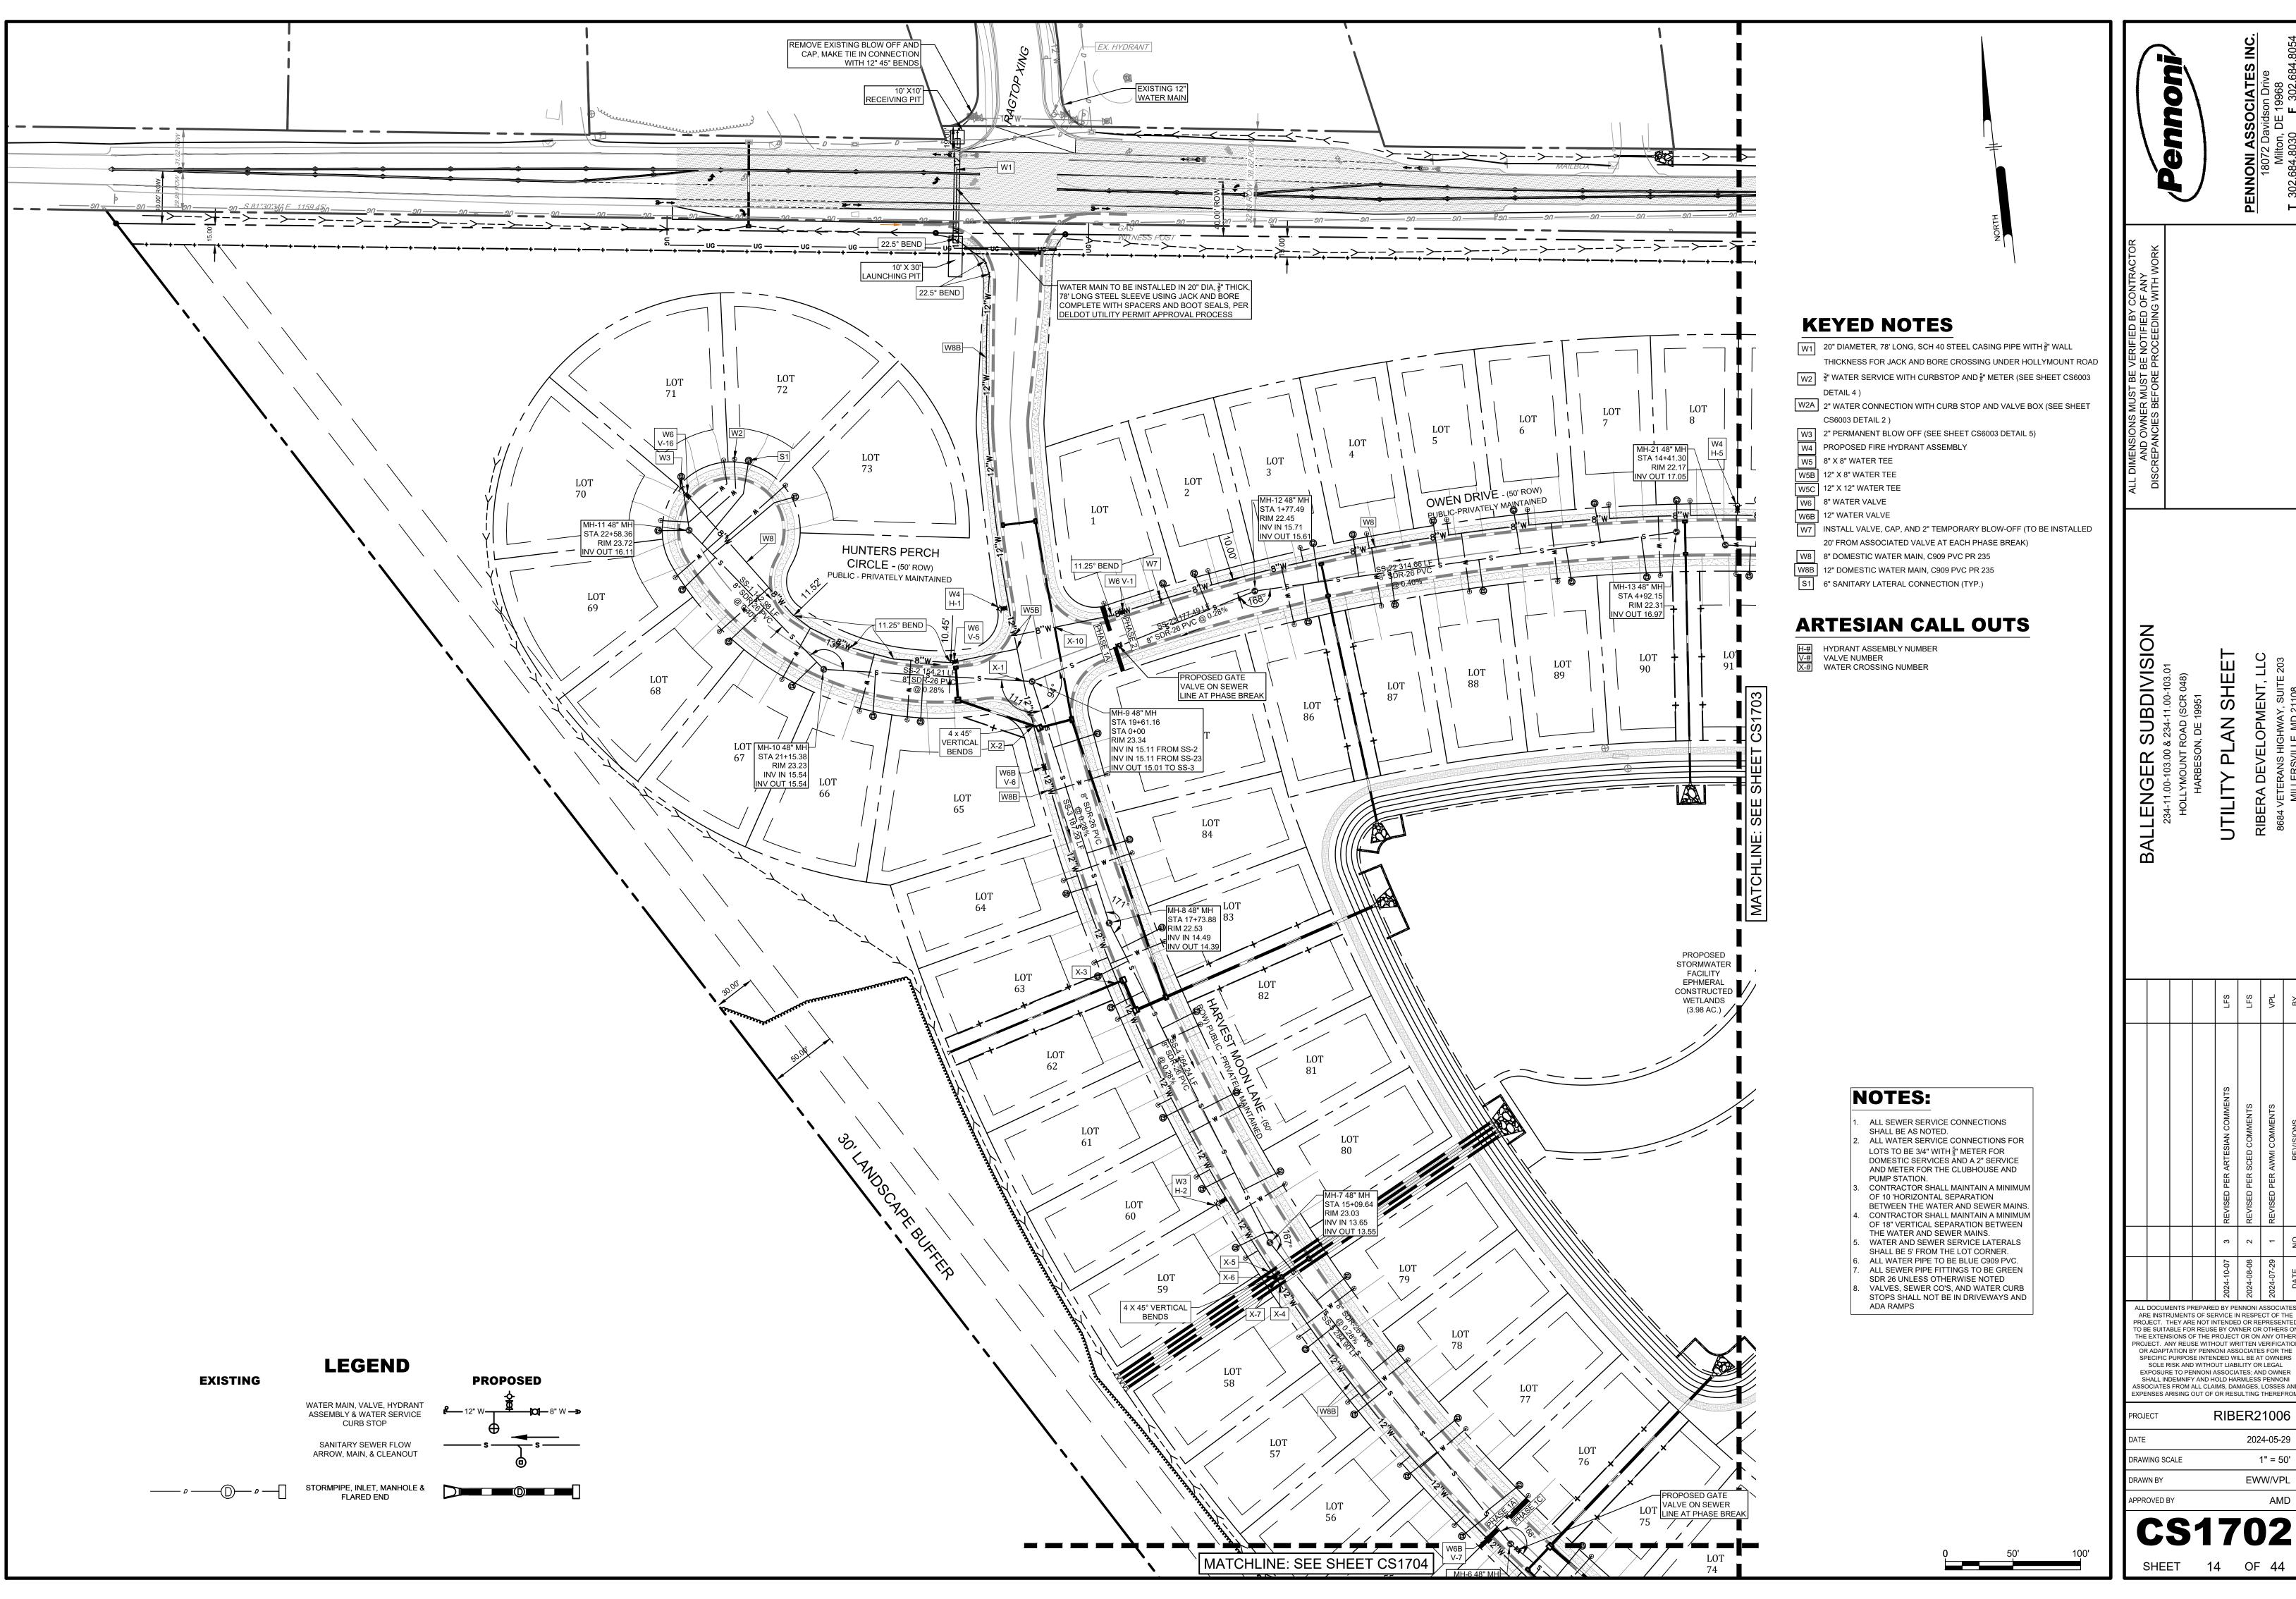


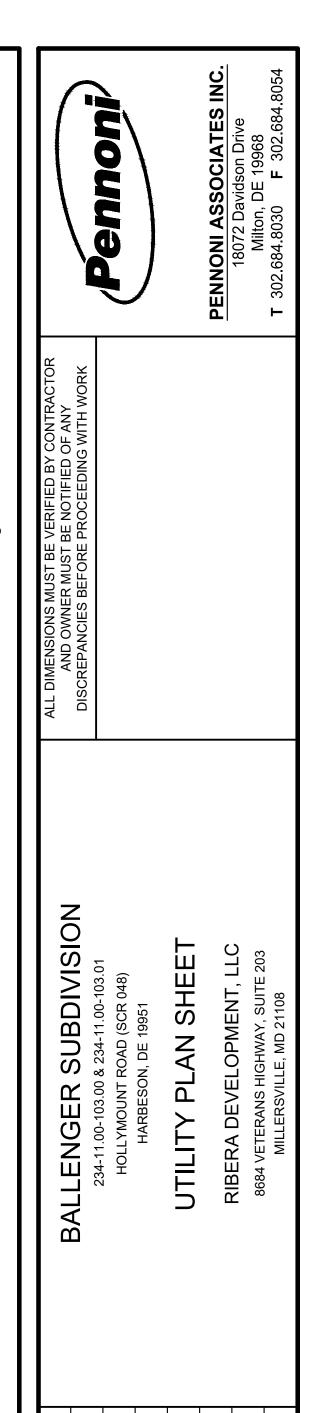



**RIBER21006** 


2024-05-29

EWW/VPL

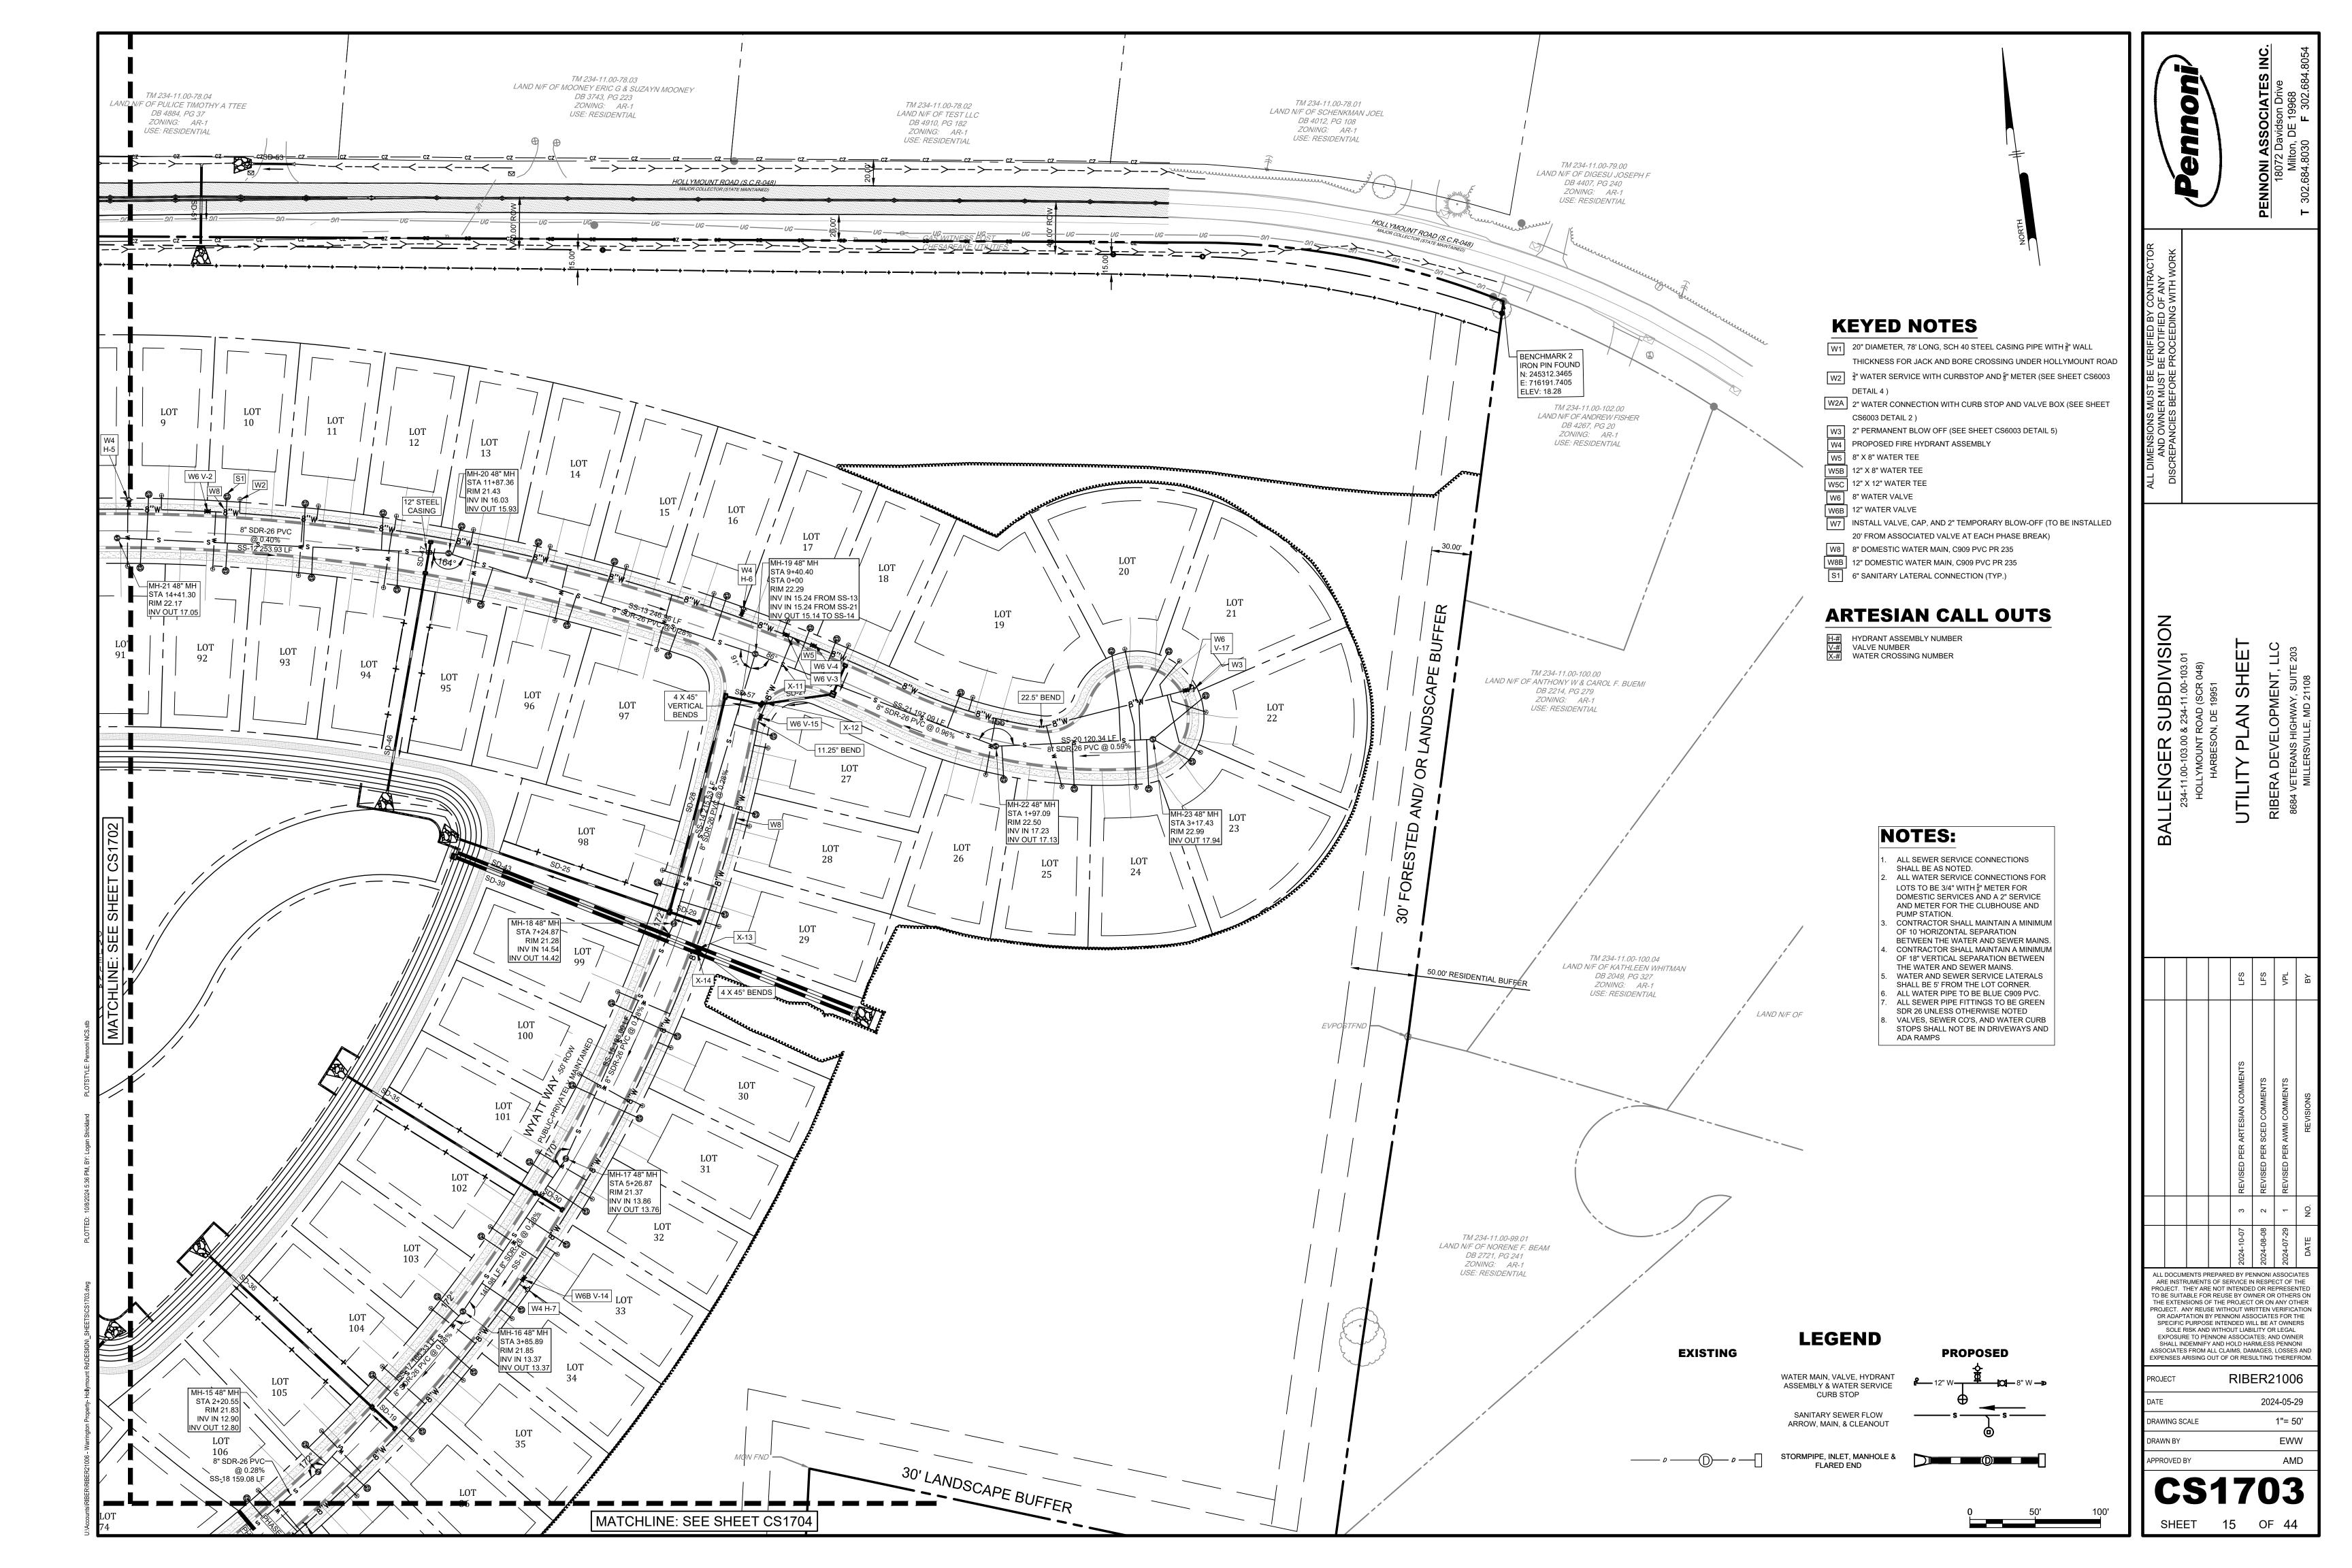

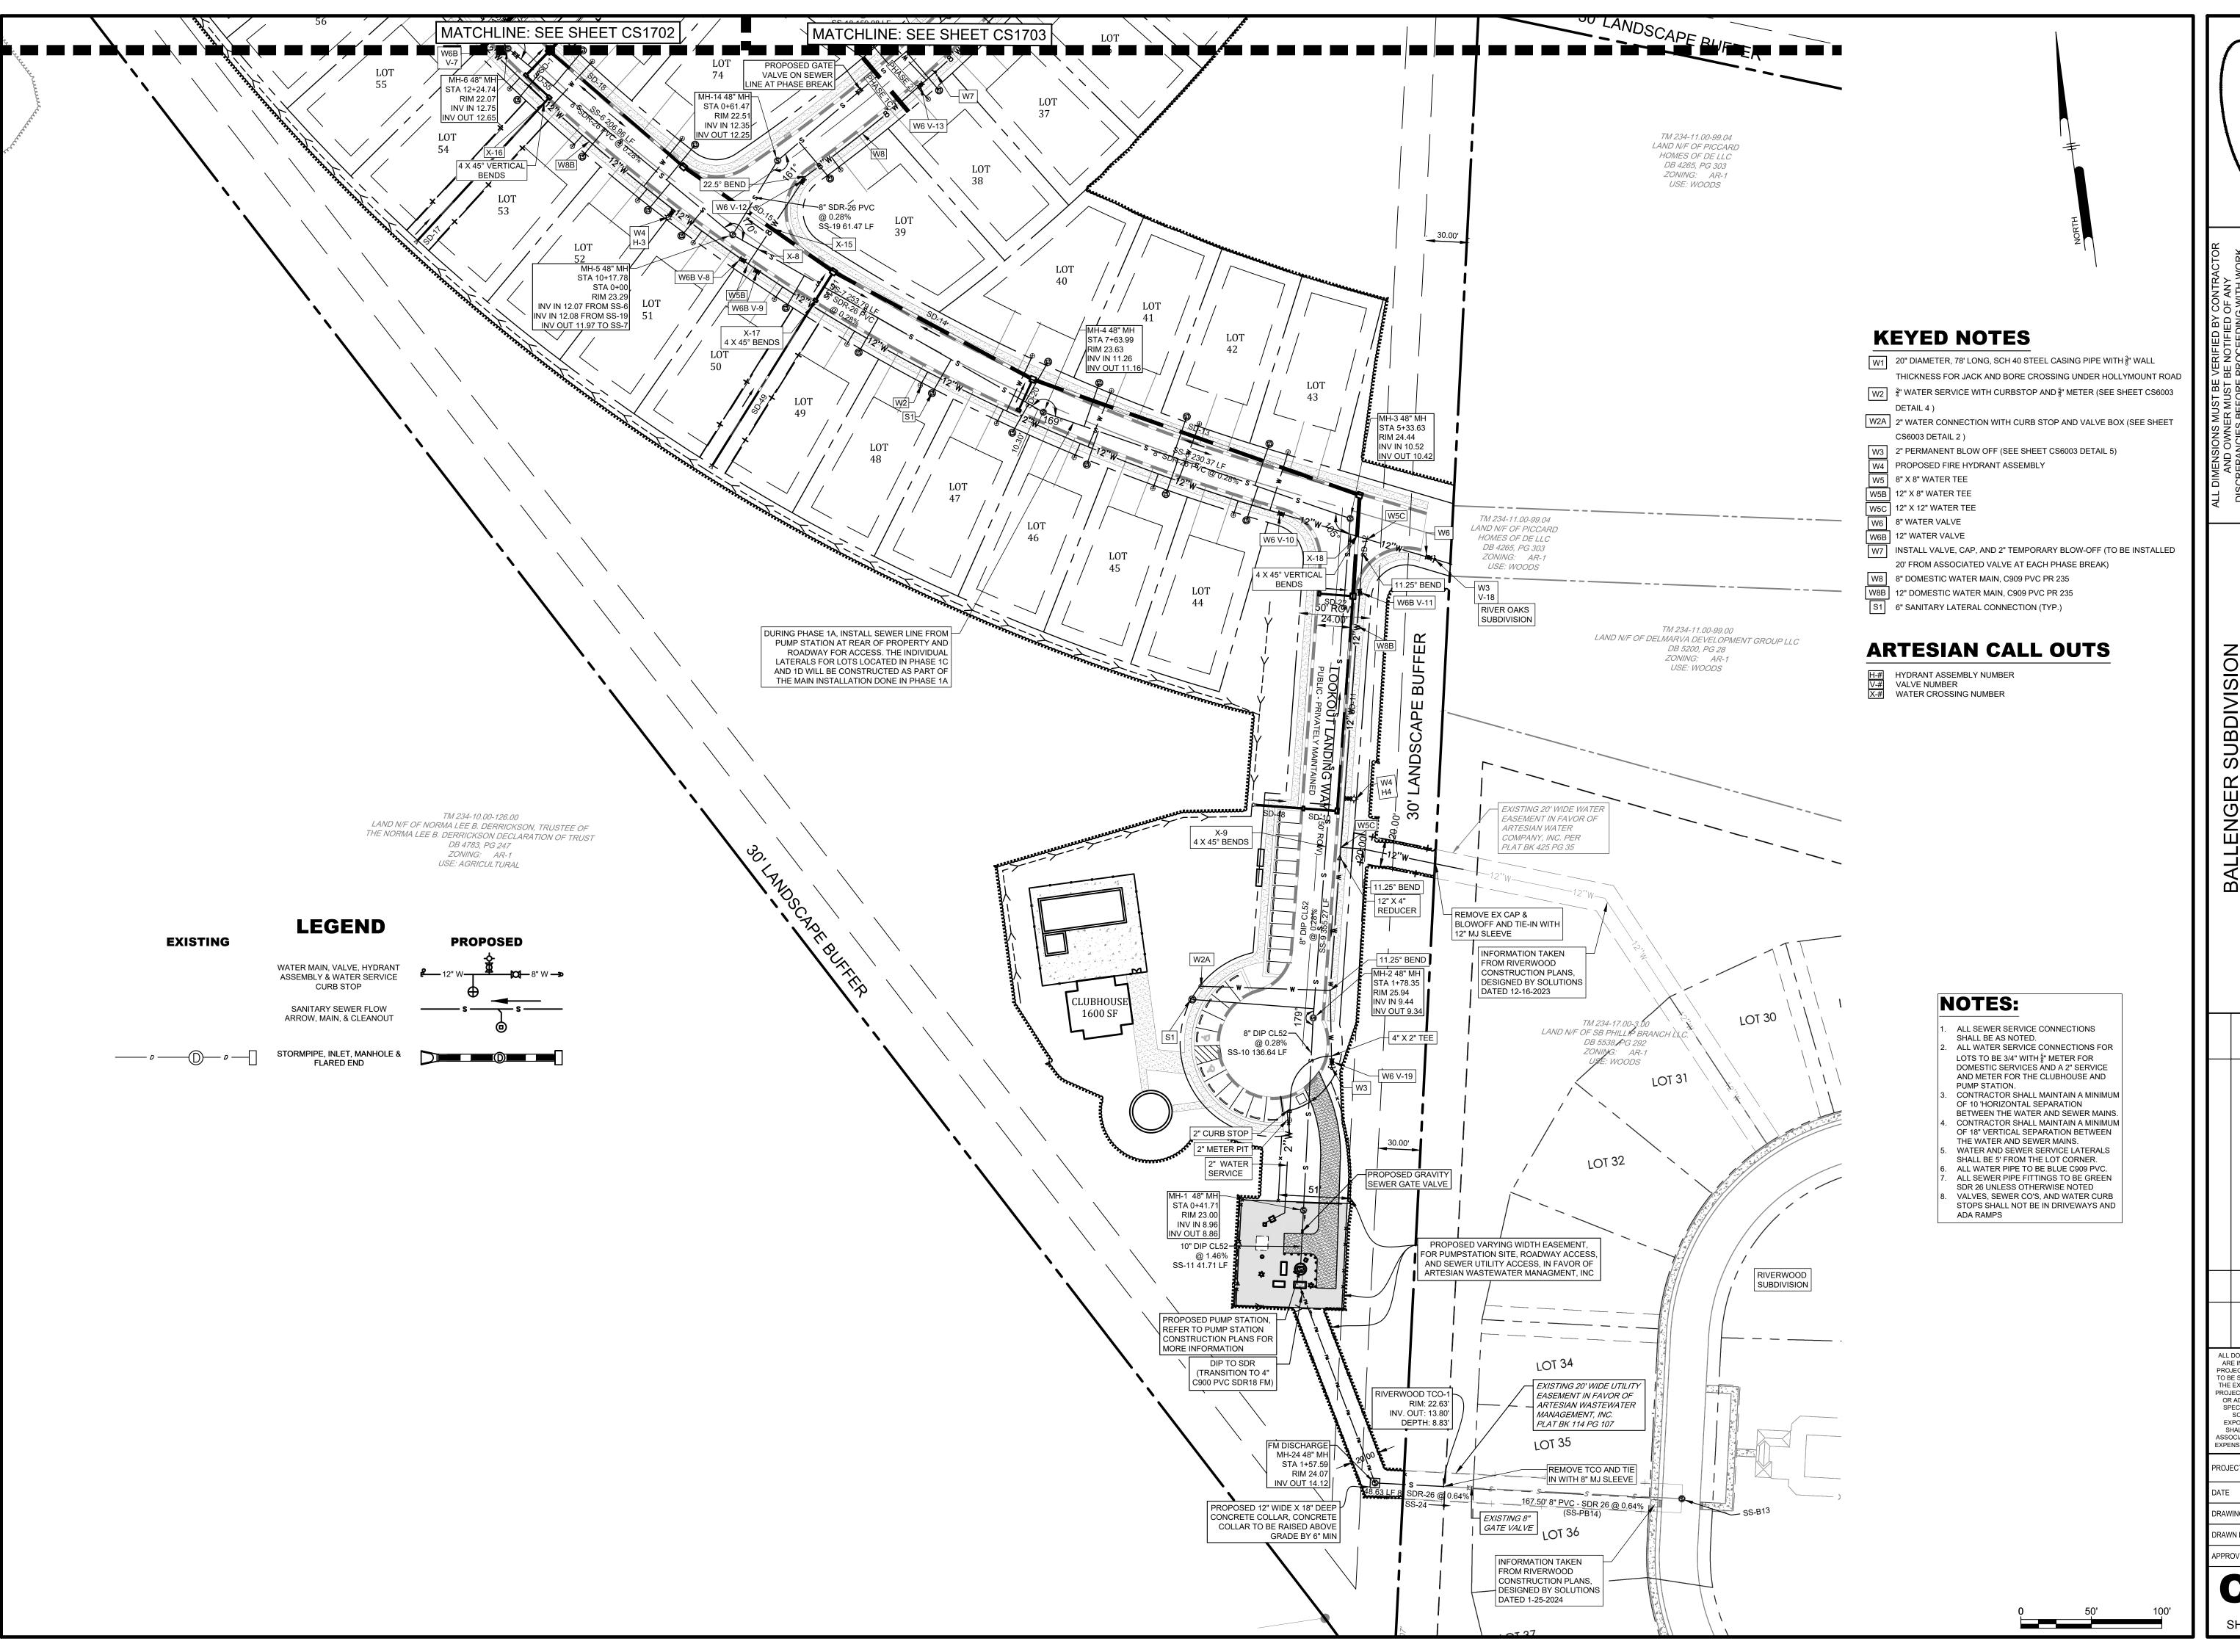

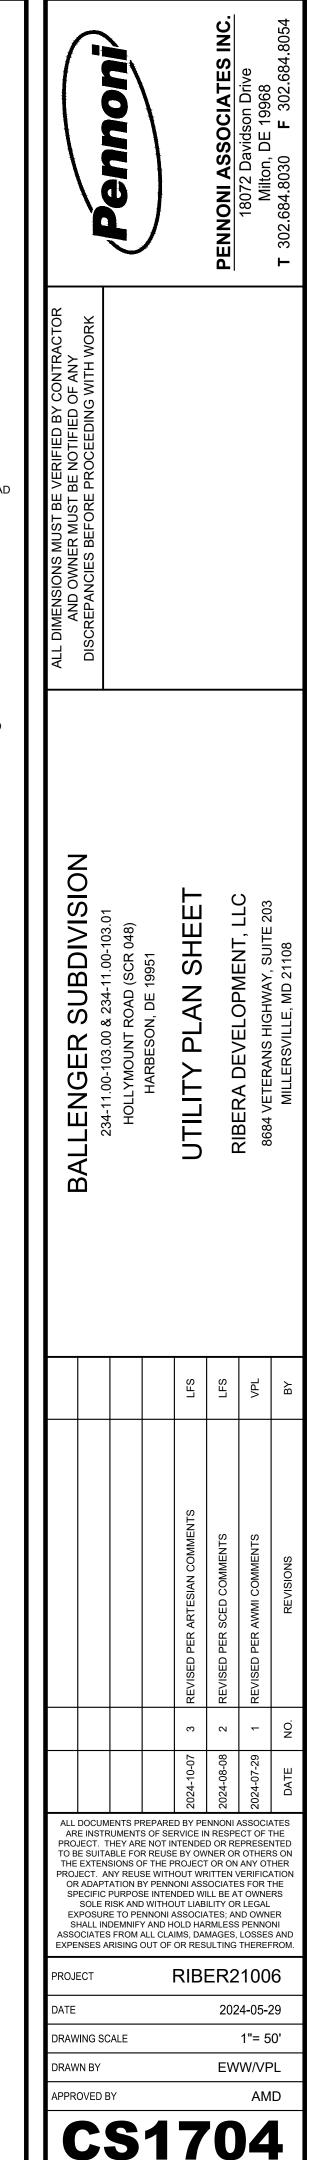

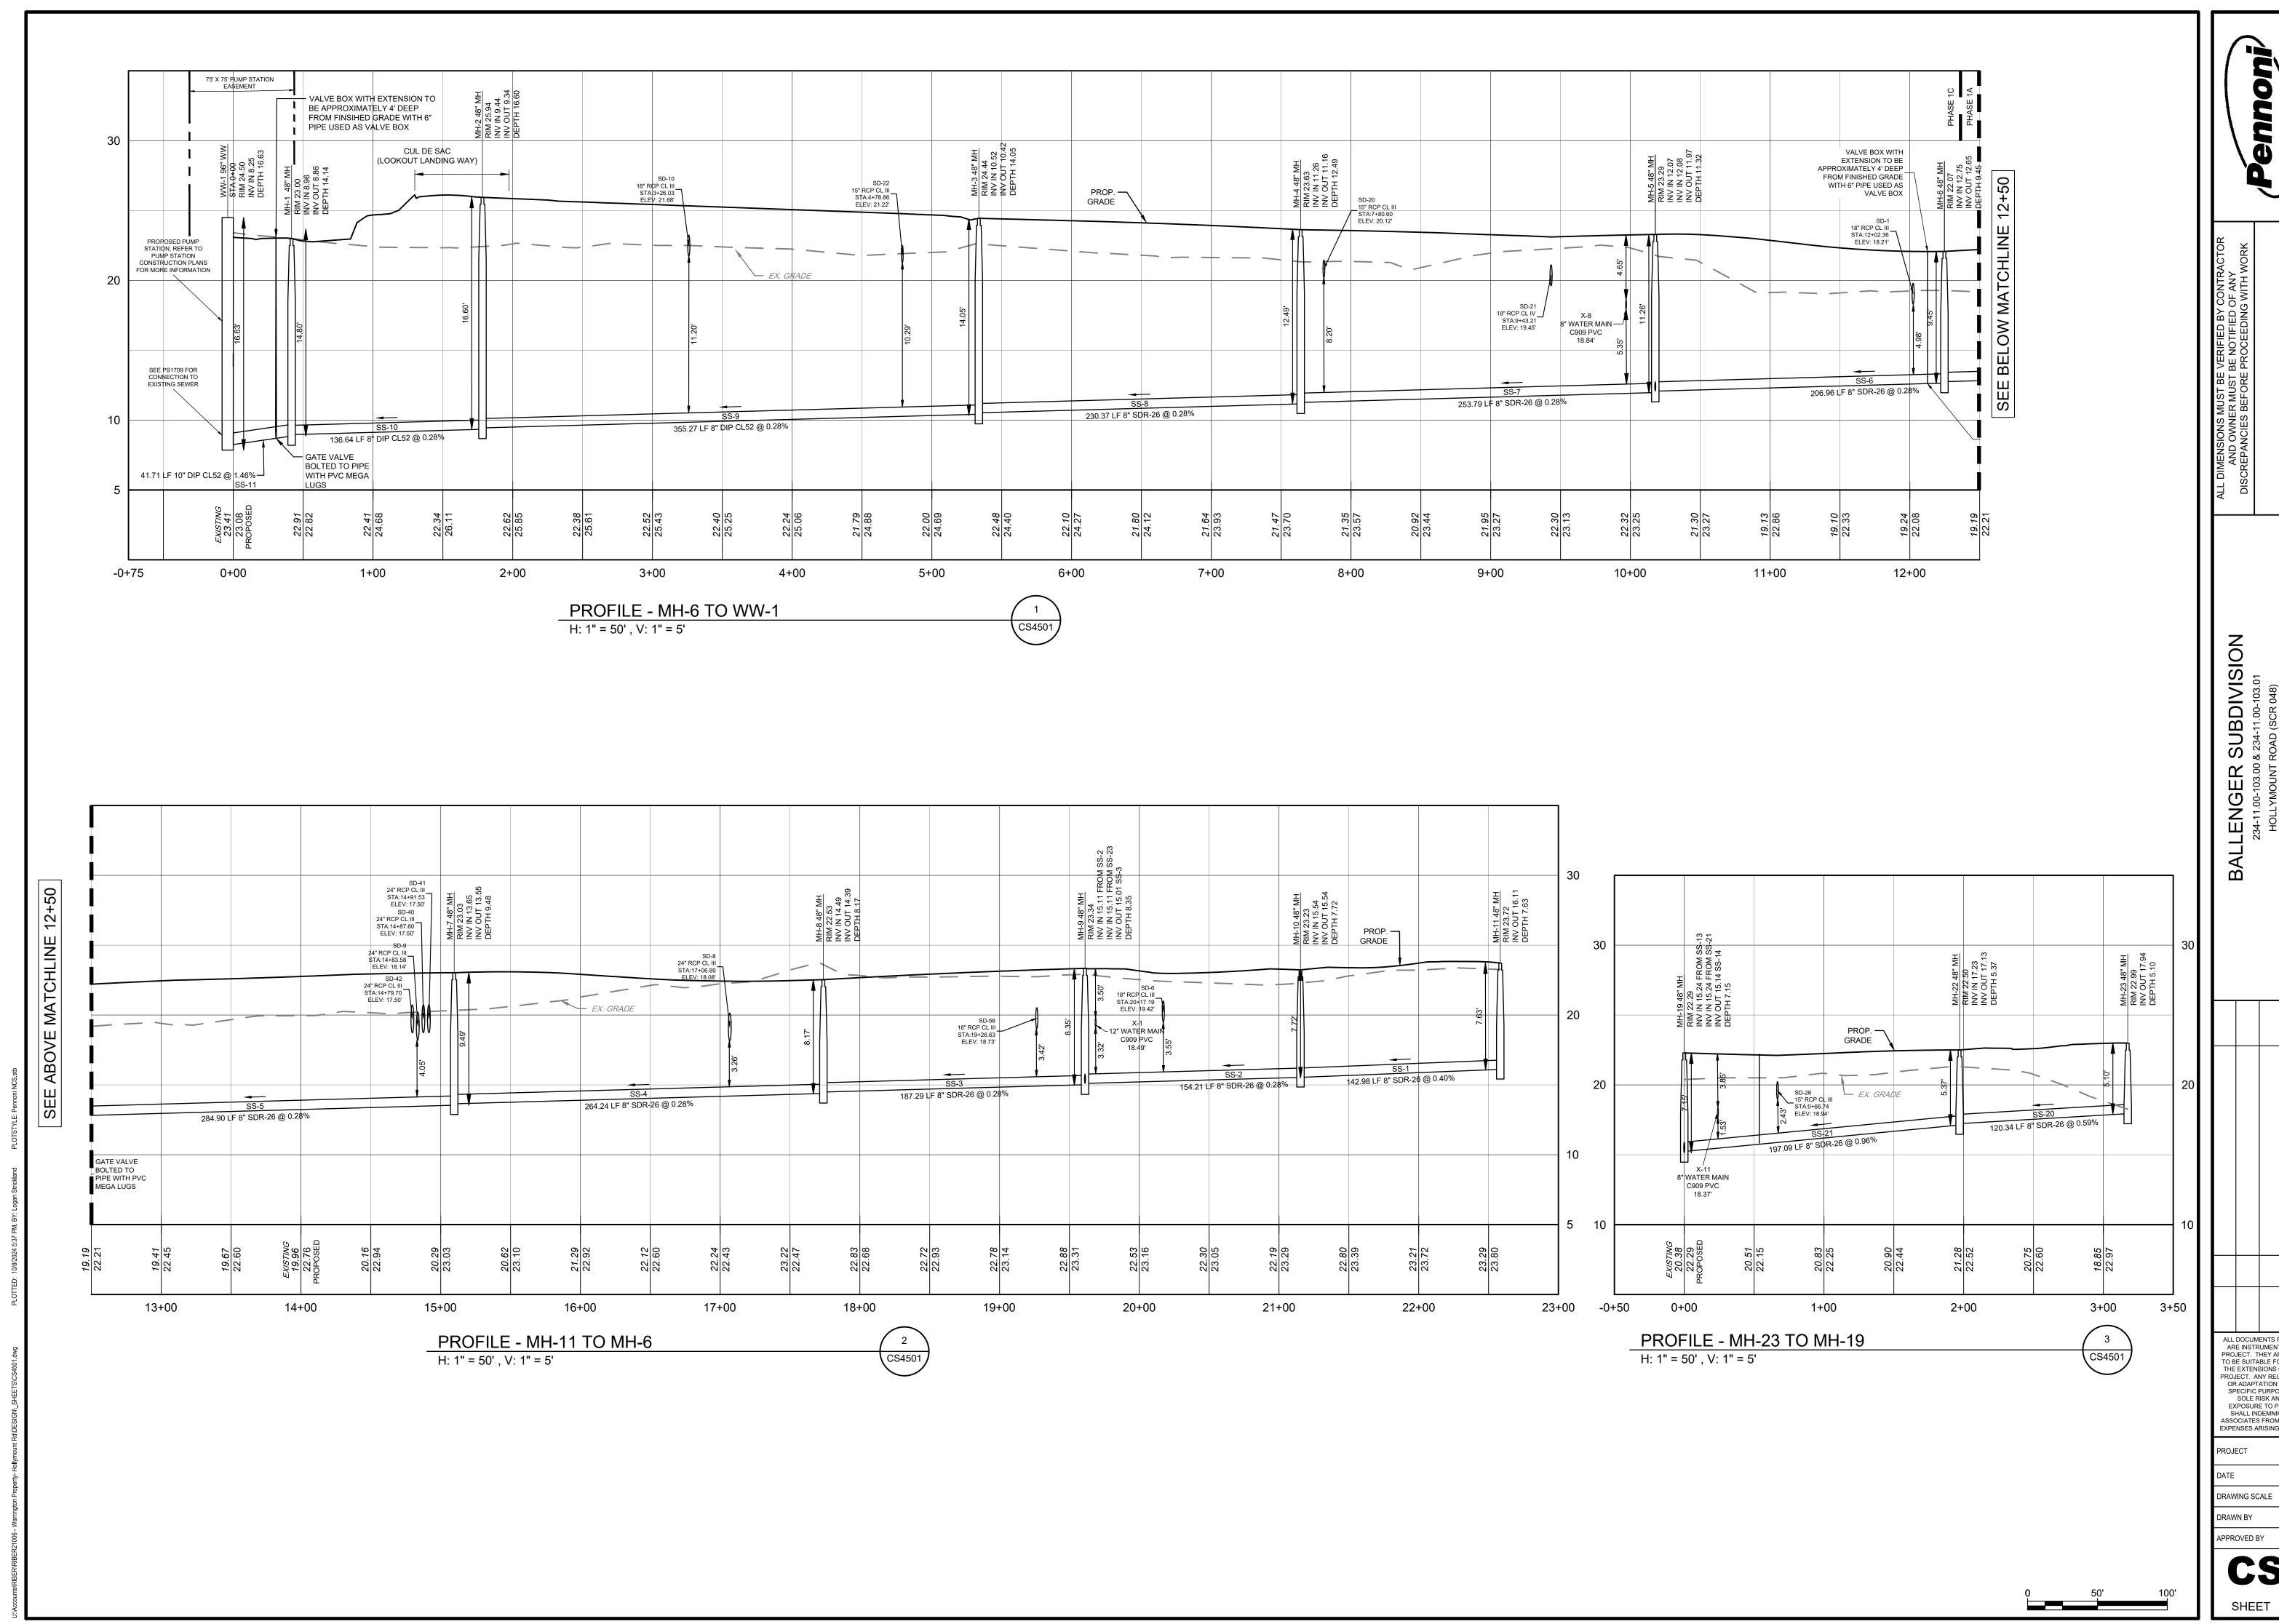

TARY

2024-10-07 3 REVISED PER ARTESIAN COMMENTS

2024-08-08 2 REVISED PER SCED COMMENTS

2024-07-29 1 REVISED PER AWMI COMMENTS

DATE

NO. REVISIONS

BY

REVISIONS


BY


PROJECT. THEY ARE NOT INTENDED OR REPRESENTED
TO BE SUITABLE FOR REUSE BY OWNER OR OTHERS ON
THE EXTENSIONS OF THE PROJECT OR ON ANY OTHER
PROJECT. ANY REUSE WITHOUT WRITTEN VERIFICATION
OR ADAPTATION BY PENNONI ASSOCIATES FOR THE
SPECIFIC PURPOSE INTENDED WILL BE AT OWNERS
SOLE RISK AND WITHOUT LIABILITY OR LEGAL
EXPOSURE TO PENNONI ASSOCIATES; AND OWNER
SHALL INDEMNIFY AND HOLD HARMLESS PENNONI
ASSOCIATES FROM ALL CLAIMS, DAMAGES, LOSSES AND
EXPENSES ARISING OUT OF OR RESULTING THEREFRON

RIBER21006
2024-05-29
ING SCALE 1" = 50'

DRAWN BY DTR
APPROVED BY AMD


CS4501
SHEET 36 OF 44

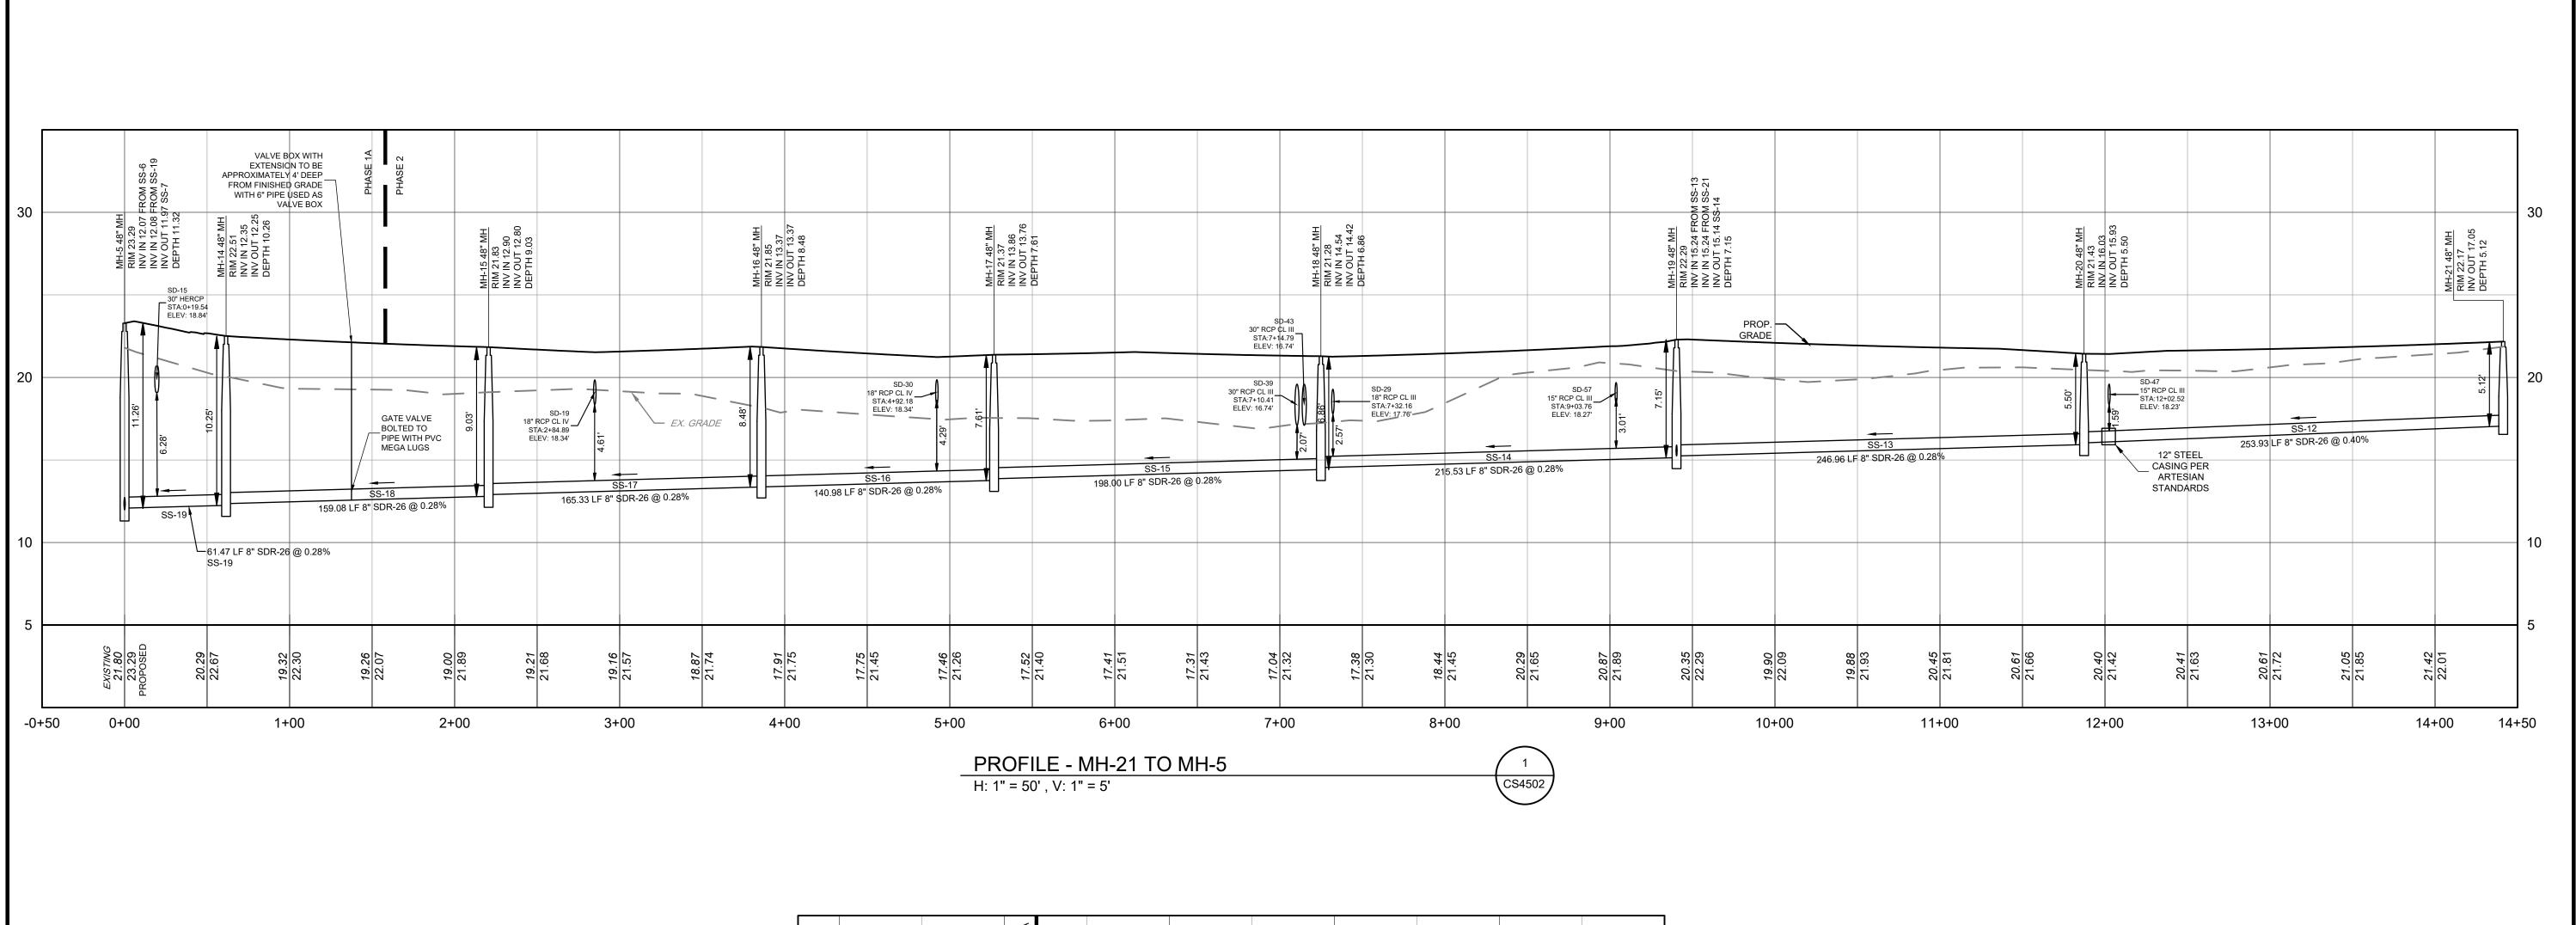

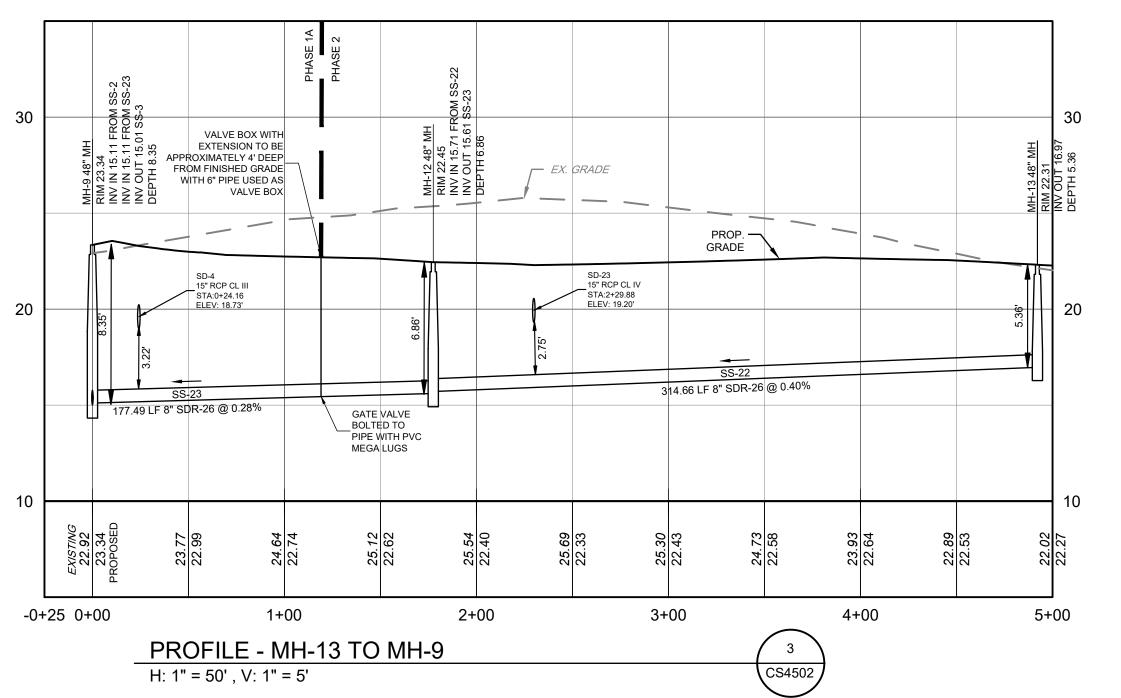


SEWER PROFILES LENGER SUBDIVISION 234-11.00-103.01 TARY BAL ALL DOCUMENTS PREPARED BY PENNONI ASSOCIATES ARE INSTRUMENTS OF SERVICE IN RESPECT OF THE PROJECT. THEY ARE NOT INTENDED OR REPRESENTED TO BE SUITABLE FOR REUSE BY OWNER OR OTHERS ON THE EXTENSIONS OF THE PROJECT OR ON ANY OTHER PROJECT. ANY REUSE WITHOUT WRITTEN VERIFICATION OR ADAPTATION BY PENNONI ASSOCIATES FOR THE SPECIFIC PURPOSE INTENDED WILL BE AT OWNERS
SOLE RISK AND WITHOUT LIABILITY OR LEGAL EXPOSURE TO PENNONI ASSOCIATES; AND OWNER SHALL INDEMNIFY AND HOLD HARMLESS PENNONI ASSOCIATES FROM ALL CLAIMS, DAMAGES, LOSSES ANI EXPENSES ARISING OUT OF OR RESULTING THEREFROM **RIBER21006** PROJECT 2024-05-29 1" = 50' DRAWN BY DTR

0 50' 100'

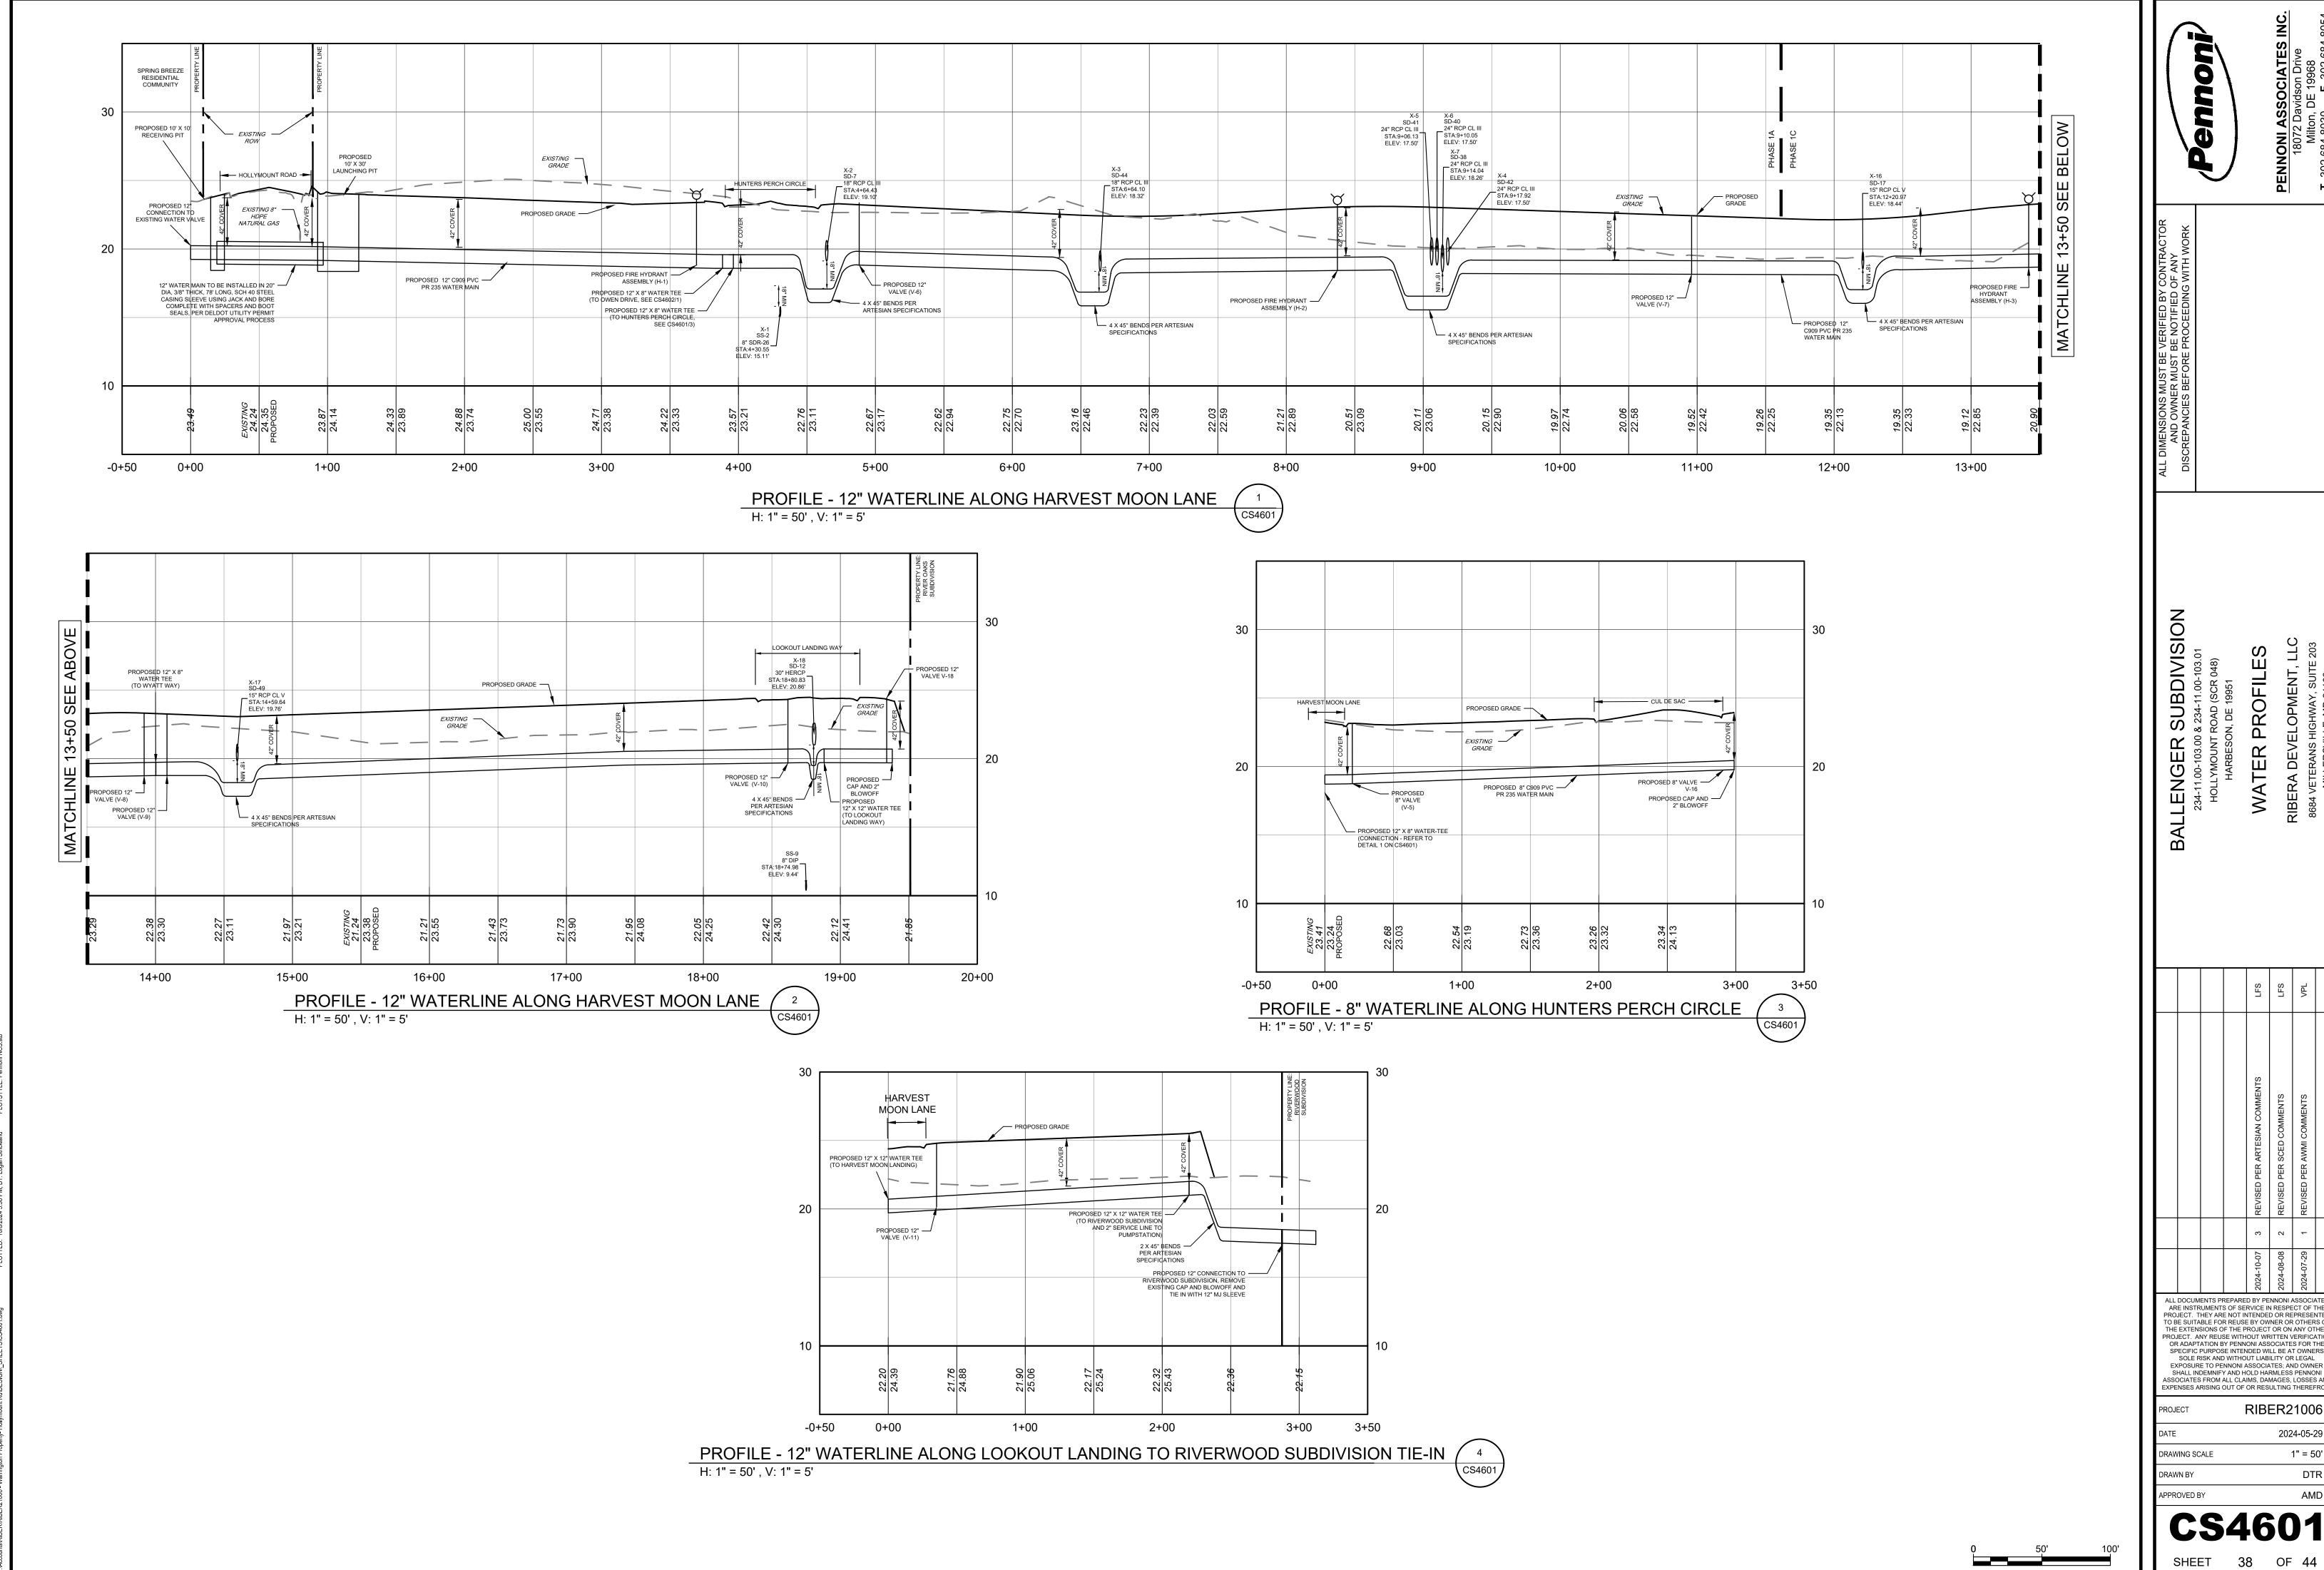



ALL DOCUMENTS PREPARED BY PENNONI ASSOCIATES ARE INSTRUMENTS OF SERVICE IN RESPECT OF THE PROJECT. THEY ARE NOT INTENDED OR REPRESENTED TO BE SUITABLE FOR REUSE BY OWNER OR OTHERS ON THE EXTENSIONS OF THE PROJECT OR ON ANY OTHER PROJECT. ANY REUSE WITHOUT WRITTEN VERIFICATION
OR ADAPTATION BY PENNONI ASSOCIATES FOR THE SPECIFIC PURPOSE INTENDED WILL BE AT OWNERS SOLE RISK AND WITHOUT LIABILITY OR LEGAL EXPOSURE TO PENNONI ASSOCIATES; AND OWNER SHALL INDEMNIFY AND HOLD HARMLESS PENNONI ASSOCIATES FROM ALL CLAIMS, DAMAGES, LOSSES ANI EXPENSES ARISING OUT OF OR RESULTING THEREFRO RIBER21006 2024-05-29 1" = 50' DTR

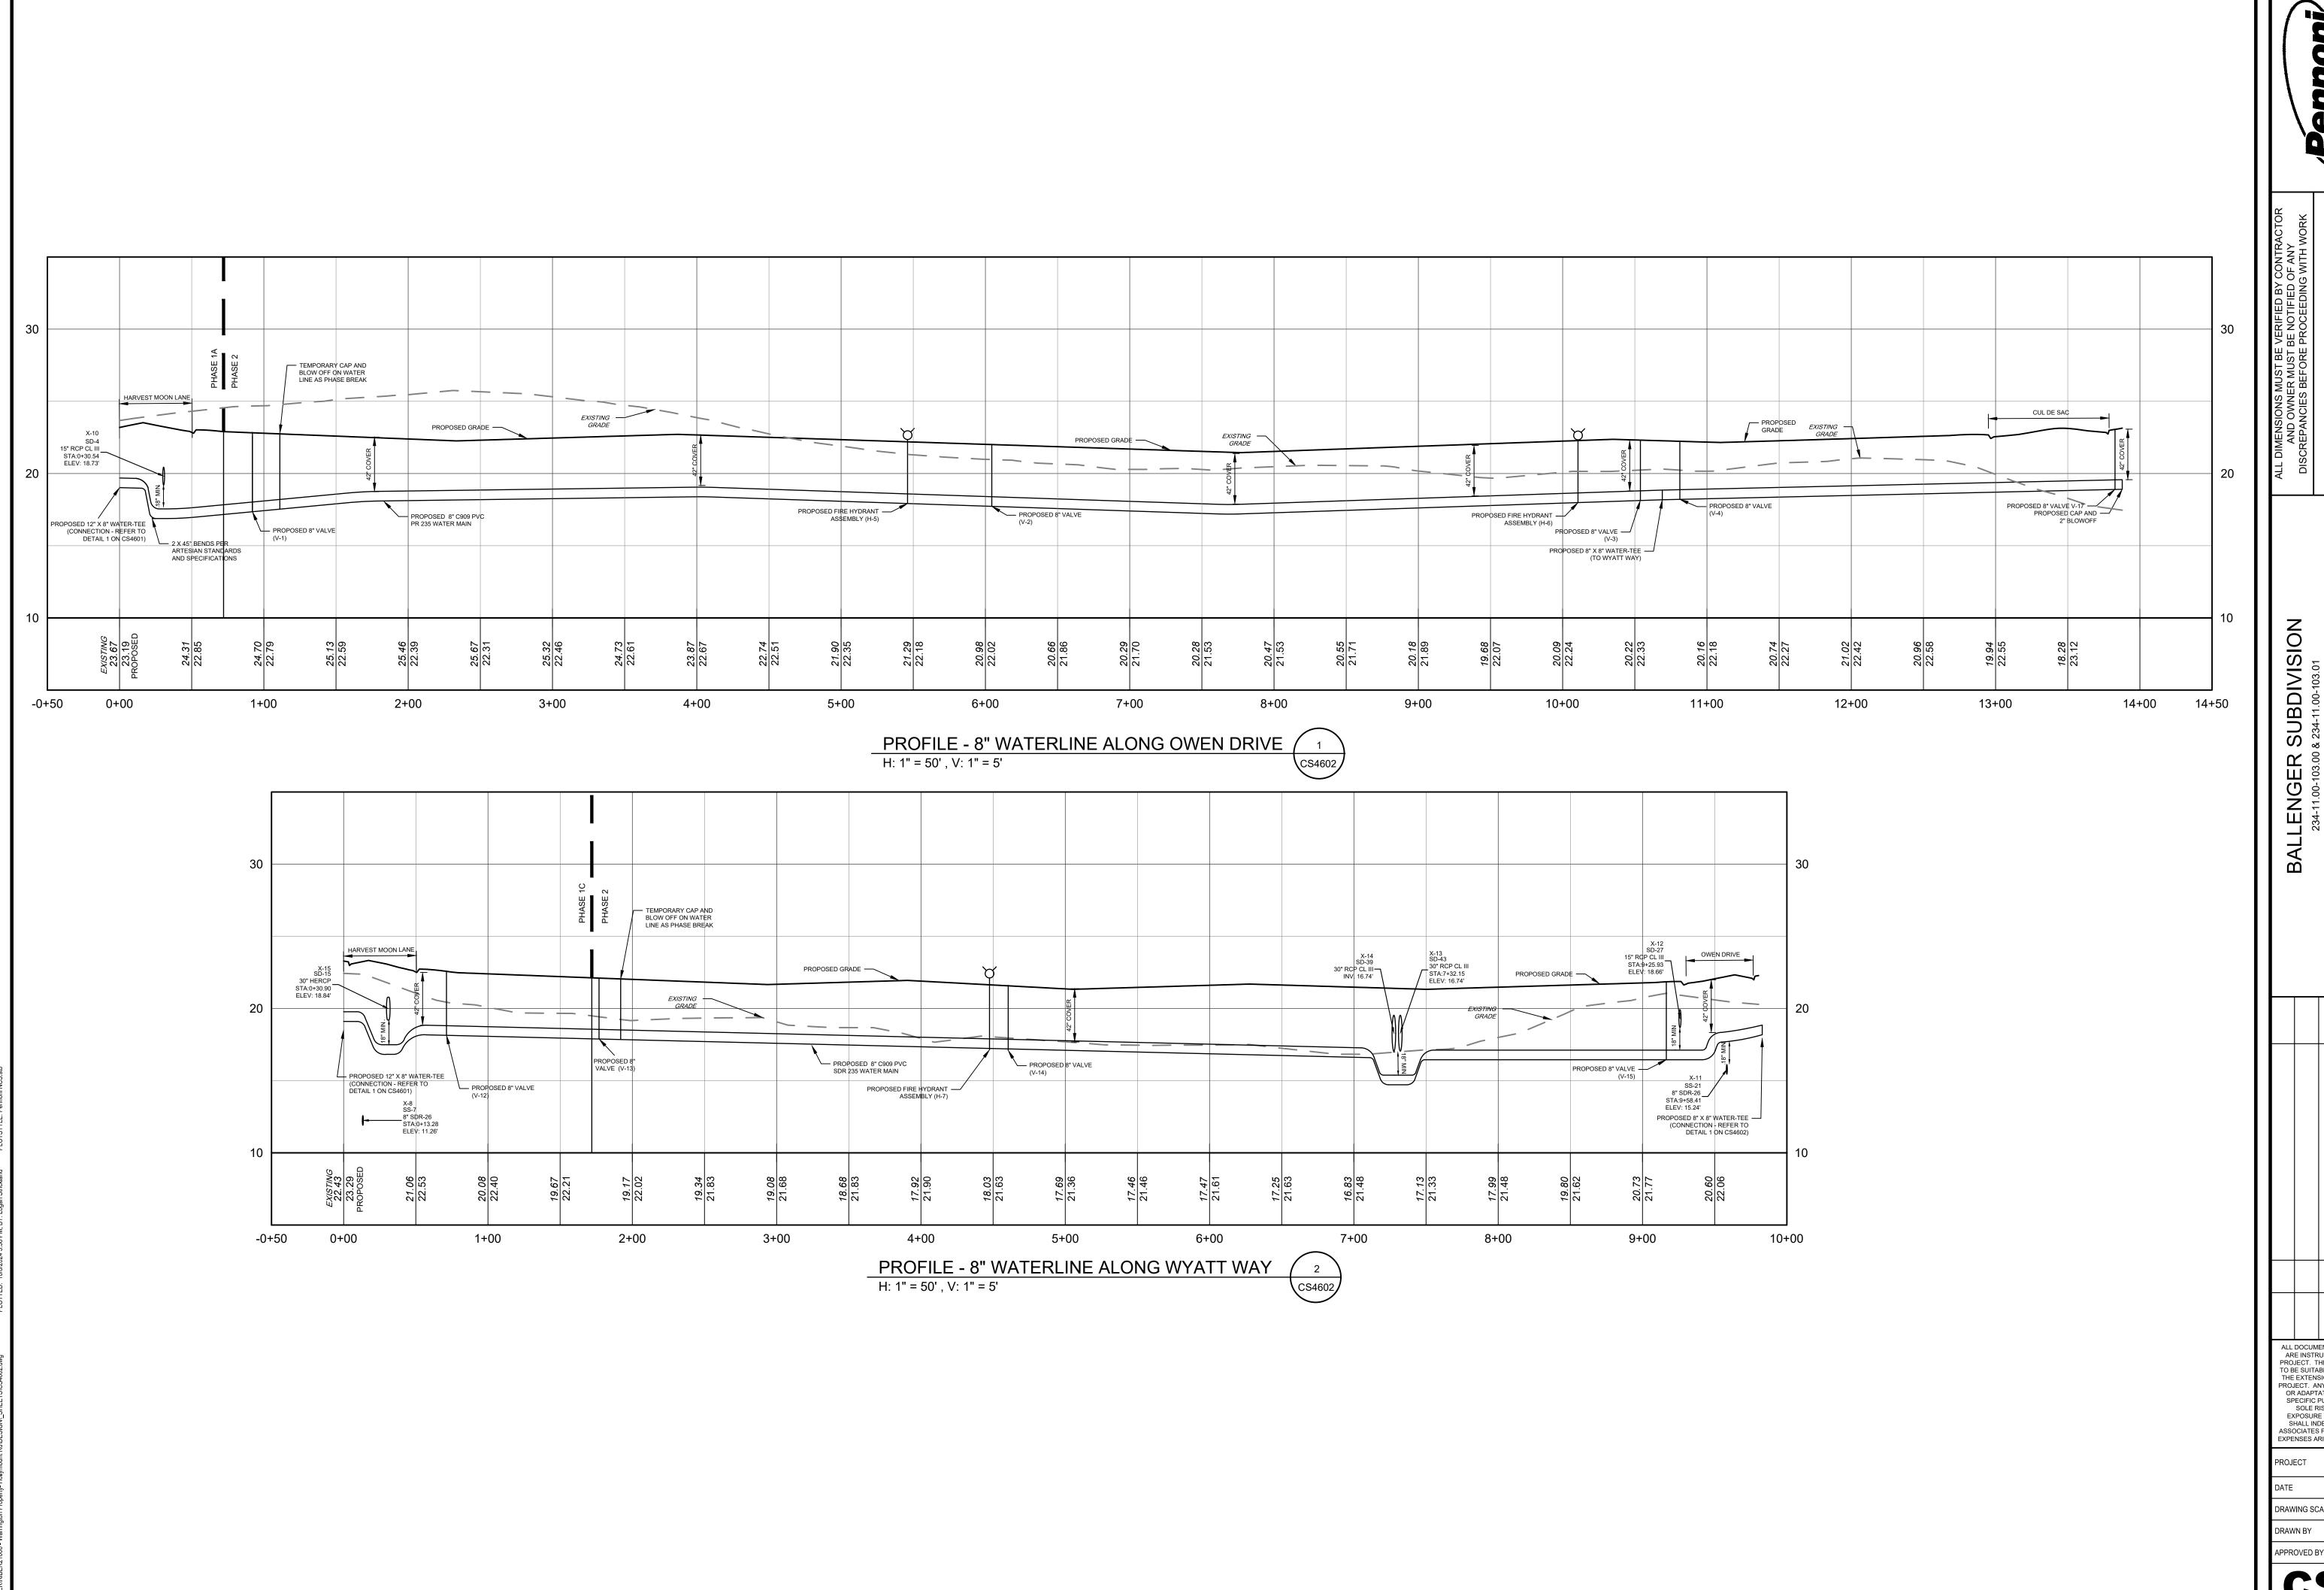



**PROFILES** WATER ALL DOCUMENTS PREPARED BY PENNONI ASSOCIATES ARE INSTRUMENTS OF SERVICE IN RESPECT OF THE PROJECT. THEY ARE NOT INTENDED OR REPRESENTED TO BE SUITABLE FOR REUSE BY OWNER OR OTHERS ON THE EXTENSIONS OF THE PROJECT OR ON ANY OTHER PROJECT. ANY REUSE WITHOUT WRITTEN VERIFICATION OR ADAPTATION BY PENNONI ASSOCIATES FOR THE SPECIFIC PURPOSE INTENDED WILL BE AT OWNERS
SOLE RISK AND WITHOUT LIABILITY OR LEGAL EXPOSURE TO PENNONI ASSOCIATES; AND OWNER SHALL INDEMNIFY AND HOLD HARMLESS PENNONI ASSOCIATES FROM ALL CLAIMS, DAMAGES, LOSSES ANI EXPENSES ARISING OUT OF OR RESULTING THEREFROM RIBER21006 2024-05-29 DRAWING SCALE 1" = 50' DTR


SHEET 39 OF 44

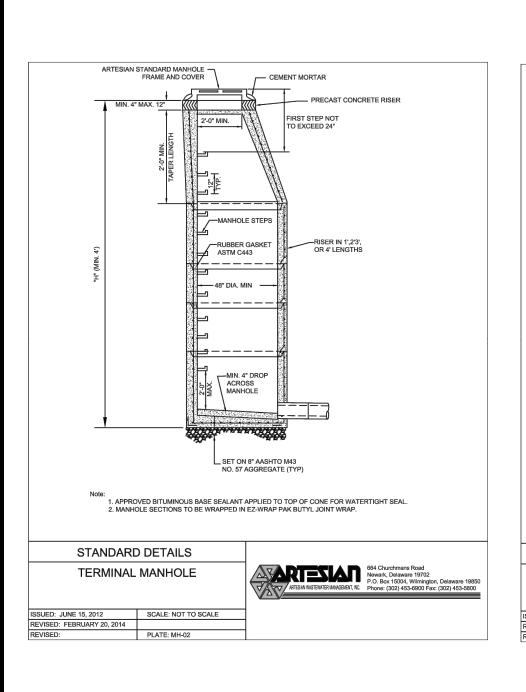


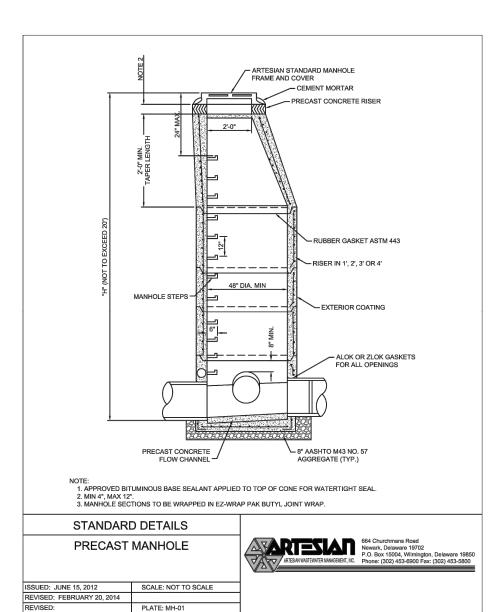


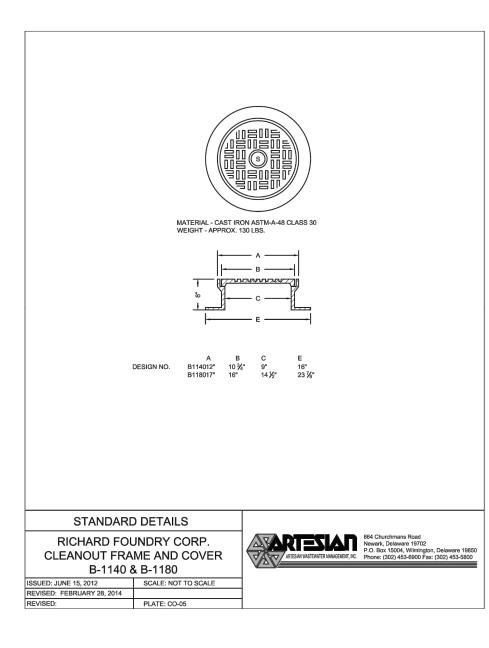


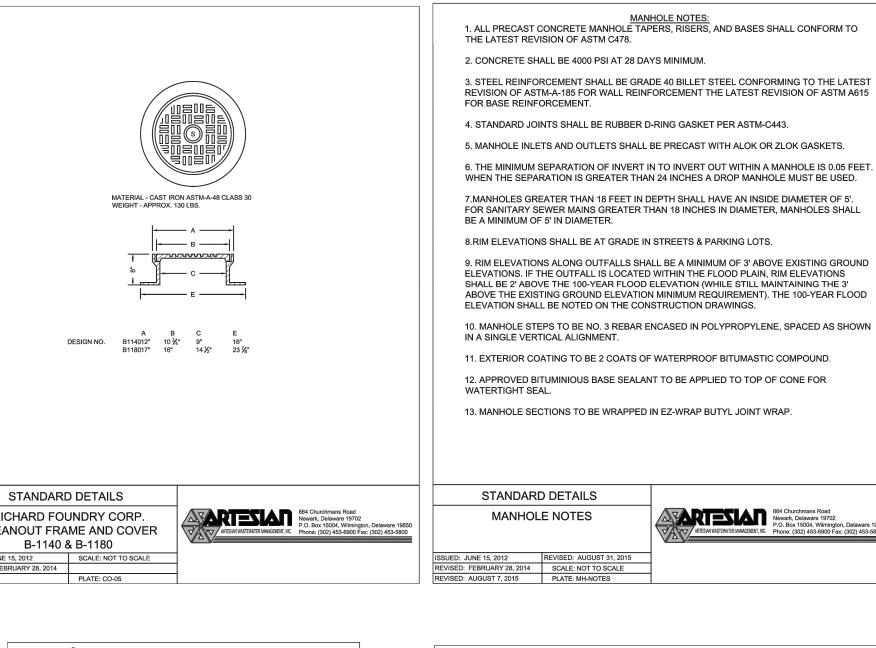


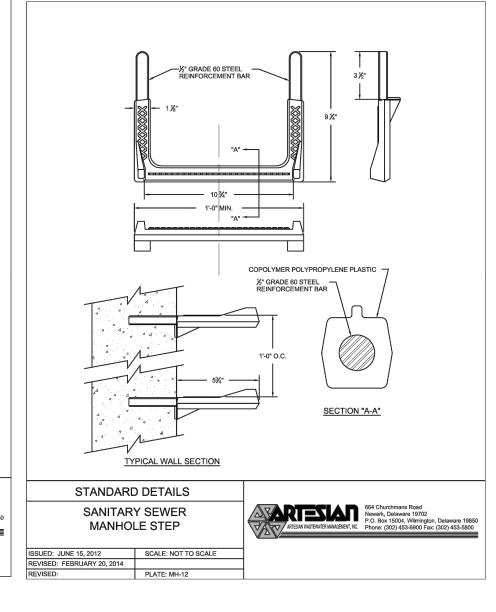


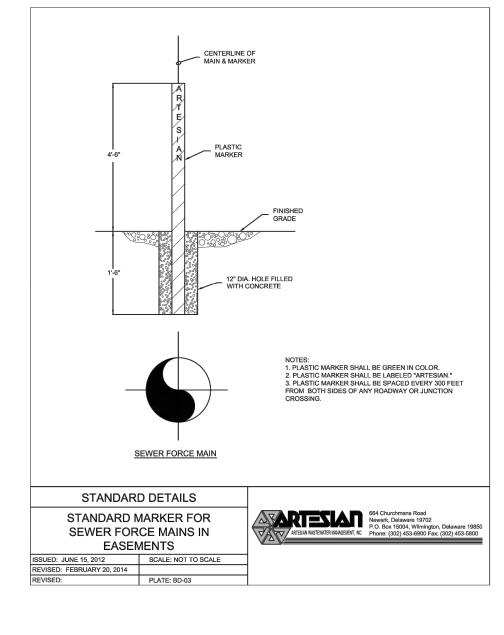


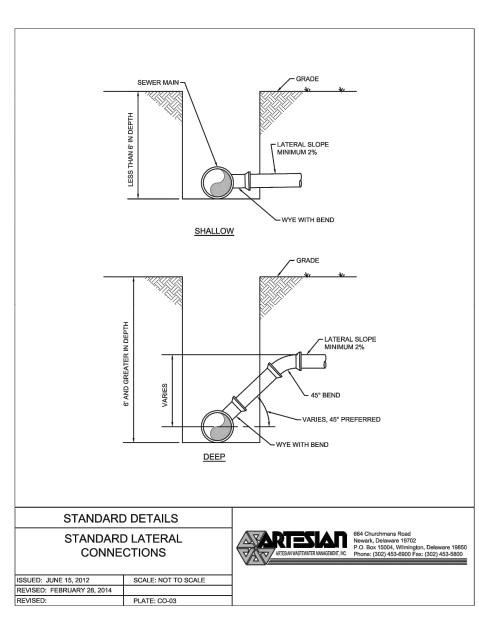


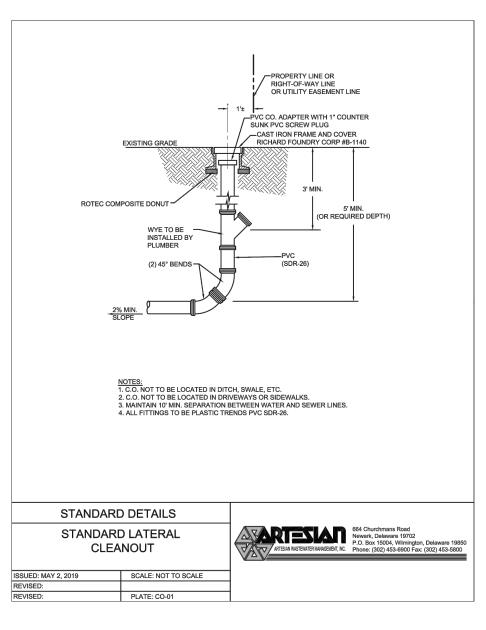


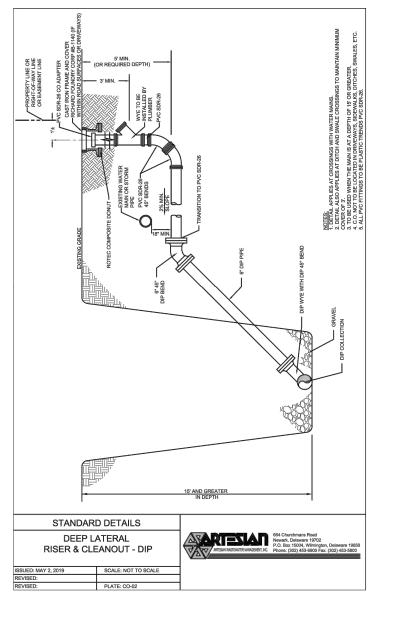


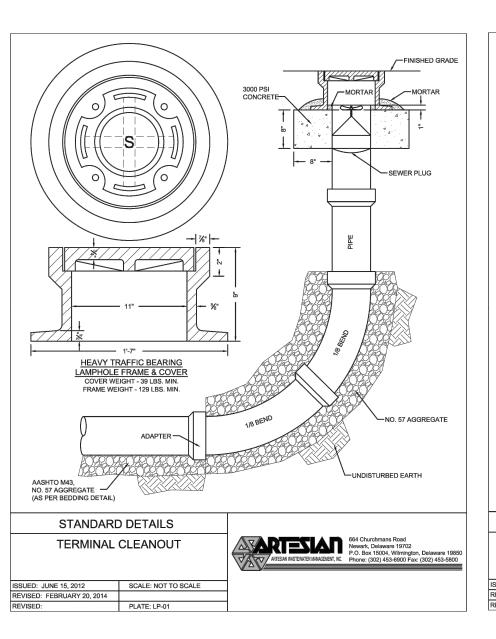


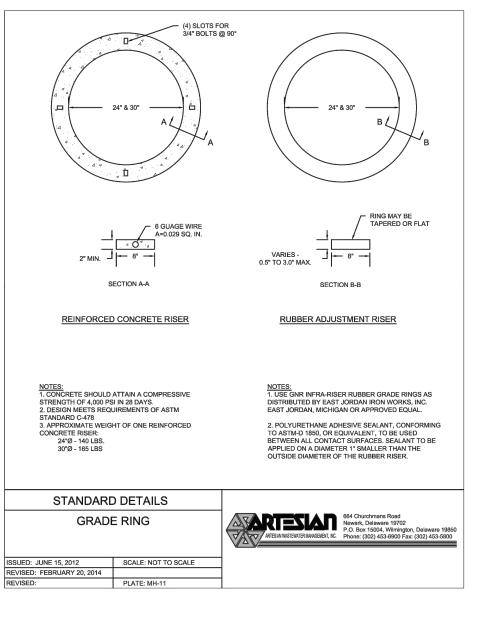


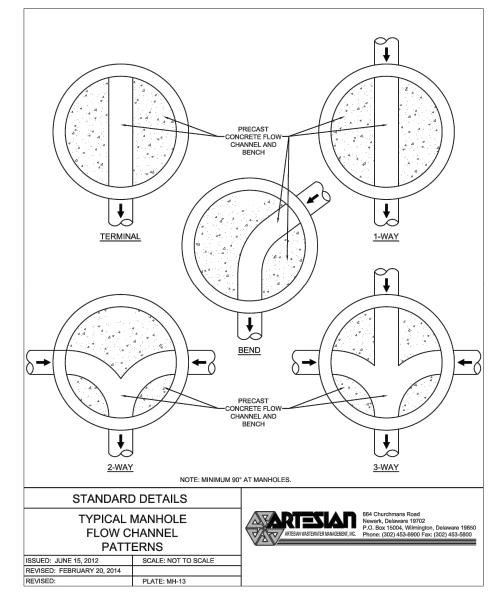

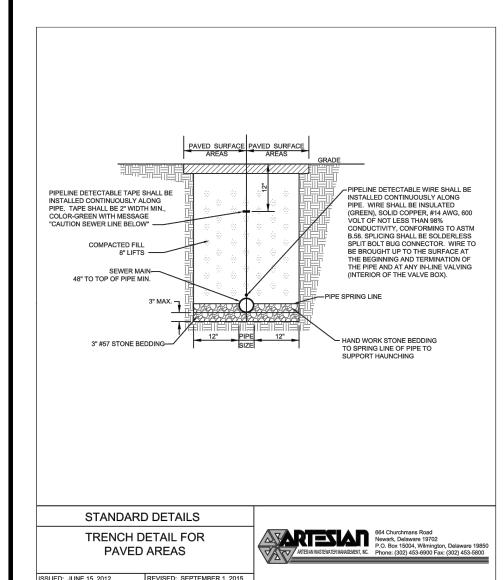

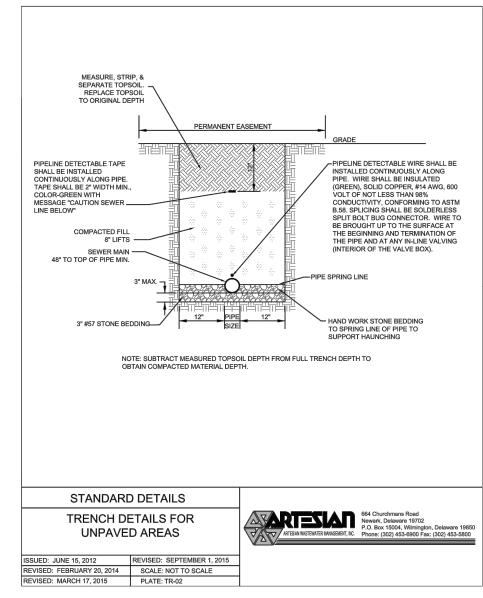

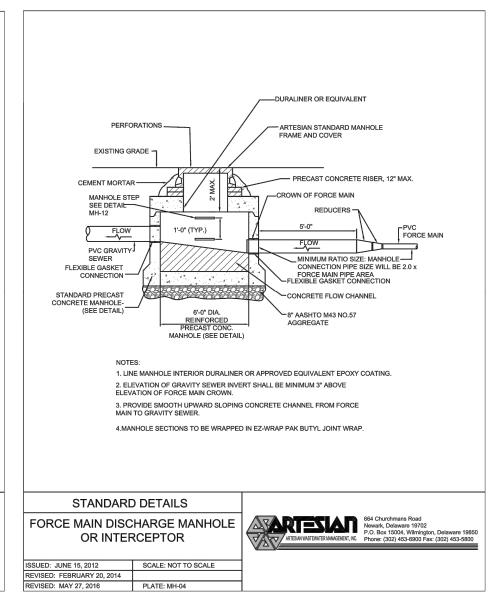

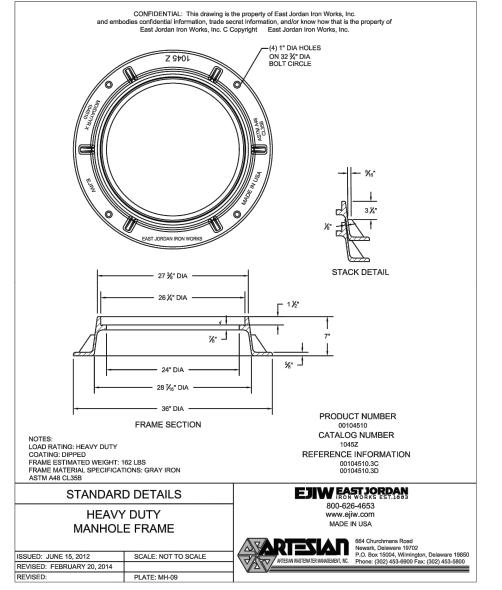



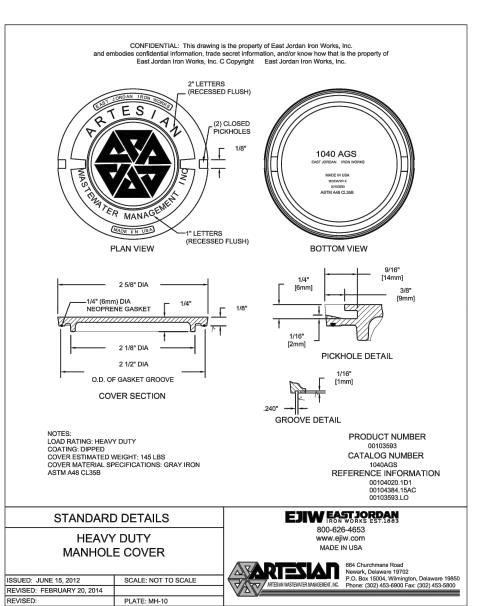


PLATE: MH-10

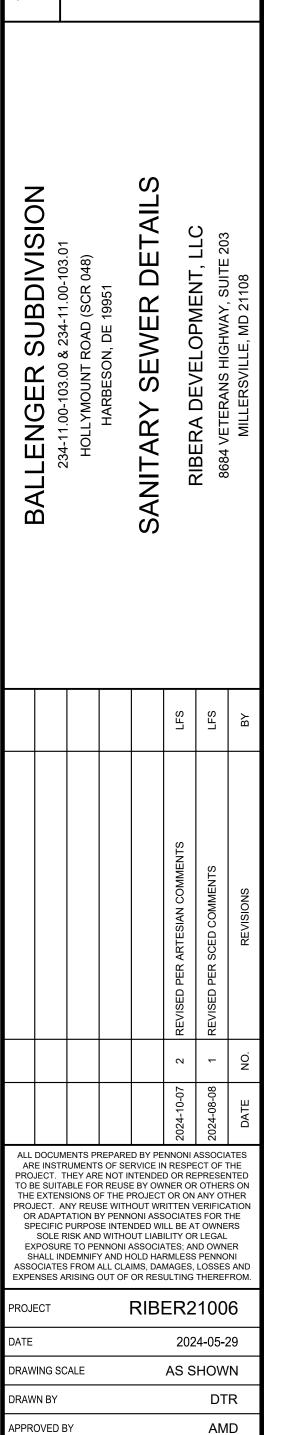

**CS6002** 

SHEET 41 OF 44

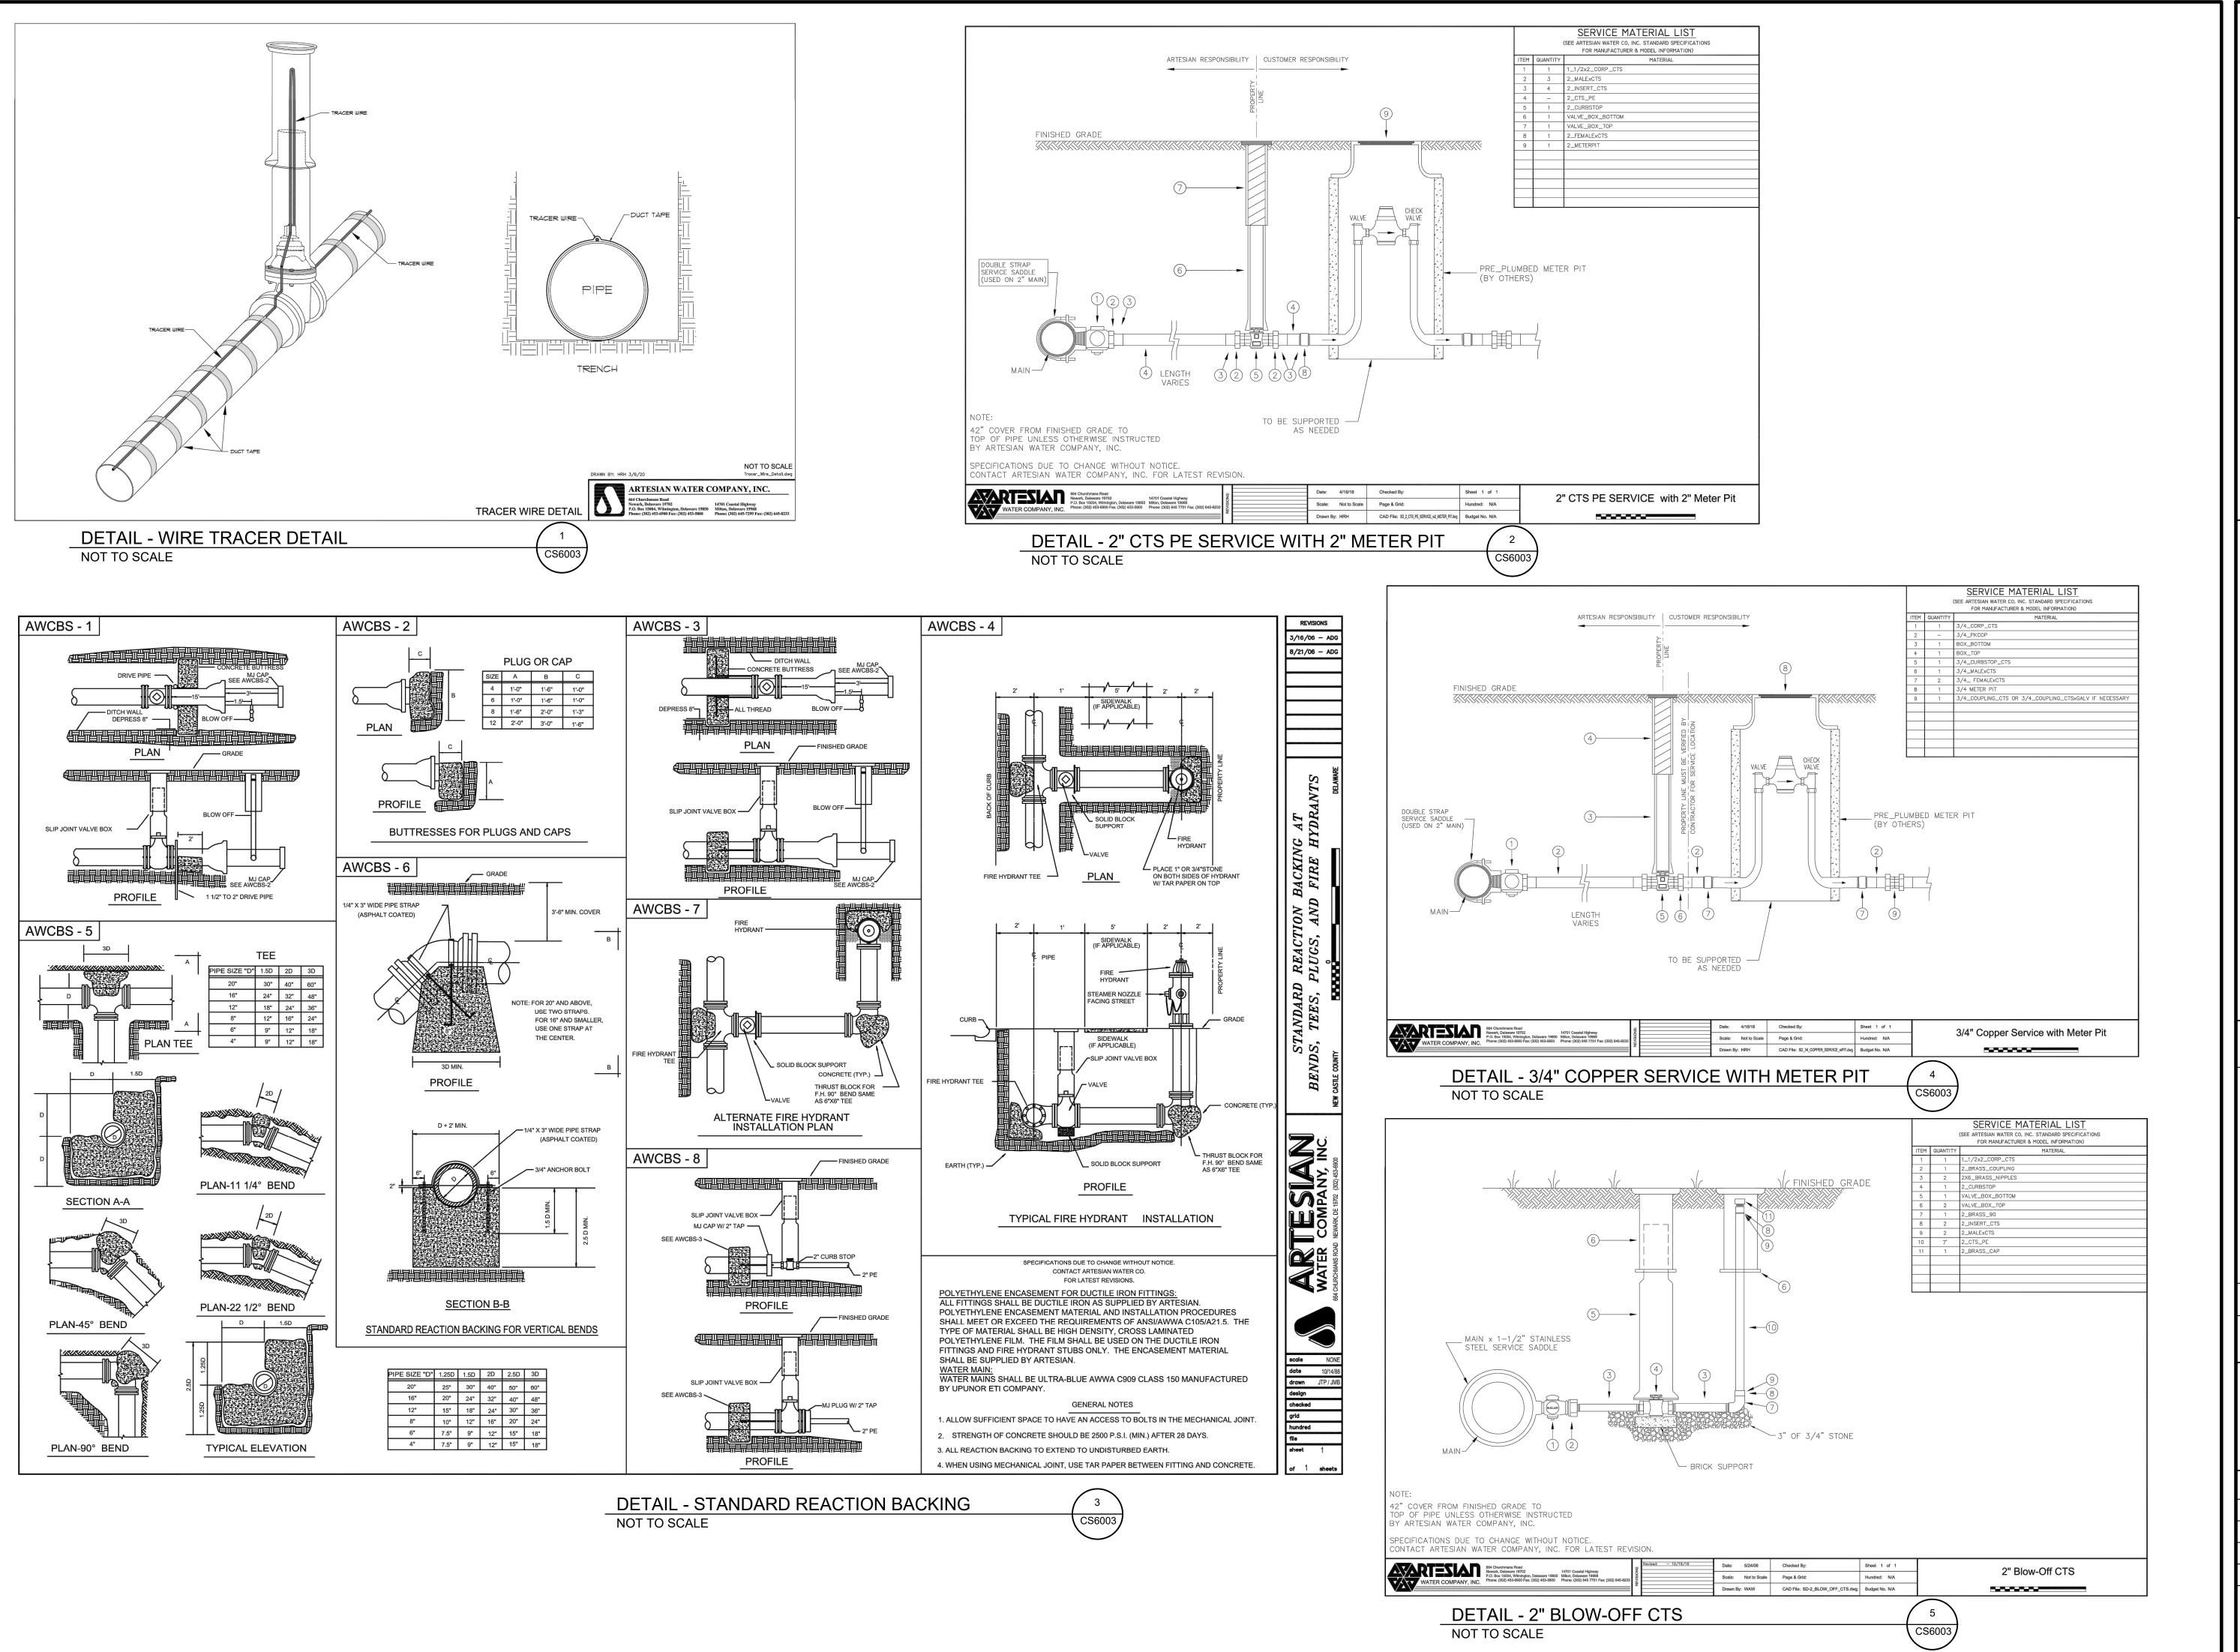

Pennoni,

PENNONI ASSOCIA
18072 Davidson I
Milton, DE 1996
T 302.684.8030 F 30

ALL DIMENSIONS MUST BE VERIFIED BY CONTRACTO
AND OWNER MUST BE NOTIFIED OF ANY
DISCREPANCIES BEFORE PROCEEDING WITH WORK

WATER DETAILS

RIBERA DEVELOPMENT, LLC

8684 VETERANS HIGHWAY, SUITE 203

2 REVISED PER ARTESIAN COMMENTS LFS
NO. REVISIONS BY

ALL DOCUMENTS PREPARED BY PENNONI ASSOCIATES
ARE INSTRUMENTS OF SERVICE IN RESPECT OF THE
PROJECT. THEY ARE NOT INTENDED OR REPRESENTED
TO BE SUITABLE FOR REUSE BY OWNER OR OTHERS ON
THE EXTENSIONS OF THE PROJECT OR ON ANY OTHER
PROJECT. ANY REUSE WITHOUT WRITTEN VERIFICATION
OR ADAPTATION BY PENNONI ASSOCIATES FOR THE
SPECIFIC PURPOSE INTENDED WILL BE AT OWNERS
SOLE RISK AND WITHOUT LIABILITY OR LEGAL
EXPOSURE TO PENNONI ASSOCIATES, AND OWNER
SHALL INDEMNIFY AND HOLD HARMLESS PENNONI
ASSOCIATES FROM ALL CLAIMS, DAMAGES, LOSSES AND

PROJECT RIBER21006

DATE 2024-05-29

DRAWING SCALE AS SHOWN

DRAWN BY DTR

EXPENSES ARISING OUT OF OR RESULTING THEREFRO

CS6003

SHEET 42 OF 44