Delaware Department of Natural Resources and Environmental Control Delaware Coastal Management Program



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Updated On:	
Complete:	
Officia	Use Only

Coastal Zone Management Act Federal Consistency Form

This document provides the Delaware Coastal Management Program (DCMP) with a Federal Consistency Determination or Certification for activities regulated under the Coastal Zone Management Act of 1972, as amended, and NOAA's Federal Consistency Regulations, 15 C.F.R. Part 930. Federal agencies and other applicants for federal consistency are not required to use this form; it is provided to applicants to facilitate the submission of a Consistency Determination or Consistency Certification. In addition, federal agencies and applicants are only required to provide the information required by NOAA's Federal Consistency Regulations.

Project/Activity Name: Broad Creek Gas Main Replacement				
	or Non-Federal Applicant Co	ontact Information: ental Project Manager (On Behalf of Chesapeake Utilities)		
Contact Name/Title:	THOTAIT BUILDS, ELOI ETWOTTITE	entain roject manager (on Benaii or onesapeake ounites)	-	
Federal Agency Contra	ctor Name (if applicable):			
	JS Army Corps of Engineers			
(either the federal agen assistance to a non-fed		ederal agency issuing a federal license/permit or financial		
Mailing Address: 1760	5 Nassau Commons Blvd, Uni	t D,		
City: Lewes State: DE Zip Code: 19958				
E-mail: Kieran@env	irotechecinc.com	Telephone #: 302-684-5201		
II. Federal Consist	ency Category:			
Federal Activity of (15 C.F.R. Part 93	r Development Project 30, Subpart C)	Federal License or Permit Activity (15 C.F.R. Part 930, Subpart D)		
Outer Continental Shelf Activity (15 C.F.R. Part 930, Subpart E)		Federal License or Permit Activity which occurs wholly in another state (interstate consistency		
Federal Financial Assistance (15 C.F.R. Part 930, Subpart F)				

III. Detailed Project Description (attach additional sheets if necessary):

The purpose of this project is to replace/retire an exisiting 4-inch steel gas main with a new 4-inch high density poly ethylene (HDPE) main using horizontal directional drilling (HDD). Please refer to the 'Supplemental Information Package' Attachment C for the 'Sequence of Construction' and 'Frac Out Plan'. In addition, Attachment A 'Site Maps of the Subject Property' will show overall site locations. Attachment B 'Chesapeake Utilities - Profile and Plan View' will show details of the project. Further information is included within the package. Permit applications for 'US Army Corps of Engineers - NWP 12' and 'DNRECs Wetlands and Subaqueous Lands Section' have been submitted.

IV. General Analysis of Coastal Effects	(attach additional sheets if necessary)
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This project is anticipated to have a low coastal effect. This is due to the project abiding by the time
of year restrictions suggested within the DNREC Environmental review, Attachment F 'State and
Federal Agency Letters'. In addition, the area uzitilied by by HDD is 8-inches in diameter, going
+/-95 ft MHW to MHW, and to be at a minimum 5 ft below the creek bed. Meaning the direct area of
impact is minimal and not directly through 'Navigable Waters of the US' but below them. The
highest effect will be sediment displacement caused by the HDD, however, because of the high
percentage of sand within the sediment analysis (see Attachment D 'AgroLab-Soil Results'),
turbidity should remain relatively low.

V. Detailed Analysis of Consistency with DCMP Enforceable Policies (attach additional sheets if necessary):

Policy 5.1: Wetlands Management

Time of year restrictions set forth by the DNREC Environmental Review will be follow to reduce impact to any listed species (see Attachment F for the 'State and Federal agency Letters'). In addition, HDD will begin from upland at the drillpit location, go atleast 5 feet under the Broad Creek Bed, and end at uplands at the other drillpit location. No activity will occur until all necessary State and Federal permits are received.

Policy 5.2: Beach Management Not Applicable

Policy 5.3: Coastal Waters Management (includes wells, water supply, and stormwater management. Attach additional sheets if necessary)

Time of year restrictions set forth by the DNREC Environmental Review will be follow to reduce impact to any listed species (see Attachment F for the 'State and Federal agency Letters'). In addition, HDD will begin from upland at the drillpit location, go atleast 5 feet under the Broad Creek Bed, and end at uplands at the other drillpit location. No activity will occur until all necessary State and Federal permits are received.

Policy 5.4: Subaqueous Land and Coastal Strip Management

Not Applicable			

Policy 5.5: Public Lands Management

Time of year restrictions set forth by the DNREC Environmental Review will be follow to reduce impact to any listed species (see Attachment F for the 'State and Federal Agency Letters'). In addition, also within Attachment F is the DE State Historic Properties office 'No Adverse Letter' and the US FWS 'Online Certification Letter' and 'endangered species list. No activity will occur until all necessary State and Federal permits are received.

Policy 5.6: Natural Lands Management
Not Applicable
Policy 5.7: Flood Hazard Areas Management
Not Applicable
Policy 5.8: Port of Wilmington
Not Applicable
Policy 5.9: Woodlands and Agricultural Lands Management
Not Applicable
Policy 5.10: Historic and Cultural Areas Management
Please see within the Supplemental Information Package - Attachment F, is the DE State Historic Properties office 'No Adverse Letter'.
Policy 5.11: Living Resources
PPlease see within the Supplemental Information Package - Attachment F for the DNREC Environmental review, DE SHPO Letter, and FWS Endangered Species Review. All time of year restrictions will be followed to minimize any impact to living species.
Policy 5.12 Mineral Resources Management
Not Applicable

Policy 5.13: State Owned Coastal Recreation and Conservation
Not Applicable
Policy 5.14: Public Trust Doctrine
Not Applicable
Policy 5.15: Energy Facilities
Not Applicable
Policy 5.16: Public Investment
Not Applicable
Policy 5.17: Recreation and Tourism
Not Applicable
Policy 5.18: National Defense and Aerospace Facilities
Not Applicable
Policy 5.19: Transportation Facilities
Not Applicable

Poli	cy 5.20: Air Quality	Management		
Not	Applicable			
Poli	cy 5.21: Water Supp	oly Management		
Not	Applicable			
Poli	cy 5.22: Waste Disp	osal Management		
Not	Applicable			
Poli	cy 5.23: Developme	nt		
Not	Applicable			
Poli	cy 5.24: Pollution P	revention		
	ase refer to the 'S astruction' and 'Fr		age' Attachment C for the 'Sequence of	
Poli	cy 5.25: Coastal Ma	nagement Coordination		
Eng	ineers have beer		uos Lands section and US Army Corps IREC Envrionmental Review office, DE s project.	
VI.	JPP and RAS Rev	view (Check all that apply):		
	Has the project bee	n reviewed in a monthly Joint Permit	Processing and/or Regulatory Advisory Service	meeting?
	☐ JPP	☐ RAS	None	
	*If yes, provide the	date of the meeting(s):		

Decision type: (objections or conditions attach details)

VII.	Statemer	nt of Certification/Det	erminatio	on and Signatu	ıre (Check one a	and sign belov	v):	
	FEDERAL AGENCY CONSISTENCY DETERMINATION. Based upon the information, data, and analysis included herein, the federal agency, or its contracted agent, listed in (I) above, finds that this proposed activity is consistent to the maximum extent practicable with the enforceable policies of the Delaware Coastal Management Program.							
	OR							
	FEDERAL AGENCY NEGATIVE DETERMINATION. Based upon the information, data, and analysis included herein, the federal agency, or its contracted agent, listed in (I) above, finds that this proposed activity will not have any reasonably foreseeable effects on Delaware's coastal uses or resources (Negative Determination) and is therefore consistent with the enforceable policies of the Delaware Coastal Management Program.							
	OR							
	analysis in agency ap	ncluded herein, the no oplying for federal full e policies of the Delav	on-federal nding, list	applicant for a ted in (I) above	a federal license ve, finds that t	e or permit, o	the information, data, a r state or local governme activity complies with t cted in a manner consiste	ent the
5	Signature:	Kieran Bur	ns					
Print	ed Name:	Kieran Burns				Date:	8/30/2022	
or ob below	jection to v. Concurre		rmination I if the sta	or consistenc	y certification in	n accordance	vide its concurrence with with the deadlines listen bwable timeframe.	
		or Development Projec 930, Subpart C)	ct		60 days with op stay review (15		n additional 15 days or	
	ral License .F.R. Part 9	or Permit 930, Subpart D)				eriod can be sta	at three months. The six yed by mutual agreement.	
	Outer Continental Shelf Activity (15 C.F.R. Part 930, Subpart E) Six months, with a status letter at three months. If three month status letter not issued, then concurrence presumed. The six month review period can be stayed by mutual agreement. (15 C.F.R. § 930.78)							
	Federal Financial Assistance to State or Local Governments (15 C.F.R. Part 930, Subpart F) State Clearinghouse schedule							
OFFIC	CIAL USE (ONLY:						_
Revie	ewed By:			Fed Con ID:		Date Receiv	ed:	
Public	c notice da	tes:	to		Comments Re	ceived:	NO YES	

Decision Date:

U.S. Army Corps of Engineers (USACE)

NATIONWIDE PERMIT PRE-CONSTRUCTION NOTIFICATION (PCN)

33 CFR 330. The proponent agency is CECW-CO-R.

Form Approved -OMB No. 0710-0003 Expires: 02-28-2022

DATA REQUIRED BY THE PRIVACY ACT OF 1974

Authority Rivers and Harbors Act, Section 10, 33 USC 403; Clean Water Act, Section 404, 33 USC 1344; Regulatory Program of the Corps of

Engineers (Corps); Final Rule 33 CFR 320-332.

Principal Purpose Information provided on this form will be used in evaluating the nationwide permit pre-construction notification.

Routine Uses This information may be shared with the Department of Justice and other federal, state, and local government agencies, and the public and

may be made available as part of the agency coordination process.

Disclosure Submission of requested information is voluntary, however, if information is not provided the permit application cannot be evaluated nor can

a permit be issued.

The public reporting burden for this collection of information, 0710-0003, is estimated to average 11 hours per response, including the time for reviewing instructions, searching existing data sources, gathering and maintaining the data needed, and completing and reviewing the collection of information. Send comments regarding the burden estimate or burden reduction suggestions to the Department of Defense, Washington Headquarters Services, at whs.mc-alex.esd.mbx.dd-dod-information-collections@mail.mil. Respondents should be aware that notwithstanding any other provision of law, no person shall be subject to any penalty for failing to comply with a collection of information if it does not display a currently valid OMB control number.

PLEASE DO NOT RETURN YOUR RESPONSE TO THE ABOVE EMAIL.

One set of original drawings or good reproducible copies which show the location and character of the proposed activity must be attached to this application (see sample drawings and/or instructions) and be submitted to the district engineer having jurisdiction over the location of the proposed activity. An application that is not completed in full will be returned.

(ITEMS 1 THRU 4 TO BE FILLED BY THE CORPS)							
1. APPLICATION	ION NO. 2. FIELD OFFICE CODE		Ē	3. DATE RECEIVED	4. DATE APPLICA	TION COMPLETE	
		(ITEMS BELOW	TO BE FILLED BY AP	PLICANT)			
5. APPLICANT'S	NAME		8. AUTHORIZ	ZED AGENT'S NAME AN	ND TITLE (agent is n	ot required)	
First - Garth	Middle -	Last - Jones	First - Todd	Middle -	Last - F	ritchman	
Company - Ches	apeake Utilities		Company - E	nvirotech Environme	ntal Consulting Inc	e. (EECI)	
Company Title - I	Engineering Manager		E-mail Addres	ss-Todd@enviroteche	ecinc.com		
E-mail Address - g	gjones@chpk.com						
6. APPLICANT'S	ADDRESS		9. AGENT'S	9. AGENT'S ADDRESS			
Address- 500 En	nergy Lane, Suite 100,		Address- 176	Address- 17605 Nassau Commons Blvd, Unit D			
City - Dover	State - DE	Zip - 19901 Country - U	SA City - Lewes	State - D	E Zip - 19958	Country - USA	
7. APPLICANT'S F	PHONE NOs. with AREA	CODE	10. AGENT'S	10. AGENT'S PHONE NOs. with AREA CODE			
a. Residence	b. Business c.	Fax d. Mobile	a. Residence	b. Business	c. Fax	d. Mobile	
NA	NA N	A 302-213-7	455 NA	302-684-5201	302-684-5204	302-462-5613	
		STATEME	NT OF AUTHORIZAT	ION			
11. I hereby author	orize, EECI	to act in my bel	nalf as my agent in the	processing of this nation	wide permit pre-cons	struction notification	
and to furnish, upo	on request, supplementa	information in support of this	nationwide permit pre-d	construction notification.			
	Garth E. Jones Digitally signed by Garth E. Jones Date: 2022.08.18 10:35:20 -04'00' 2022-08-18						
		SIGNATURE OF A	PPLICANT	DATE			
		NAME, LOCATION, AND D	ESCRIPTION OF PRO	JECT OR ACTIVITY			
12. PROJECT NA	ME or TITLE (see instruc	ctions)					
Broad Creek Ma	ain Replacement						

NAME, LOCATION, AND DESCR	RIPTION OF PROJECT OR ACTIVITY		
13. NAME OF WATERBODY, IF KNOWN (if applicable)	14. PROPOSED ACTIVITY STREET ADDRESS (if applicable	le)	
Broad Creek	Front Street & Delaware Ave		
15. LOCATION OF PROPOSED ACTIVITY (see instructions)	City:	State:	Zip:
Latitude °N Longitude °W -75.569656	Laurel	DE	19956
16. OTHER LOCATION DESCRIPTIONS, IF KNOWN (see instructions)			
State Tax Parcel ID	Municipality		
232-12.19-30.00 & 332-1.07-154.00	Sussex County		
Section Township	Range		
NA Town of Laurel	NA		
17. DIRECTIONS TO THE SITE From the USACE Philadelphia office, Get on I-95S, take DE-1S, foll bridge over Broad Creek. 18. IDENTIFY THE SPECIFIC NATIONWIDE PERMIT(S) YOU PROPOSE TO		erty is a	t the
NWP 12	OUSE		
19. DESCRIPTION OF PROPOSED NATIONWIDE PERMIT ACTIVITY (see in The proposed activity is to use HDD in order to retire the current 4-in Ethylene (HDPE) main.		sity Poly	7
20. DESCRIPTION OF PROPOSED MITIGATION MEASURES (see instruction No mitigation proposed.	ons)		
21. PURPOSE OF NATIONWIDE PERMIT ACTIVITY (<i>Describe the reason or</i> The purpose of the nationwide activity permit is to retire the old 4-independent of the nationwide activity permit is to retire the old 4-independent of the nationwide activity permit is to retire the old 4-independent of the nationwide activity permit is to retire the old 4-independent of the nationwide activity permit is to retire the old 4-independent of the nationwide activity permit is to retire the old 4-independent of the nationwide activity permit is to retire the old 4-independent of the nationwide activity permit is to retire the old 4-independent of the nationwide activity permit is to retire the old 4-independent of the nationwide activity permit is to retire the old 4-independent of the nationwide activity permit is to retire the old 4-independent of the nationwide activity permit is to retire the old 4-independent of the nationwide activity permit is to retire the old 4-independent of the nationwide activity permit is to retire the old 4-independent of the nationwide activity permit is to retire the old 4-independent of the nationwide activity permit is to retire the old 4-independent of the nationwide activity permit is not activity permit in the nationwide activity permit is not activity permit in the nationwide activity permit is not activity permit in the nationwide activity permit is not activity permit in the nationwide activity permit is not activity permit in the nationwide activity permit is not activity permit in the nationwide activity permit is not activity permit in the nationwide activity permit is not activity permit in the nationwide activity permit is not activity permit in the nationwide activity permit is not activity permit in the nationwide activity permit is not activity permit in the nationwide activity permit is not activity permit in the nationwide activity permit is not activity permit in the nationwide activity permit is not activity permit in the nationwide activity permit is not activity permit in the		Emain.	
22. QUANTITY OF WETLANDS, STREAMS, OR OTHER TYPES OF WATER (see instructions)	S DIRECTLY AFFECTED BY PROPOSED NATIONWIDE PERI	MIT ACTI	VITY
Acres Linear Feet	Cubic Yards Dredged or Dischar	ged	
0.0016 95	53.44		
Each PCN must include a delineation of wetlands, other special aquatic and ephemeral stre	sites, and other waters, such as lakes and ponds, and perenams, on the project site.	nnial, inte	ermittent,
List any other NWP(s), regional general permit(s), or individual permit(s) us related activity. (see instructions) DNREC - Wetlands and Subaqueous Lands Section permit - appendix		project o	or any
If the proposed activity will result in the loss of greater than 1/10-acre of we mitigation requirement in paragraph (c) of general condition 23 will be satis and why compensatory mitigation should not be required for the proposed NA	fied, or explain why the adverse environmental effects are no me		

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25. Is any portion of the nationwide permit activity already com	plete? Y	es No If Yes,	, describe tl	he completed work:			
26. List the name(s) of any species listed as endangered or threatened under the Endangered Species Act that might be affected by the proposed NWP activity or utilize the designated critical habitat that might be affected by the proposed NWP activity. (see instructions) See attached FWS Endangered Species Review and DNREC Environmental Review.							
List any historic properties that have the potential to be affer property or properties. (see instructions) See attached the Delaware State Historic Properties Office.			include a v	ricinity map indicating the location	on of the historic		
28. For a proposed NWP activity that will occur in a componen "study river" for possible inclusion in the system while the r NA							
29. If the proposed NWP activity also requires permission from use a U.S. Army Corps of Engineers federally authorized district having jurisdiction over that project? Yes If "yes", please provide the date your request was submitted.	civil works project. No	, have you submitted					
30. If the terms of the NWP(s) you want to use require addition on an additional sheet of paper marked Block 30. (see ins the following will be included: DNREC Wetlands Pern Vicinity Map, Plan View, Profile View, DelDOT ROW of Construction, DNREC Environmental Review, FWS	tructions) nit app & appen / Plans, Wetland	dixes, 1000-ft radi d Delineation Repo	ius propert ort with pi	ty search mailing address, I	Directions with		
31. Pre-construction notification is hereby made for one or moi information in this pre-construction notification is complete or am acting as the duly authorized agent of the applicant.							
Garth E. Jones Digitally signed by Garth E. Jones Date: 2022.08.18 10:35:44 -04'00' SIGNATURE OF APPLICANT	2022-08-18 DATE	Todd Fritch	IIIIaii	Digitally signed by Todd Fritchman Date: 2022.08.19 07:58:29 -04'00' OF AGENT	2022-08-19 DATE		
The pre-construction notification must be signed by the person been filled out and signed, the authorized agent.							
18 U.S.C. Section 1001 provides that: Whoever, in any manne falsifies, conceals, or covers up any trick, scheme, or disguises or uses any false writing or document knowing same to contain imprisoned not more than five years or both.	s a material fact o	r makes any false, fic	ctitious or fra	audulent statements or represe	ntations or makes		

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Instructions for Preparing a Department of the Army

Nationwide Permit (NWP) Pre-Construction Notification (PCN)

Blocks 1 through 4. To be completed by the Corps of Engineers.

Block 5. Applicant's Name. Enter the name and the e-mail address of the responsible party or parties. If the responsible party is an agency, company, corporation, or other organization, indicate the name of the organization and responsible officer and title. If more than one party is associated with the preconstruction notification, please attach a sheet of paper with the necessary information marked Block 5.

Block 6. Address of Applicant. Please provide the full address of the party or parties responsible for the PCN. If more space is needed, attach an extra sheet of paper marked Block 6.

Block 7. Applicant's Telephone Number(s). Please provide the telephone number where you can usually be reached during normal business hours.

Blocks 8 through 11. To be completed, if you choose to have an agent.

Block 8. Authorized Agent's Name and Title. Indicate name of individual or agency, designated by you, to represent you in this process. An agent can be an attorney, builder, contractor, engineer, consultant, or any other person or organization. Note: An agent is not required.

Blocks 9 and 10. Agent's Address and Telephone Number. Please provide the complete mailing address of the agent, along with the telephone number where he / she can be reached during normal business hours.

Block 11. Statement of Authorization. To be completed by the applicant, if an agent is to be employed.

Block 12. Proposed Nationwide Permit Activity Name or Title. Please provide a name identifying the proposed NWP activity, e.g., Windward Marina, Rolling Hills Subdivision, or Smith Commercial Center.

Block 13. Name of Waterbody. Please provide the name (if it has a name) of any stream, lake, marsh, or other waterway to be directly impacted by the NWP activity. If it is a minor (no name) stream, identify the waterbody the minor stream enters.

Block 14. Proposed Activity Street Address. If the proposed NWP activity is located at a site having a street address (not a box number), please enter it in Block 14.

Block 15. Location of Proposed Activity. Enter the latitude and longitude of where the proposed NWP activity is located. Indicate whether the project location provided is the center of the project or whether the project location is provided as the latitude and longitude for each of the "corners" of the project area requiring evaluation. If there are multiple sites, please list the latitude and longitude of each site (center or corners) on a separate sheet of paper and mark as Block 15.

Block 16. Other Location Descriptions. If available, provide the Tax Parcel Identification number of the site, Section, Township, and Range of the site (if known), and / or local Municipality where the site is located.

Block 17. Directions to the Site. Provide directions to the site from a known location or landmark. Include highway and street numbers as well as names. Also provide distances from known locations and any other information that would assist in locating the site. You may also provide a description of the location of the proposed NWP activity, such as lot numbers, tract numbers, or you may choose to locate the proposed NWP activity site from a known point (such as the right descending bank of Smith Creek, one mile downstream from the Highway 14 bridge). If a large river or stream, include the river mile of the proposed NWP activity site if known. If there are multiple locations, please indicate directions to each location on a separate sheet of paper and mark as Block 17.

Block 18. Identify the Specific Nationwide Permit(s) You Propose to Use. List the number(s) of the Nationwide Permit(s) you want to use to authorize the proposed activity (e.g., NWP 29).

Block 19. Description of the Proposed Nationwide Permit Activity. Describe the proposed NWP activity, including the direct and indirect adverse environmental effects the activity would cause. The description of the proposed activity should be sufficiently detailed to allow the district engineer to determine that the adverse environmental effects of the activity will be no more than minimal. Identify the materials to be used in construction, as well as the methods by which the work is to be done.

Provide sketches when necessary to show that the proposed NWP activity complies with the terms of the applicable NWP(s). Sketches usually clarify the activity and result in a quicker decision. Sketches should contain sufficient detail to provide an illustrative description of the proposed NWP activity (e.g.,a conceptual plan), but do not need to be detailed engineering plans.

The written descriptions and illustrations are an important part of the application. Please describe, in detail, what you wish to do. If more space is needed, attach an extra sheet of paper marked Block 19.

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Block 20. Description of Proposed Mitigation Measures. Describe any proposed mitigation measures intended to reduce the adverse environmental effects caused by the proposed NWP activity. The description of any proposed mitigation measures should be sufficiently detailed to allow the district engineer to determine that the adverse environmental effects of the activity will be no more than minimal and to determine the need for compensatory mitigation or additional mitigation measures.

Block 21. Purpose of Nationwide Permit Activity. Describe the purpose and need for the proposed NWP activity. What will it be used for and why? Also include a brief description of any related activities associated with the proposed project. Provide the approximate dates you plan to begin and complete all work.

Block 22. Quantity of Wetlands, Streams, or Other Types of Waters Directly Affected by the Proposed Nationwide Permit Activity. For discharges of dredged or fill material into waters of the United States, provide the amount of wetlands, streams, or other types of waters filled, flooded, excavated, or drained by the proposed NWP activity. For structures or work in navigable waters of the United States subject to Section 10 of the Rivers and Harbors Act of 1899, provide the amount of navigable waters filled, dredged, or occupied by one or more structures (e.g., aids to navigation, mooring buoys) by the proposed NWP activity.

For multiple NWPs, or for separate and distant crossings of waters of the United States authorized by NWPs 12 or 14, attach an extra sheet of paper marked Block 21 to provide the quantities of wetlands, streams, or other types of waters filled, flooded, excavated, or drained (or dredged or occupied by structures, if in waters subject to Section 10 of the Rivers and Harbors Act of 1899) for each NWP. For NWPs 12 and 14, include the amount of wetlands, streams, or other types of waters filled, flooded, excavated, or drained for each separate and distant crossing of waters or wetlands. If more space is needed, attach an extra sheet of paper marked Block 22.

Block 23. Identify Any Other Nationwide Permit(s), Regional General Permit(s), or Individual Permit(s) Used to Authorize Any Part of Proposed Activity or Any Related Activity. List any other NWP(s), regional general permit(s), or individual permit(s) used or intended to be used to authorize any part of the proposed project or any related activity. For linear projects, list other separate and distant crossings of waters and wetlands authorized by NWPs 12 or 14 that do not require PCNs. If more space is needed, attach an extra sheet of paper marked Block 23.

Block 24. Compensatory Mitigation Statement for Losses of Greater Than 1/10-Acre of Wetlands When Pre-Construction Notification is Required. Paragraph (c) of NWP general condition 23 requires compensatory mitigation at a minimum one-for-one replacement ratio will be required for all wetland losses that exceed 1/10-acre and require pre-construction notification, unless the district engineer determines in writing that either some other form of mitigation is more environmentally appropriate or the adverse environmental effects of the proposed NWP activity are no more than minimal without compensatory mitigation, and provides an activity-specific waiver of this requirement. Describe the proposed compensatory mitigation for wetland losses greater than 1/10 acre, or provide an explanation of why the district engineer should not require wetland compensatory mitigation for the proposed NWP activity. If more space is needed, attach an extra sheet of paper marked Block 24.

Block 25. Is Any Portion of the Nationwide Permit Activity Already Complete? Describe any work that has already been completed for the NWP activity.

Block 26. List the Name(s) of Any Species Listed As Endangered or Threatened under the Endangered Species Act that Might be Affected by the Nationwide Permit Activity. If you are not a federal agency, and if any listed species or designated critical habitat might be affected or is in the vicinity of the proposed NWP activity, or if the proposed NWP activity is located in designated critical habitat, list the name(s) of those endangered or threatened species that might be affected by the proposed NWP activity or utilize the designated critical habitat that might be affected by the proposed NWP activity. If you are a Federal agency, and the proposed NWP activity requires a PCN, you must provide documentation demonstrating compliance with Section 7 of the Endangered Species Act.

Block 27. List Any Historic Properties that Have the Potential to be Affected by the Nationwide Permit Activity. If you are not a Federal agency, and if any historic properties have the potential to be affected by the proposed NWP activity, list the name(s) of those historic properties that have the potential to be affected by the proposed NWP activity. If you are a Federal agency, and the proposed NWP activity requires a PCN, you must provide documentation demonstrating compliance with Section 106 of the National Historic Preservation Act.

Block 28. List the Wild and Scenic River or Congressionally Designated Study River if the Nationwide Permit Activity Would Occur in such a River. If the proposed NWP activity will occur in a river in the National Wild and Scenic River System or in a river officially designated by Congress as a "study river" under the Wild and Scenic Rivers Act, provide the name of the river. For a list of Wild and Scenic Rivers and study rivers, please visit https://www.rivers.gov/.

Block 29. Nationwide Permit Activities that also Require Permission from the Corps Under 33 U.S.C. 408. If the proposed NWP activity also requires permission from the Corps under 33 U.S.C. 408 because it will temporarily or permanently alter, occupy, or use a Corps federal authorized civil works project, indicate whether you have submitted a written request for section 408 permission from the Corps district having jurisdiction over that project.

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Block 30. Other Information Required For Nationwide Permit Pre-Construction Notifications. The terms of some of the Nationwide Permits include additional information requirements for preconstruction notifications:

- * NWP 3, Maintenance –information regarding the original design capacities and configurations of the outfalls, intakes, small impoundments, and canals.
- * NWP 31, Maintenance of Existing Flood Control Facilities -a description of the maintenance baseline and the dredged material disposal site.
- * NWP 33, Temporary Construction, Access, and Dewatering –a restoration plan showing how all temporary fills and structures will be removed and the area restored to pre-project conditions.
- * NWP 44, Mining Activities –if reclamation is required by other statutes, then a copy of the final reclamation plan must be submitted with the pre-construction notification.
- * NWP 45, Repair of Uplands Damaged by Discrete Events –documentation, such as a recent topographic survey or photographs, to justify the extent of the proposed restoration.
- * NWP 48, Commercial Shellfish Aquaculture Activities –(1) a map showing the boundaries of the project area, with latitude and longitude coordinates for each corner of the project area; (2) the name(s) of the species that will be cultivated during the period this NWP is in effect; (3) whether canopy predator nets will be used; (4) whether suspended cultivation techniques will be used; and (5) general water depths in the project area (a detailed survey is not required).
- * NWP 49, Coal Remining Activities –a document describing how the overall mining plan will result in a net increase in aquatic resource functions must be submitted to the district engineer and receive written authorization prior to commencing the activity.
- * NWP 50, Underground Coal Mining Activities –if reclamation is required by other statutes, then a copy of the reclamation plan must be submitted with the pre-construction notification.

If more space is needed, attach an extra sheet of paper marked Block 30.

Block 31. Signature of Applicant or Agent. The PCN must be signed by the person proposing to undertake the NWP activity, and if applicable, the authorized party (agent) that prepared the PCN. The signature of the person proposing to undertake the NWP activity shall be an affirmation that the party submitting the PCN possesses the requisite property rights to undertake the NWP activity (including compliance with special conditions, mitigation, etc.).

DELINEATION OF WETLANDS, OTHER SPECIAL AQUATIC SITES, AND OTHER WATERS

Each PCN must include a delineation of wetlands, other special aquatic sites, and other waters, such as lakes and ponds, and perennial, intermittent, and ephemeral streams, on the project site. Wetland delineations must be prepared in accordance with the current wetland delineation manual and regional supplement published by the Corps. The permittee may ask the Corps to delineate the special aquatic sites and other waters on the project site, but there may be a delay if the Corps does the delineation, especially if the project site is large or contains many wetlands, other special aquatic sites, and other waters. The 45 day PCN review period will not start until the delineation is submitted or has been completed by the Corps.

DRAWINGS AND ILLUSTRATIONS

General Information.

Three types of illustrations are needed to properly depict the work to be undertaken. These illustrations or drawings are identified as a Vicinity Map, a Plan View or a Typical Cross-Section Map. Identify each illustration with a figure or attachment number. For linear projects (e.g. roads, subsurface utility lines, etc.) gradient drawings should also be included. Please submit one original, or good quality copy, of all drawings on 8½x11 inch plain white paper (electronic media may be substituted). Use the fewest number of sheets necessary for your drawings or illustrations. Each illustration should identify the project, the applicant, and the type of illustration (vicinity map, plan view, or cross-section). While illustrations need not be professional (many small, private project illustrations are prepared by hand), they should be clear, accurate, and contain all necessary information.


ADDITIONAL INFORMATION AND REQUIREMENTS

For proposed NWP activities that involve discharges into waters of the United States, water quality certification from the State, Tribe, or EPA must be obtained or waived (see NWP general condition 25). Some States, Tribes, or EPA have issued water quality certification for one or more NWPs. Please check the appropriate Corps district web site to see if water quality certification has already been issued for the NWP(s) you wish to use. For proposed NWP activities in coastal states, state Coastal Zone Management Act consistency concurrence must be obtained, or a presumption of concurrence must occur (see NWP general condition 26). Some States have issued Coastal Zone Management Act consistency concurrences for one or more NWPs. Please check the appropriate Corps district web site to see if Coastal Zone Management Act consistency concurrence has already been issued for the NWP(s) you wish to use.

ENG FORM 6082, OCT 2019 Page 6 of 6


ATTACHMENT A

Site Maps of the Subject Property

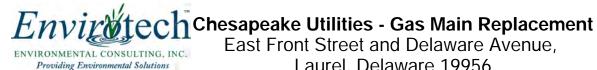

East Front Street and Delaware Avenue, Laurel, Delaware 19956



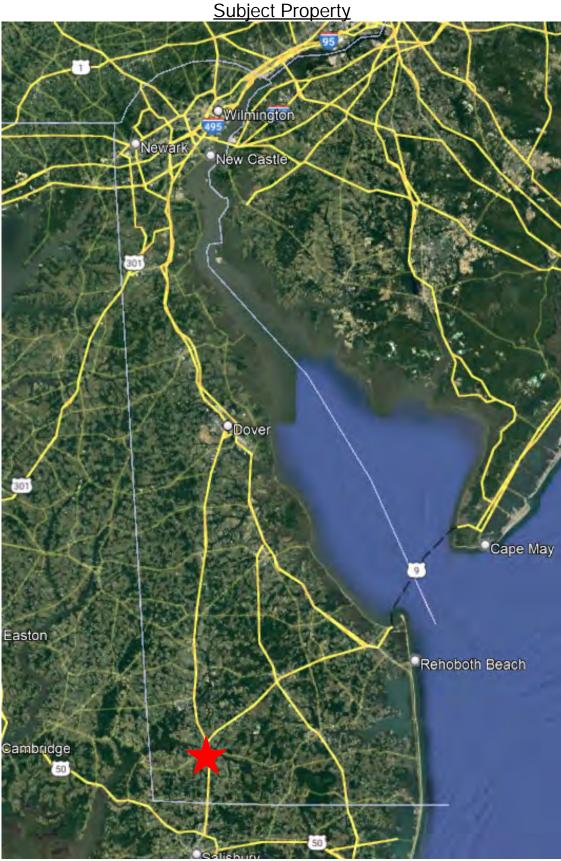


LEGEND:

NOTE*Imagery Taken From Google Earth Pro*




Chesapeake Utilities - Gas Main Replacement

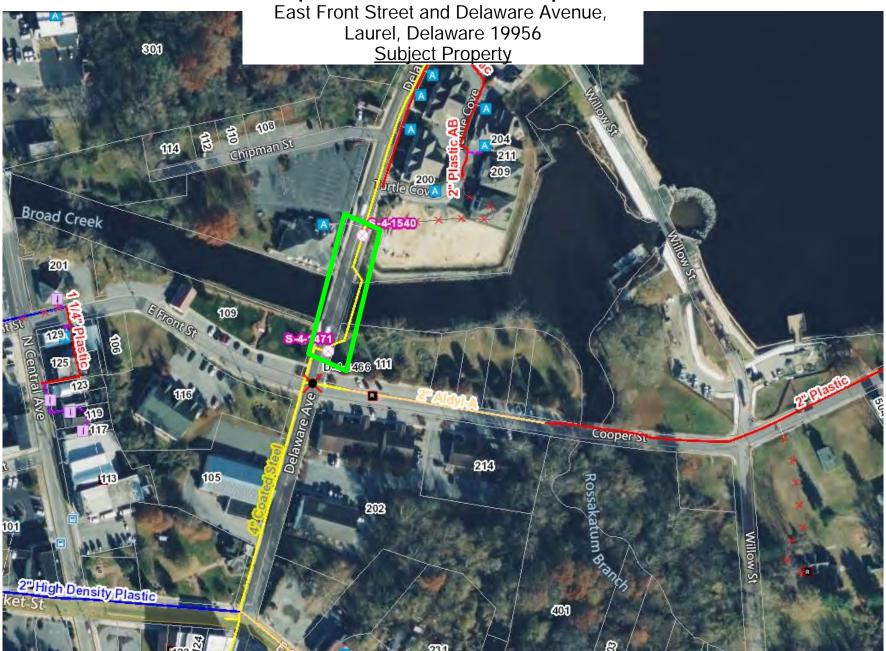



NOTE*Imagery Taken From Chesapeake Utilties GIS*




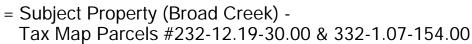




ATTACHMENT B

Chesapeake Utilities – Profile and Plan View

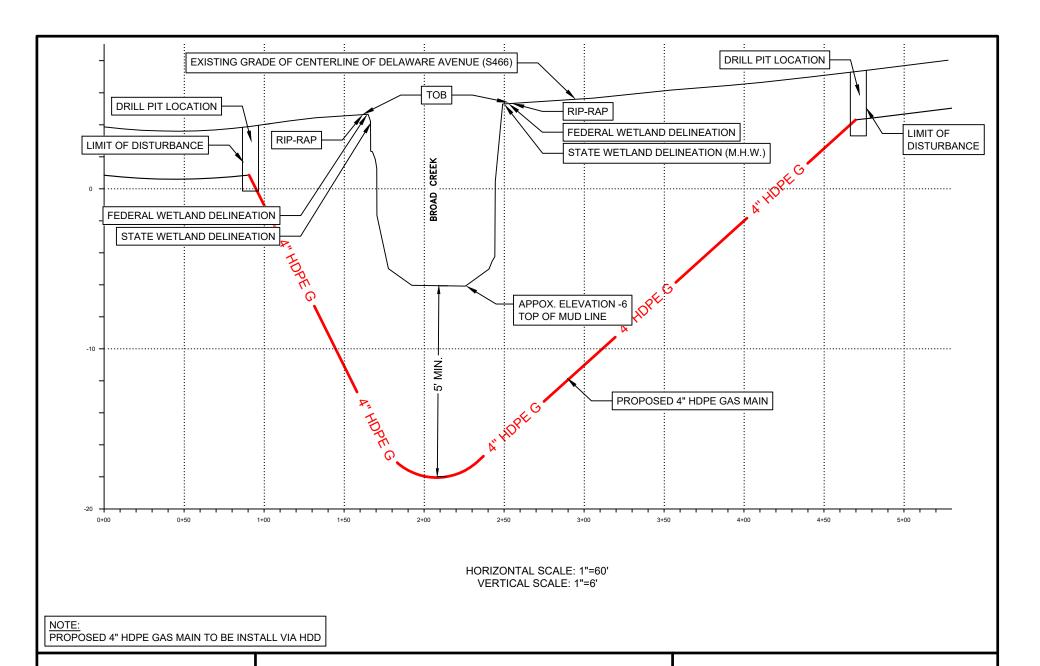



PROPOSED 4" HDPE GAS MAIN
DELAWARE AVENUE (S466) AND BROAD CREEK
DRAWN: 2022.07.12
SUSSEX COUNTY, DELAWARE

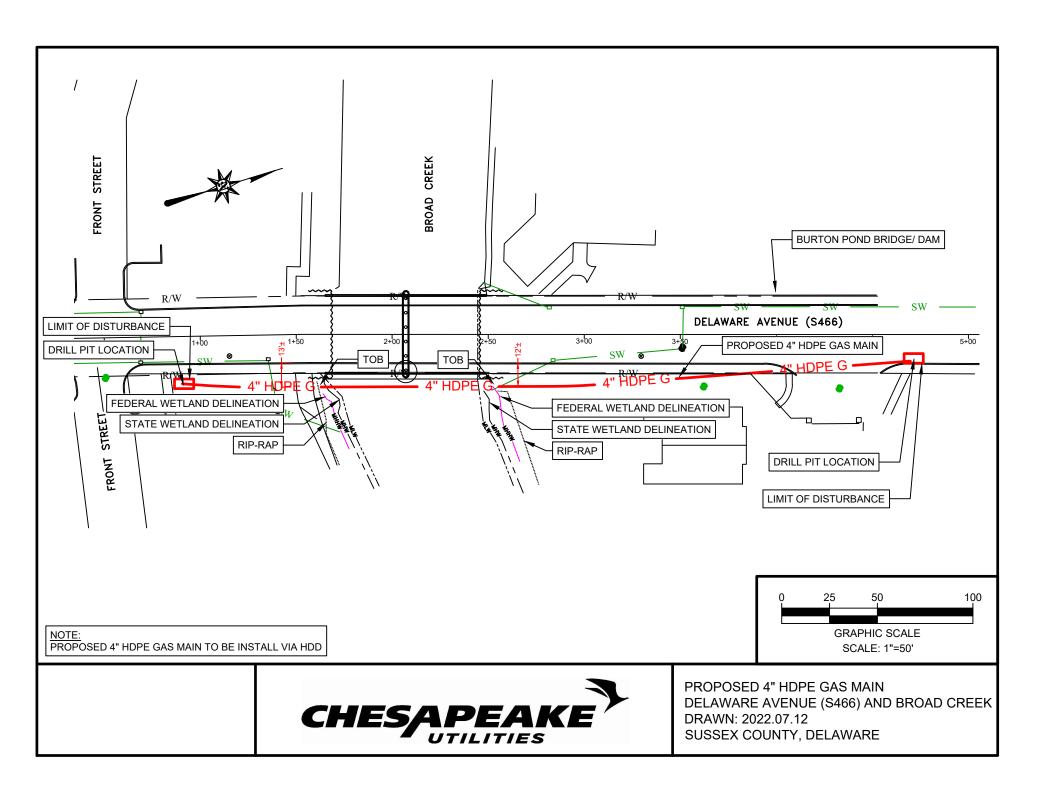

ATTACHMENT C

Chesapeake Utilities – Sequence of Construction and Frac-out Contingency Plan

Sequence of Construction:

- Schedule pre-construction meeting with DelDOT and the Town of Laurel five (5) days prior to commencing any site work.
- Notify Miss Utility (811) a minimum of two (2) full business days prior to any construction activity. Construction activities shall not commence until all utilities have responded to the miss utility ticket.
- Install maintenance of traffic as approved by DelDOT.
- Install erosion and sedimentation control structures, as needed.
- Test pit existing utilities to confirm location and depth.
- Excavate the sending and receiving pits as shown on the construction documents.
- Setup HDD machine at the sending pit.
- Bore under Broad Creek to receiving pit.
- Pull back 4-inch HDPE pipe.
- Tie the 4-inch HDPE gas main into the existing gas main at both ends.
- Backfill sending and receiving pits with suitable fill.
- Remove erosion and sedimentation control structures, as needed.
- Clean up all excavations and complete restoration.
- Complete final inspection by DelDOT and the Town of Laurel.

CHESAPEAKE UTILITIES BROAD CREEK CROSSING HORTIZONTAL DIRECTIONAL DRILLING FRAC-OUT CONTINGENCY PLAN

Purpose and Objective

The purpose of this document is to identify procedures to be followed in the event of a frac-out during horizontal directional drilling operations for the Broad Creek gas main replacement project in Laurel, Delaware. A frac-out is a condition in which drilling mud is released through fractures in the soil and migrates toward the surface. Drilling mud consists mainly of a bentonite clay-water mixture, which is not considered to be hazardous or toxic. However, the objective is to minimize the potential of a frac-out and identify response measures in the event that a frac-out occurs, in order to mitigate any potential adverse impact to water bodies and associated habitats. Escape of drilling mud from a frac-out is most common near the directional drill entry and exit locations. However, frac-outs can occur at any location along a directional drill.

This Frac-Out Contingency Plan provides operational procedures and responsibilities for the prevention, containment and clean-up of frac-outs associated with horizontal directional drilling operations.

The objectives of this plan are as follows:

- Minimize the potential for a frac-out due to horizontal directional drilling operations.
- Identify timely detection of frac-outs.
- Provide for environmental protection of the water bodies and associated habitats.
- Establish response procedures in the event of a frac-out.
- Provide for notifications to the applicable parties and regulatory agencies.

Scope of Work for Horizontal Directionally Drilled Crossings

The pipeline alignment drawings show the targeted entry and exit locations and staging areas. These layouts are designed to minimize the potential for impact to the water bodies. The significant clearance between the bottom of the water bodies and the top of the proposed pipeline provides additional protection for the water bodies.

Inspection

A Project Superintendent will be on-site at all times during horizontal directional drilling operations. The Project Superintendent will be experienced in directional drilling and the associated environmental protection measures. The Project Superintendent will ensure that the proper equipment and materials are available on-site at all times, and that the necessary procedures are followed on a daily basis.

Mitigation Measures

- The Project Superintendent will contact Chesapeake Utilities District Operations in the event of a frac-out. Chesapeake Utilities will contact DNREC. Prior to construction, a complete list of applicable regulatory agencies will be prepared and available at the job site.
- All equipment will be checked and maintained daily to prevent hazardous material leaks.
- Sufficient supplies of spill containment materials and hay bales will be available on-site at all times. A vacuum truck will also be available at all times.
- Frac-out barrels will be located on-site at all times.
- Entry and exit drill pits will be contained using berms, silt fence and/or hay bales.
- Visual observation (on-land and water bodies) will occur on a regular basis throughout directional drilling operations so that a potential surface frac-out can be identified.
- Directional drilling operations will be suspended immediately upon evidence of a drop in drilling pressure, lack of drilling mud returns at the entrance pit or other evidence of a fracout.
- In the event of a frac-out, the on-site Project Superintendent will evaluate the situation and provide direction for mitigation actions.
- All drilling bentonite will be recycled through a reclaimer system.
- Clean up of all frac-outs/spills shall begin immediately.
- In the event of a frac-out that reaches the surface but not the water body, bentonite shall be contained, removed and disposed of at an approved facility.
- In the unlikely event that a frac-out reaches the water body, corrective action will be taken immediately. Clean-up work will be performed by hand to the maximum extent practicable. A vacuum truck would be used to vacuum up the associated bentonite and soils as necessary. The materials will be properly disposed of at an approved facility. Clean sand would be replaced in the riverbed if necessary.
- All cleanup materials will be disposed on a daily basis as applicable, and at the completion of the project.
- In the event that a drill hole must be abandoned, the bore will be sealed by the injection of a high-viscosity bentonite slurry.
- Construction operations will not be allowed to re-start until approved by the on-site Project Superintendent.
- Documentation will be prepared for any frac-outs that occur during directional drilling operations.

ATTACHMENT D

AgroLab - Soil Lab Results



Account No.: 3570 Soil Analysis Report

Invoice No.: 1136409

Extraction Method: Mehlich 3

Date Received : 08/15/2022 Date Analyzed: 08/16/2022

Lab Number: 15012

ENVIROTECH ENVIRONMENTAL CONSULT 17605 NASSAU COMMONS BLVD LEWES DE 19958

Results For: ENVIROTECH Location: BROAD CREEK

Sample ID: MAIN REPLACEMENT

Reviewed By: L.D. Severson - AgroLab Inc

			Sufficien	cy Levels	
	Analysis	Deficient	Low	Sufficient	High
pH	7.3				
Buffer pH	7.0		•		
Soluble Salts, EC mmho/cm	0.09			抻	
Nitrate-N, ppm N	3.6				
Nitrate-N, Lbs N/A	9.00				
Depth	0 - 8 in				
Ammonium-N ppm	44.3				
Phosphorus, ppm P	41				
P Saturation	36				
UMD P FIV	47				
Potassium, ppm K	38				
Calcium, ppm Ca	421				
Magnesium, ppm Mg	51				
Sulfur, ppm S	9				
Boron, ppm B	0.60				
Zinc, ppm Zn	13.70				
Manganese, ppm Mn pH sensitive	26.0				
Copper, ppm Cu	2.06				
Sodium, ppm Na	21				
CEC Sum of Cations, meq/100g	2.8				
H % Saturation	3				
K % Saturation	4				
Ca % Saturation	75				
Mg % Saturation	15				
Na % Saturation	3				
Organic Matter, %	0.8				
Organic Matter (LOI @ 455 C), %	1.44				
Est. Organic Carbon, %	0.45				
Aluminum, ppm Al	180.0				
Iron, ppm Fe	190.0				

8/16/2022

Copy: 1

Page 1 of 4



Account No.: 3570 Soil Analysis Report

Invoice No.: 1136409

Date Received: 08/15/2022

Date Analyzed: 08/16/2022

Extraction Method: Mehlich 3

DE 19958 Lab Number: 15012

Results For: ENVIROTECH

LEWES

Location: BROAD CREEK

Sample ID: MAIN REPLACEMENT

17605 NASSAU COMMONS BLVD

ENVIROTECH ENVIRONMENTAL CONSULT

USDA Soil Texture Sand
Sand, % 88
Silt, % 7
Clay, % 5

Reviewed By: L.D. Severson - AgroLab Inc 8/16/2022 Copy: 1 Page 2 of 4

ATTACHMENT E

DelDOT Right-of-Way Plans

GENERAL LOCATION OF CONTRACT

PREPARED BY DELDOT - TRANSPORTATION SOLUTIONS

THIS SEAL APPLIES TO ALL SHEETS BEARING THE "BR" SECTION DESIGNATION.

08/04/2020 DATE

THE STATE OF DELAWARE DEPARTMENT OF TRANSPORTATION




CONSTRUCTION AND RIGHT-OF-WAY PLANS FOR:

BR 3-162 ON S466 DELAWARE AVE **OVER BROAD CREEK**

CONTRACT NUMBER: T201607602 FEDERAL AID PROJECT NUMBER: EBHOS-S466(02)

> COUNTY: SUSSEX M.R. #: <u>\$466</u>

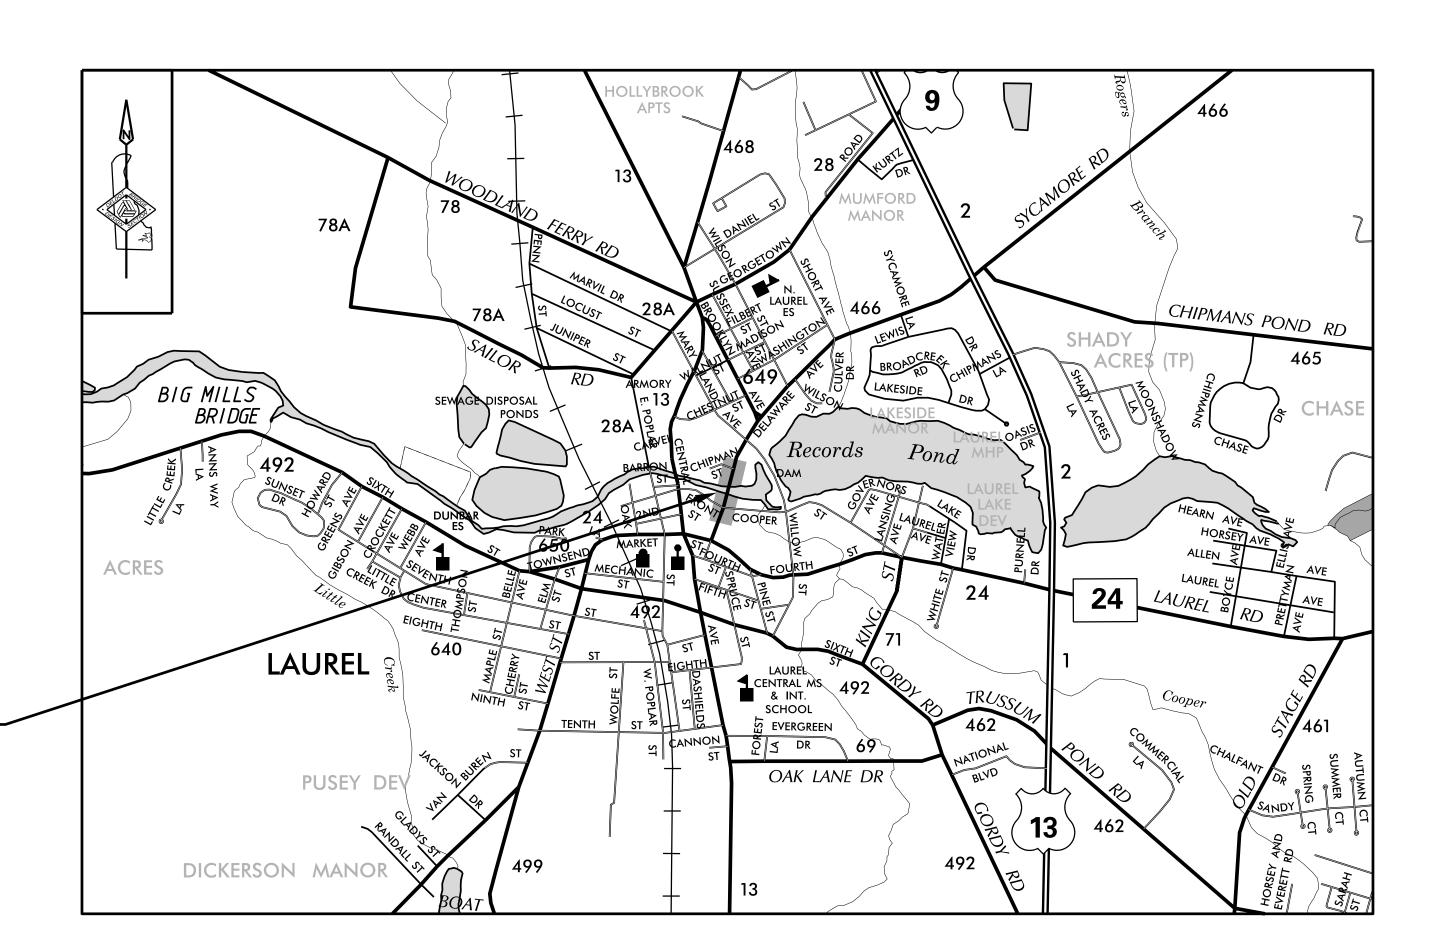

U.S. CUSTOMARY MRD #: 5466 UNITS

FUNCTIONAL CLASS:			D.H.V. PROJECTE		YEAR: 2
TYPE OF CONSTRUCTION: BRIDGE REHABILITATION		DESIGN SPEED: 30 M.P.H.			
A.A.D.T. CURRENT: 1380 YEAR: 2014		YEAR: 2014	TRUCKS: 12%		
A.A.D.T. PROJECTED		YEAR: 2040		ISTRIBUTION: 60%	
A	<u>PPROV</u>	<u>ED DESI</u>	<u> SN EXCEP</u>	TIONS	
DESIGN	I PARAMETER		REQUIRED	PROVIDED	DAT
	ADI) ENDA	REVISION	IS	
	ΔSS	OCIATED	CONTRA	CTS	
CONTRACT NO.		OOIATEL	CONTRACT NAM		
64-01-015	BRIDGE 162 ON DELAWARE AVENUE LAUREL OVER BROAD CREEK				
613	DELAWARE AVENUE LAUREL, BROOKLYN AVENUE TO MARKET STREET				
	l				

DESIGN DESIGNATION

ROAD NAME: DELAWARE AVENUE

APPROVED FOR ADVE	RTISEMENT
Muz	08/05/2020
DIRECTOR OF TRANSPORTATION SOLUTIONS	DATE

SEAL

SECTION	SHEET DESCRIPTION	SHEET NO(S)
BR	TITLE	1
BR	INDEX OF SHEETS	2
BR	ADDENDA AND REVISIONS	3
BR	LEGEND	4
BR	NOTES	5
BR	TYPICAL SECTION	6
BR	CONSTRUCTION PLAN	7
BR	PROFILE	8
BR	BRIDGE PLAN AND ELEVATION	9
BR	BRIDGE EXISTING AND PROPOSED SECTION	10
BR	ABUTMENT DETAILS	11
BR	PILE BENT DETAILS	12
BR	EXTERIOR BEAM DETAILS	13
BR	INTERIOR BEAM DETAILS	14
BR	SHEAR KEY DETAILS	15
BR	FRAMING PLAN	16
BR	INTEGRATED APPROACH DETAILS	17
BR	BRIDGE PARAPET DETAILS	18
BR	BRIDGE RAIL DETAILS	19
BR	CONSTRUCTION SEQUENCE AND EROSION AND SEDIMENT CONTROL NOTES	20
BR	EROSION AND SEDIMENT CONTROL PLAN	21
BR	ENVIRONMENTAL COMPLIANCE NOTES	22
BR	ENVIRONMENTAL COMPLIANCE PLAN	23
TS	VEHICULAR DETOUR PLAN	24
TS	PEDESTRIAN DETOUR PLAN	25
BR	UTILITY RELOCATION PLAN	26
BR	SIGNING AND STRIPING PLAN	27
WRA	RRFB SIGNAL PLAN	28
BR	RIGHT-OF-WAY PLAN	29
BR	RIGHT-OF-WAY DATA AND TABULATION SHEET	30

09:24 Y:\SUSSEX\466\Bridge\T201607602\500_CADD\530_PLANS_DGN\IS01.dgn

ADDENDA / REVISIONS

BR 3-162 ON
S466 DELAWARE AVE
OVER BROAD CREEK

BRIDGE NO. 3-162

DESIGNED BY: S. WEAVER

CHECKED BY: S. WALLS


INDEX OF SHEETS

SHEET NO.

T201607602

COUNTY

SUSSEX

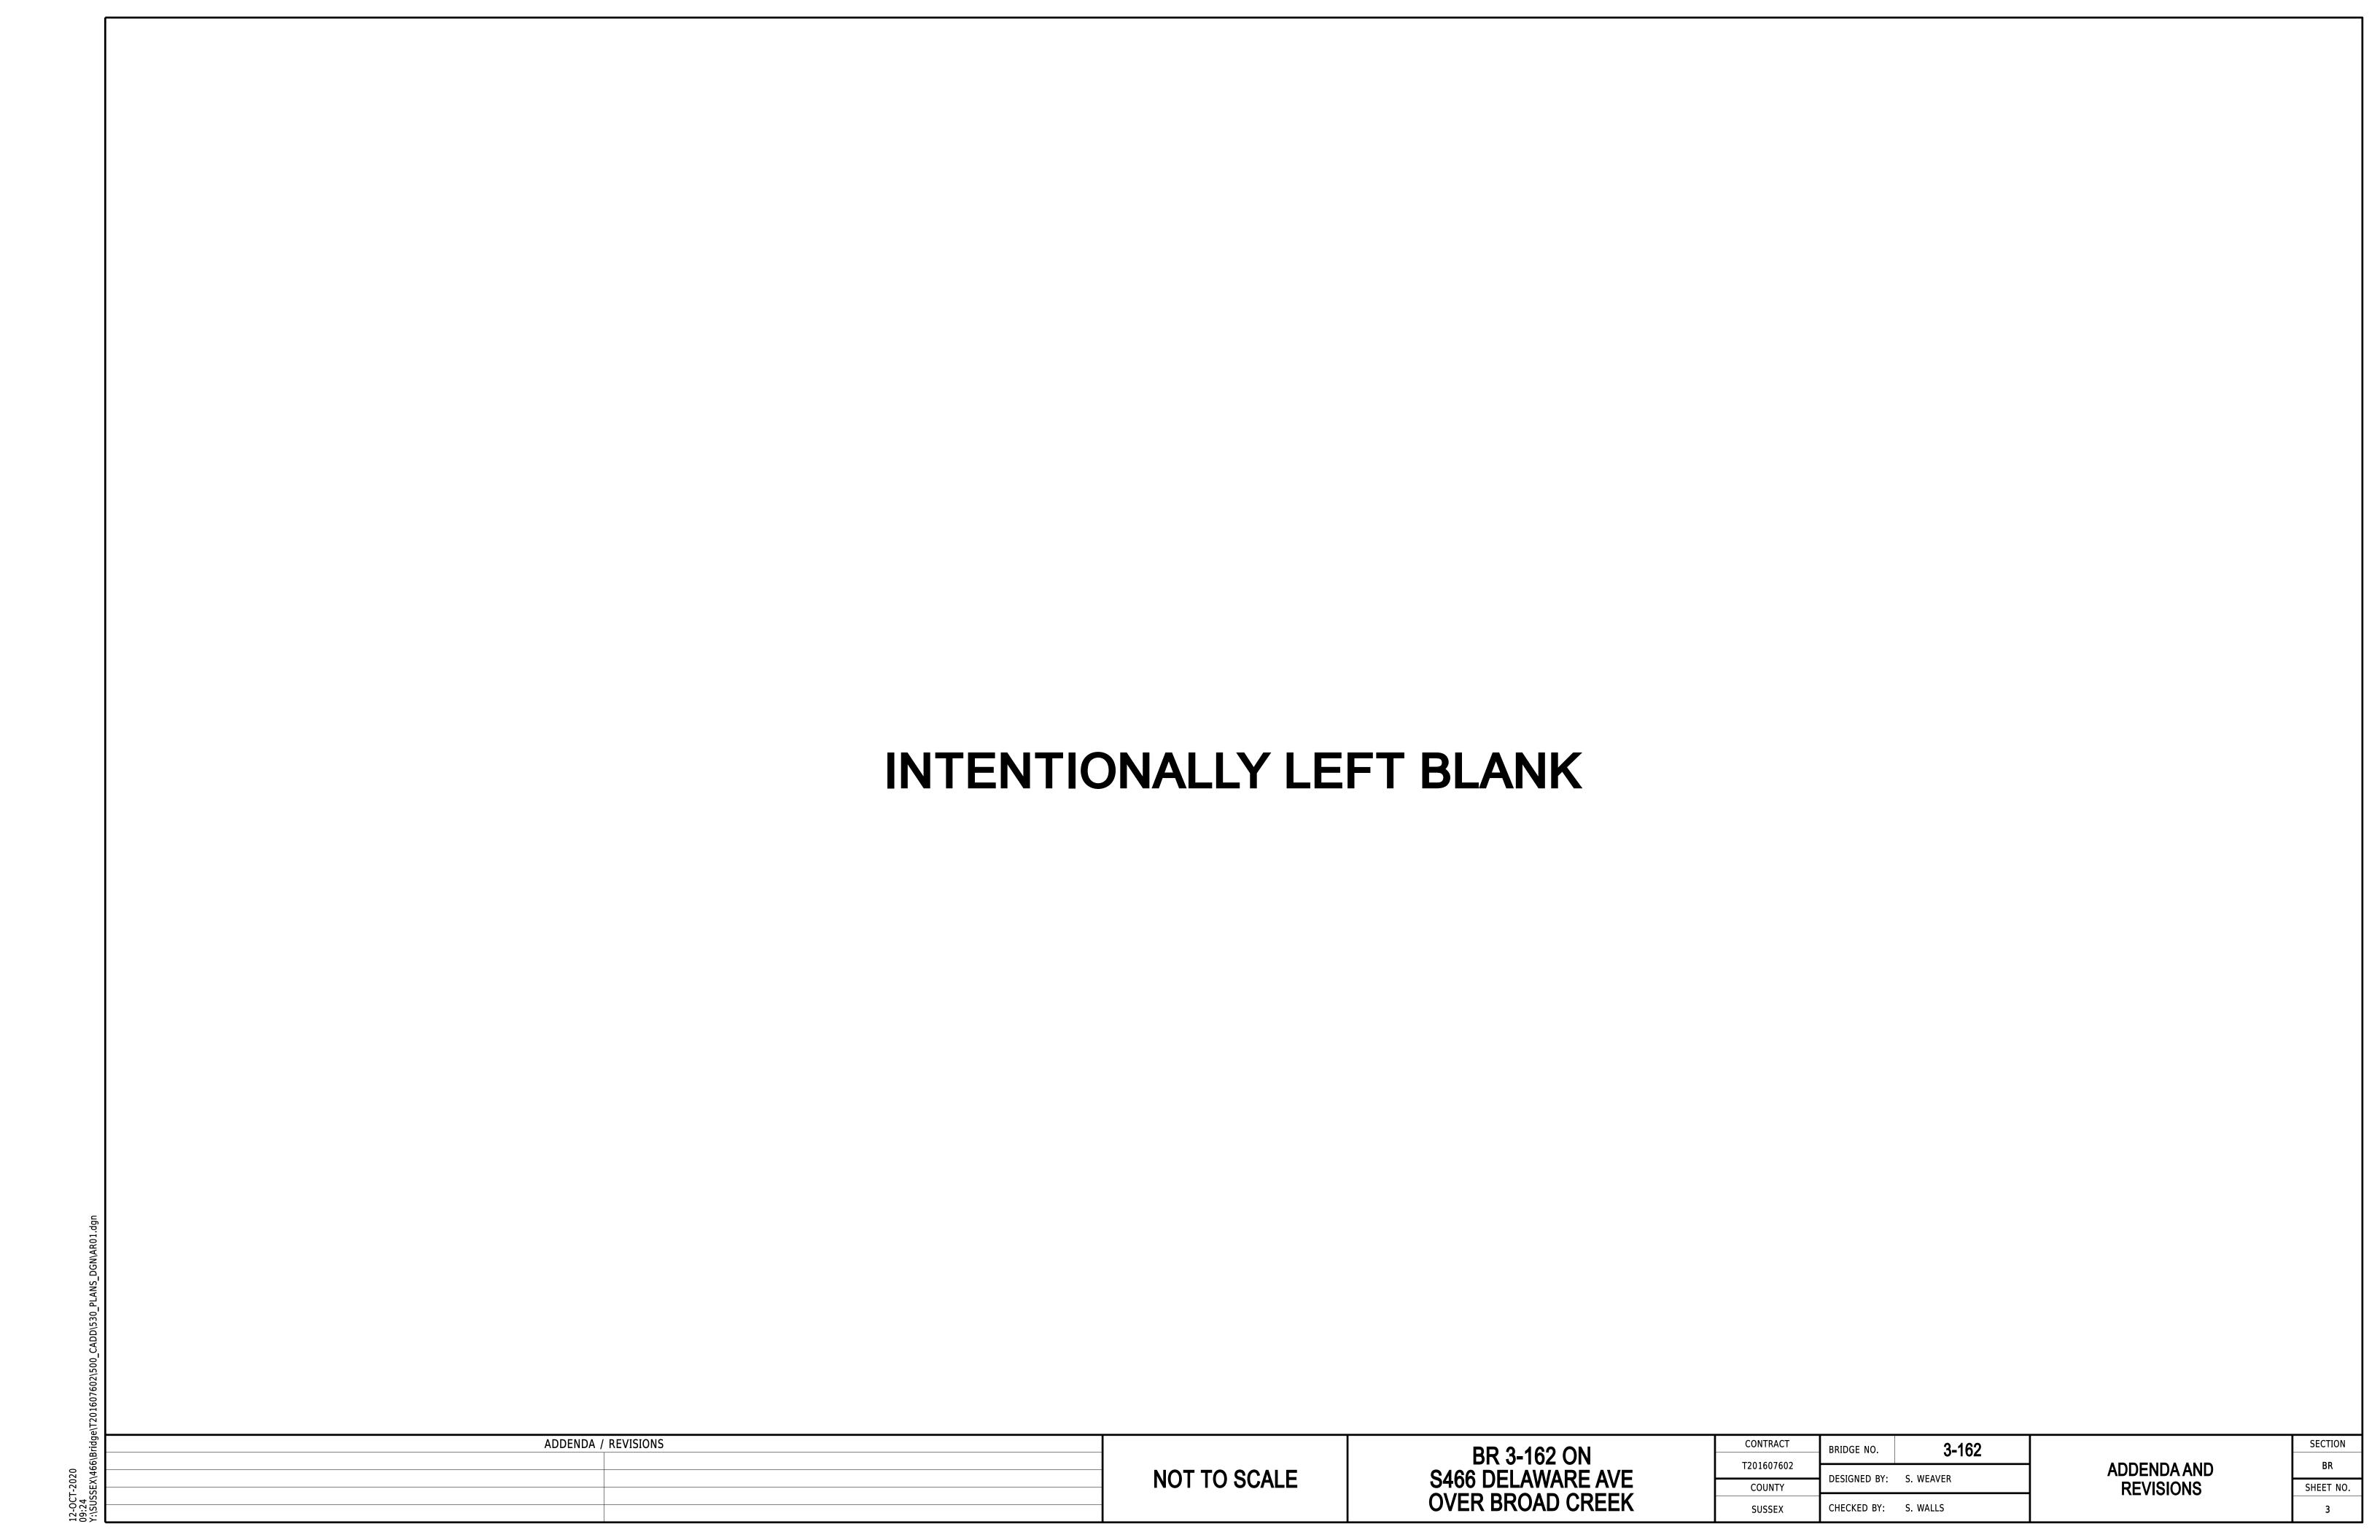

EXISTING SYMBOLS

	DRAINAGE
	DITCH OR STREAM CENTERLINE
_	DIRECTIONAL STREAM FLOW ARROW
C.B. D.I.	DRAINAGE INLET
J.B.	DRAINAGE JUNCTION BOX
D	DRAINAGE MANHOLE
_ SIZE/TYPE LABEL _	DRAINAGE PIPE AND FLOW ARROW
	DRAINAGE PIPE HEADWALL
	RIPRAP - AREA FEATURE
∞	RIPRAP - LINEAR FEATURE

MANI	MADE DOADSIDE EEATLIDES
	MADE ROADSIDE FEATURES
©	BOLLARD - STEEL POLE
\boxtimes	BOLLARD - WOOD POST
(TYPE LABEL)	CURB
(TYPE LABEL)	CURB AND GUTTER
—х——	FENCE - CHAINLINK OR STRANDED
	FENCE - STOCKADE OR SPLIT RAIL
F.P. ⊕	FLAG POLE
	GUARDRAIL - STEEL BEAM
	GUARDRAIL - WIRE ROPE
LAMP	LAMP AND POST - RESIDENTIAL
MB	MAILBOX
P.M. ⊕	PARKING METER AND POST
	PAVEMENT - FLEXIBLE
	PAVEMENT - RIGID
	PILE - BRIDGE
0	PILLAR OR MISCELLANEOUS POST
7	TRAFFIC SIGN AND POST
·	WALL - BRICK OR BLOCK
0000	WALL - STONE

NATURAL ROADSIDE FEATURES		
ΔVz	GRASS LAWN	
ancancanca	HEDGEROW OR THICKET	
	MARSH BOUNDARY LINE	
*	TREE - CONIFEROUS	
	TREE - DECIDUOUS	
点	TREE STUMP	
©	SHRUBBERY	
WL	DELINEATED WETLAND BOUNDARY LINE	
	WOODS LINE BOUNDARY	

	RIGHT-OF-WAY SYMBOLS
C.M.	PROPERTY MARKER - CONCRETE MON.
I.P.	PROPERTY MARKER - IRON PIPE
100+00	HISTORIC RIGHT-OF-WAY BASELINE
	EXISTING RIGHT-OF-WAY
	EXISTING PROPERTY LINE
EASEMENT TYPE	EXISTING EASEMENT
DA	EXISTING DENIAL OF ACCESS
R/W-DA	EXISTING R/W & DENIAL OF ACCESS

SURVEY CONTROL & MONUMENTATION SURVEY BENCHMARK LOCATION T.P. SURVEY TIE POINT LOCATION SURVEY TRAVERSE POINT POINT OF CURVATURE OR TANGENCY

_			
0	POINT OF INTERSECTING TANGENTS		
I ITII ITV			
•	SOIL BORING LOCATION		
•	UTILITY TEST HOLE LOCATION		
TV	CABLE TV DISTRIBUTION BOX		
(E)	ELECTRIC MANHOLE		
EM	ELECTRIC METER		
E	ELECTRIC TRANSFORMER		
<u> </u>	POLE MOUNTED LUMINAIRE		
<u>©</u>	GAS MANHOLE		
G.M.	GAS METER		
G.V.	GAS VALVE		
G.P.	GAS PUMP - SERVICE STATION		
	RAILROAD TRACKS		
(\$)	SANITARY SEWER MANHOLE		
S.V.	SANITARY SEWER VALVE		
S.C.O.	SANITARY SEWER CLEANOUT OR VENT		
S.D.F.	SEPTIC DRAIN FIELD		
В	TELEPHONE BOOTH		
T	TELEPHONE MANHOLE		
T	TELEPHONE TEST POINT		
J.W.	TRAFFIC - CONDUIT JUNCTION WELL		
	TRAFFIC - LIGHT POLE AND BASE		
	TRAFFIC - PEDESTRIAN POLE & BASE		
	TRAFFIC - SIGNAL CABINET & BASE		
⊗	TRAFFIC - SIGNAL POLE AND BASE		
U	UTILITY BOX		
o→	UTILITY POLE GUY WIRE ANCHOR		
Ø	UTILITY POLE		
F.H.	WATER - FIRE HYDRANT		
W.M.	WATER METER		
WV °	WATER VALVE		
WELL	WELL HEAD		
?	MANHOLE - UNDETERMINED OWNER		

——————————————————————————————————————	CHESAPEAKE UTILITIES - GAS	
——————————————————————————————————————	COMCAST CABLE / OVERHEAD	
——————————————————————————————————————	DELMARVA POWER-ELECTRIC/OVERHEAD	
——— TL-S (X) ———	TOWN OF LAUREL - SEWER	
——— TL-W (X) ———	TOWN OF LAUREL - WATER	
VER-C (X)	VERIZON	
VER-FO-OH	VERIZON - FIBER OPTIC	
(X) REPRESENTS ASCE DEFINED SUE QUALITY LEVEL		

PROPOSED SYMBOLS

	CONSTRUCTION		IDENTIFIERS
	CONCRETE SAFETY BARRIER - PERMANENT	$\frac{A}{C}$	ADJUST BY CONTRACTOR
×——BFS——×	BIOFILTRATION SWALE	$\frac{A}{c}$	ADJUST BY OTHERS
	BRICK PATTERNED SURFACE	B	CONCRETE SAFETY BARRIER
	BUTT JOINT	C	CURB OR CURB & GUTTER
——————————————————————————————————————	CLEAR ZONE	CJB XXX	CONVERT TO JUNCTION BOX
100+00	CONSTRUCTION BASELINE	CMH	CONVERT TO DRAINAGE MANHOLE
CSF	CONSTRUCTION SAFETY FENCE		CURB OPENING - SUMP / ON GRADE
	CURB, TYPE 1 & TYPE 3	CO	CURB OPENING WITH SIDEWALK
	CURB, TYPE 2	PC	PEDESTRIAN CONNECTION / TYPE
	CURB & GUTTER, TYPE 1	PC-N XXX	PEDESTRIAN CONNECTION / TYPE WITHOUT SIDEWALK SURFACE DETECTABLE WARNING SYSTEM
	CURB & GUTTER, TYPE 2	CSF	CONSTRUCTION SAFETY FENCE
	CURB & GUTTER, TYPE 3	DI	DRAINAGE INLET
	CURB & GUTTER, TYPE 4	DND	DO NOT DISTURB
	CURB OPENING - SUMP / ON GRADE	ED	ENERGY DISSIPATOR
	CURB OPENING WITH SIDEWALK	F	FENCE
	DRAINAGE INLET	FES	FLARED END SECTION
××	DITCH	FF C	FILL WITH FLOWABLE FILL
o	FENCE - METAL / FENCE - WOOD	FS	FILTRATION STRUCTURE
	FLARED END / SAFETY END SECTION	GR XXX	GUARDRAIL
	GUARDRAIL, TYPE 1	JB XXX	JUNCTION BOX
<u> </u>	GUARDRAIL, TYPE 2	MH	MANHOLE
<u> </u>	GUARDRAIL, TYPE 3	M XXX	MONUMENT - RIGHT-OF-WAY
Cn å å	GUARDRAIL END ANCHORAGE	P	PIPE
• • • • • • •	GUARDRAIL END TREATMENT, TYPE 1	RL	RELOCATE BY CONTRACTOR
	GUARDRAIL END TREATMENT, TYPE 2	RL	RELOCATE BY OTHERS
	GUARDRAIL END TREATMENT, TYPE 3	RL	RELOCATE BY PROPERTY OWNER
	IMPACT ATTENUATOR	RM	REMOVE BY CONTRACTOR
	JUNCTION BOX - DRAINAGE	RM	REMOVE BY TRAFFIC CONTRACTOR
LO	LATERAL OFFSET	RM	REMOVE BY OTHERS
LOC	LIMIT OF CONSTRUCTION	SES	SAFETY END SECTION
MB	MAILBOX	UD XXX	UNDERDRAIN / LENGTH
•	MANHOLE	UDO	UNDERDRAIN OUTLET PIPE
	PAVEMENT PATCH		LANDOCADINO
	PAVEMENT REMOVAL - TOPSOIL, SEED AND MULCH		LANDSCAPING
	PIPE & DIRECTIONAL FLOW ARROW	LS	LANDSCAPE PLANTINGS
00000000000000000000000000000000000000	RIPRAP		SHRUBBERY
	P.C.C. SIDEWALK - 4"		CONIFEROUS TREE

TRAFFIC		
ITMS-CON ITMS CONDUIT		
—— SIG-CON ——	SIGNAL CONDUIT	
	CONDUIT JUNCTION WELL	
•	LUMINAIRE	
→	PAVEMENT MARKINGS	
	PAVEMENT STRIPING	
•	TRAFFIC SIGN	

DECIDUOUS TREE

	PAVEMENT SECTION(S)				
		DEPTH VARIES, SUPERPAVE, TYPE C			
		2" SUPERPAVE, TYPE C 8" PORTLAND CEMENT CONCRETE PAVEMENT			
		MILL HOT-MIX TO EXISTING CONCRETE BASE OVERLAY WITH MINIMUM OF 2" CONCRETE, SUPERPAVE, TYPE C			

EROSION & SEDIMENT CONTROL					
—— CFL ——	COMPOST FILTER LOG				
<u>CFL</u>	COMPOST FILTER LOG / LENGTH				
- DWBAG -	DEWATERING BAG				
- DWB	DEWATERING BASIN				
ED /	EARTH DIKE				
(INLET SEDIMENT CONTROL				
======	PERIMETER DIKE/SWALE				
(EST)	PORTABLE SEDIMENT TANK				
SBD	SANDBAG DIKE				
SB	SANDBAG DIVERSION				
2742	STONE CHECK DAM				
SSECT	STABILIZED CONSTRUCTION ENTRANCE				
SF	SILT FENCE / LENGTH				
—— SF ——	SILT FENCE				
(RSF)	REINFORCED SILT FENCE / LENGTH				
—— RSF ——	REINFORCED SILT FENCE				
SSF	SUPER SILT FENCE / LENGTH				
—— SSF ——	SUPER SILT FENCE				
Θ_{SP}	SUMP PIT				
<u>\$1</u>	SEDIMENT TRAP / NUMBER				
ST	SEDIMENT TRAP				
Ş	SEDIMENT TRAP WITH INLET AS OUTLET				
Q- ST	SEDIMENT TRAP PIPE OUTLET				
SW	STILLING WELL				
/=I	TEMPORARY SWALE				
TSD	TEMPORARY SLOPE DRAIN				
T	TURBIDITY CURTAIN / LENGTH				
	TURBIDITY CURTAIN				

UTILITY COMPANY FACILITIES		
—— СОМ-С ——	COMCAST CABLE	
—— DP-E ——	DELMARVA POWER-ELECTRIC	
VER-FO	VERIZON - FIBER OPTIC	

ADDENDA / REVISIONS

BR 3-162 ON S466 DELAWARE AVE OVER BROAD CREEK

CONTRACT	BRIDGE NO.	3-162	
T201607602		0 102	
T201607602	DECICNED BY	C MEAVED	
COUNTY	DESIGNED BY:	5. WEAVER	
SUSSEX	CHECKED BY:	S. WALLS	

LEGEND SHEET NO.

UNDERDRAIN OUTLET

UNDERDRAIN

————PE——— PROPOSED PERMANENT EASEMENT

-----R/W-DA ------ PROPOSED R/W & DENIAL OF ACCESS

---- TCE--- TEMPORARY CONSTRUCTION EASEMENT

100+00

RIGHT-TO-ENTER

P.C.C. SIDEWALK - 6" (USE 8" DEPTH FOR CHANNELIZATION ISLANDS.)

RIGHT-OF-WAY SYMBOLS

PROPOSED DENIAL OF ACCESS

PROPOSED RIGHT-OF-WAY

PROPOSED RIGHT-OF-WAY MONUMENT

PROPOSED RIGHT-OF-WAY BASELINE

GENERAL NOTES

- THIS PROJECT IS TO BE CONSTRUCTED IN ACCORDANCE WITH THE DELAWARE DEPARTMENT OF TRANSPORTATION "STANDARD SPECIFICATIONS", DATED AUGUST 2016 AND THE DELAWARE DEPARTMENT OF TRANSPORTATION "STANDARD CONSTRUCTION DETAILS", DATED 2018, INCLUDING ALL REVISIONS UP TO THE DATE OF ADVERTISEMENT.
- 2. ELECTRONIC PROJECT FILES THAT WILL BE MADE AVAILABLE TO THE AWARDED CONTRACTOR, INCLUDE:

()	NONE
()	ASCII DATA FILES WITH COORDINATES AND ELEVATIONS FOR PROPOSED POINTS AS SELECTED BY THE ENGINEER.
(X)	ALL PLAN SHEETS, IN PDF FORMAT.
()	EXISTING DIGITAL TERRAIN MODEL, IN .DTM FILE FORMAT, COMPATIBLE WITH SOFTWARE CURRENTLY USED BY DELDOT.
()	PROPOSED DIGITAL TERRAIN MODEL, IN .DTM FILE FORMAT, COMPATIBLE WITH SOFTWARE CURRENTLY USED BY DELDOT.
()	DESIGN FILE, IN .DGN FILE FORMAT, CONTAINING ONLY THE PROPOSED 3D TRIANGLES OF THE PROPOSED DIGITAL TERRAIN MODEL (DTM).

NOTE: THE DOCUMENT ENTITLED "RELEASE FOR DELIVERY OF DOCUMENTS IN ELECTRONIC FORM TO A CONTRACTOR" MUST BE SIGNED BY ALL PARTIES PRIOR TO THE DELIVERY OF ANY ELECTRONIC PROJECT FILES.

3. PROJECT FILES THAT WILL BE MADE AVAILABLE TO THE CONTRACTOR, INCLUDE:

(X)	CROSS SECTIONS (WILL BE MADE AVAILABLE TO THE AWARDED CONTRACTOR)
(X)	RIGHT-OF-WAY PLANS (INCLUDED IN PLAN SET)

PROJECT NOTES

SECTION 100

- ANY DAMAGE TO ITEMS NOTED TO BE RELOCATED OR RESET BY THE CONTRACTOR, SHALL BE REPAIRED OR REPLACED IN KIND AT THE CONTRACTOR'S EXPENSE, AT THE DISCRETION OF THE ENGINEER.
- 2. THE CONTRACTOR WILL CONTACT THE DELAWARE TMC AT 302-659-4600 PRIOR TO ANY UNMANNED AERIAL VEHICLE (UAV) FLIGHTS. THE CONTRACTOR WILL BE REQUIRED TO PROVIDE THE FOLLOWING INFORMATION: THE REGISTRATION NUMBER OF THE UAV, THE FLIGHT TIME, LOCATION OF THE FLIGHT, THE PILOT'S NAME AND THE PILOT'S CONTACT NUMBER DURING THE FLIGHT.

SECTION 200

- ITEMS TO BE REMOVED UNDER ITEM #211000 REMOVAL OF STRUCTURES AND OBSTRUCTIONS SHALL INCLUDE, BUT NOT BE LIMITED TO THE FOLLOWING:
 - EXISTING BARRIER INCLUDING BOTH CONCRETE AND METAL RAIL SECTIONS
 - EXISTING SIDEWALK ACROSS BRIDGE
 - EXISTING PRESTRESSED BEAMS - EXISTING BEARING PADS
 - EXISTING APPROACH SLABS

 - REMOVE AND RE-SET FENCE ON PARCEL 2-R WHERE IT INTERFERES WITH PROPOSED CONSTRUCTION. IF DAMAGED DURING
 - REMOVAL AND STORAGE, REPLACE FENCE IN-KIND.
 - EXISTING WATER LINE BETWEEN VALVES AT APPROXIMATELY STA. 2+52 AND STA. 3+68

SECTION 600

- 4. PORTLAND CEMENT CONCRETE:
 - USE PORTLAND CEMENT CONCRETE FOR CAST-IN-PLACE ELEMENTS AS FOLLOWS:
 - (f'c = 28-DAY COMPRESSIVE STRENGTH)
 - CLASS A ITEM #610008 P.C.C. MASONRY, PARAPET, CLASS A, (f'c = 4.5 ksi) (BARRIER) CLASS D - ITEM #610016 - P.C.C. MASONRY, CLASS D, (f'c = 4.5 ksi) (SIDEWALK & BACKWALL)
 - CHAMFER ALL EXPOSED EDGES $\frac{3}{4}$ " X $\frac{3}{4}$ " UNLESS OTHERWISE NOTED.
 - DO NOT SLIP-FORM BARRIERS, UNLESS OTHERWISE APPROVED BY THE DEPARTMENT.

SUPPLY THE CONCRETE FOR THE INTEGRATED APPROACH AND PARAPETS THAT INCLUDES A SHRINKAGE-REDUCING/COMPENSATING ADMIXTURE. THE ADMIXTURE MAY BE SUPPLIED BY ONE PRODUCT THAT PROVIDES BOTH EXPANSION AND PORE WATER SURFACE TENSION OR TWO SEPARATE PRODUCTS EACH ADDED AT DOSAGE RECOMMENDED BY MANUFACTURER'S TECHNICAL DATA SHEETS AND HAVING THE FOLLOWING CHARACTERISTICS:

- (a.) DESIGNED TO PROVIDE BOTH OF THE FOLLOWING CHARACTERISTICS:
- (i.) EXPANDS AT A RATE THAT CLOSELY COMPENSATES FOR THE SHRINKAGE OF THE CONCRETE MIX.
- (ii.) REDUCES THE CAPILLARY SURFACE TENSION OF THE CONCRETE PORE WATER.
- (b.) PROVIDES AT LEAST 80% SHRINKAGE REDUCTION AS MEASURED AND DOCUMENTED BY FIELD PERFORMANCE.
- (c.) FORMULATED FOR USE IN FREEZING AND THAWING WEATHER.

ALL ADMIXTURES MUST BE COMPATIBLE WITH ALL OTHER CONCRETE-MIX DESIGN CONSTITUENTS. CALCIUM CHLORIDE IS NOT PERMITTED; NO CHEMICAL ADMIXTURES WHICH CONTAIN MORE THAN 0.1% CHLORIDE BY WEIGHT, WILL BE PERMITTED FOR USE. DOSAGE RATE AND MIXING SEQUENCE WILL BE IN ACCORDANCE WITH THE MANUFACTURER'S RECOMMENDATIONS.

USE PORTLAND CEMENT CONCRETE FOR PRECAST ELEMENTS AS FOLLOWS:

- (f'c = 28-DAY COMPRESSIVE STRENGTH)
- (f'ci = COMPRESSIVE STRENGTH AT INITIAL PRESTRESS) PRESTRESSED:
- ITEM #612021 PRESTRESSED ERINFORCED CONCRETE MEMBERS, VOIDED SLABS f'c = 8 ksi; f'ci = 6 ksi
- DESIGN ASSUMPTIONS: THE PRESTRESSED CONCRETE BEAMS WERE DESIGNED FOR SEVERE CORROSIVE CONDITIONS. - CHAMFER ALL EXPOSED EDGES ¾" X ¾" UNLESS OTHERWISE NOTED.

- BAR REINFORCEMENT:
- REINFORCING STEEL SHALL CONFORM TO AASHTO M31 (ASTM A615), GRADE 60.
- REINFORCING STEEL SHALL HAVE A 3" CLEAR COVER IF CAST AGAINST EARTH OR A 2" CLEAR COVER ELSEWHERE, UNLESS OTHERWISE SPECIFIED ON THE PLANS.
- ALL REINFORCING STEEL SHALL BE PROTECTED WITH FUSION BONDED EPOXY. EPOXY COATED REINFORCING STEEL SHALL CONFORM TO ASTM A775.
- ANY FIELD CUTTING OR FIELD BENDING MUST BE APPROVED BY THE ENGINEER. PAYMENT SHALL BE INCIDENTAL TO THE BAR REINFORCEMENT ITEM.
- GALVANIZED REINFORCING STEEL MAY BE SUBSTITUTED FOR EPOXY-COATED REINFORCING STEEL AT NO ADDITIONAL COST TO DELDOT WITH APPROVAL OF THE BRIDGE DESIGN ENGINEER.
- WELDING OF REINFORCEMENT DURING FABRICATION OR CONSTRUCTION IS NOT PERMITTED UNLESS SPECIFIED.
- CONCRETE SEALER:
 - REFER TO ABUTMENT, WINGWALL, AND CHEEKWALL DETAILS FOR CONCRETE SEALER LIMITS ON SHEET 11 ABUTMENT DETAILS. PAYMENT UNDER ITEM #613000 - EPOXY CONCRTE SEALER.
 - REFER TO PILE BENT DETAILS DETAILS FOR CONCRETE SEALER LIMITS ON SHEET 12 PILE BENT DETAILS. PAYMENT UNDER ITEM #613000 - EPOXY CONCRTE SEALER.
 - REFER TO PARAPET SECTION DETAILS FOR CONCRETE SEALER LIMITS ON SHEET 18 BRIDGE PARAPET DETAILS. PAYMENT UNDER ITEM #613001 - SILICONE BASED CONCRETE SEALER.

SECTION 700

- SIDEWALK SAWCUTTING:
- WHERE PROPOSED CONCRETE SIDEWALK IS CONSTRUCTED TO MEET EXISTING SIDEWALK, THE EXISTING SIDEWALK SHALL BE SAWCUT AT THE TIE-IN POINT OR MEET THE NEAREST EXISTING SIDEWALK JOINT. ALL SAW CUTTING SHALL BE FULL DEPTH, UNLESS OTHERWISE NOTED ON THE PLANS OR DIRECTED BY THE ENGINEER AND SHALL BE PAID FOR UNDER ITEM #762001 SAWCUTTING, CONCRETE, FULL DEPTH.
- PAVEMENT SAWCUTTING:
- ALL PAVED AREAS TO BE RECONSTRUCTED OR WIDENED SHALL BE SAW CUT AT THE POINT WHERE THE NEW PAVEMENT IS TO TIE INTO THE EXISTING PAVEMENT. SEE CONSTRUCTION PLAN SHEET FOR FURTHER DETAIL AND LOCATIONS OF SAW CUTTING. TO BE PAID FOR UNDER ITEM #762000 - SAW CUTTING, BITUMINOUS CONCRETE AND ITEM #762001 - SAW CUTTING, CONCRETE FULL DEPTH.

SECTION 800

MAINTENANCE OF VEHICULAR AND PEDESTRIAN TRAFFIC: MAINTENANCE OF VEHICULAR AND PEDESTRIAN TRAFFIC SHALL BE AS PER THE VEHICULAR AND PEDESTRIAN DETOUR PLANS. THE DETOURS SHALL REMAIN IN EFFECT UNTIL THE FINAL WARM MIX PAVEMENT IS PLACED. ALL MOT ITEMS WITH THE EXCEPTION OF CHANGEABLE MESSAGE BOARDS (ITEM #803001) AND FLAGGERS (ITEM #811009 AND #811018) WILL BE INCLUDED IN ITEM #801500 - MAINTENANCE OF TRAFFIC. ALL INCLUSIVE.

SECTION 900


10. THIS PROJECT IS COVERED UNDER AN NPDES GENERAL PERMIT FOR CONSTRUCTION. UNDER THE GENERAL PERMIT, COMPLIANCE WITH DELDOT'S APPROVED SEDIMENT AND STORMWATER MANAGEMENT PLANS WILL CONSTITUTE COMPLIANCE WITH THE NPDES INDUSTRIAL PERMITTING REQUIREMENTS FOR THIS CONSTRUCTION PROJECT. A COPY OF THE NPDES GENERAL PERMIT AND NOI IS KEPT ON FILE IN EACH OF THE CONSTRUCTION OFFICES AND THE DEPARTMENT'S STORMWATER SECTION. A COPY OF THE GENERAL PERMIT OR THE NOI CAN BE OBTAINED UPON REQUEST FROM EITHER THE DEPARTMENT'S STORMWATER ENGINEER OR THE APPROPRIATE CONSTRUCTION ENGINEER.

MISCELLANEOUS


- DESIGN SPECIFICATIONS: 2017 DELDOT BRIDGE DESIGN MANUAL. 2014 AASHTO LRFD BRIDGE DESIGN SPECIFICATIONS, 7TH EDITION WITH 2015 & 2016 INTERIM REVISIONS. U.S. CUSTOMARY UNITS.
- LIVE LOAD: AASHTO HL-93 DEAD LOAD: INCLUDES 25 PSF FOR FUTURE WEARING SURFACE.
- 13. EXISTING CONDITIONS:
 - ALL EXISTING DIMENSIONS AND ELEVATIONS SHOWN ARE BASED ON THE BEST AVAILABLE INFORMATION AND ARE APPROXIMATE ONLY. THE CONTRACTOR SHALL FIELD VERIFY ALL EXISTING DIMENSIONS, GEOMETRY, AND ELEVATIONS AS NECESSARY PRIOR TO ORDERING ANY MATERIALS AND COMMENCING CONSTRUCTION TO ENSURE PROPER FIT OF THE PROPOSED CONSTRUCTION. PAYMENT SHALL BE INCIDENTAL TO ITEM #763501 - CONSTRUCTION ENGINEERING.
 - THE CONTRACTOR SHALL NOT CONSIDER ANY OF THE DATA ON THE EXISTING STRUCTURE SUPPLIED IN THE ORIGINAL DESIGN DRAWINGS OR MADE AVAILABLE BY THE DEPARTMENT OR ITS AUTHORIZED AGENTS AS POSITIVE REPRESENTATIONS OF ANY OF THE CONDITIONS THAT WILL BE ENCOUNTERED IN THE FIELD.
 - AS-BUILT PLANS OF THE EXISTING STRUCTURE ARE AVAILABLE AND MAY BE OBTAINED THROUGH THE DEPARTMENT AT NO ADDITIONAL COST. THE FOLLOWING LIST REPRESENTA CONTRACTS RELATED TO EXISTING BR 3-162. THE LIST INCLUDES CONTRACT NUMBER, APPROXIMATE DATE OF CONSTRUCTION, AND A DESCRIPTION OF THE PRIMARY SCOPE OF WORK. - CONTRACT NO.: 64-01-015, 1966, ORIGINAL BRIDGE CONSTRUCTION
- 14. THE CONTRACTOR SHALL NOTIFY DART FIRST STATE AT DOT DETOURS@DELAWARE.GOV AT LEAST 14 DAYS PRIOR TO THE START OF ANY DETOURS OR CONSTRUCTION, AND DOT DTC PROJECTDEVELOPMENT@DELAWARE.GOV AT SUCH TIME THE FACILITY IS COMPLETED AND OPERABLE FOR TRANSIT OPERATIONS. FOR EMERGENCY DETOUR INFORMATION ONLY, PLEASE CONTACT DTC'S CHIEF SCHEDULER AT 302-576-6019.
- 15. THE CONTRACTOR WILL MAINTAIN ACCESS TO DRIVEWAYS THROUGHOUT THE DURATION OF THE PROJECT. APPROXIMATE LOCATIONS OF DRIVEWAYS ARE LEFT STA. 5+00 AND RIGHT STA. 5+25. THE CONTRACTOR WILL NOTIFY THE PROPERTY OWNERS OF WORK TEMPORARILY LIMITING ACCESS AT LEAST A WEEK PRIOR TO THE WORK BEGINNING. PEDESTRIAN ACCESS TO PROPERTIES WILL BE MAINTAINED UNIMPEDED THROUGHOUT THE DURATION OF THE PROJECT.
- 16. THE CONTRACTOR WILL VERIFY LOCATION OF UNDERGROUND ELECTRIC AND SPRINKLER SYSTEM ASSOCIATED WITH PARCEL 1-L. ANY DAMAGE TO UNDERGROUND UTILITIES AS A RESULT OF CONTRACTOR ACTIVITIES WILL BE REPAIRED AT THE EXPENSE OF THE CONTRACTOR.
- BRIDGE SAFETY FENCE:
- ALL POSTS, BRACES, FITTINGS, CHAIN LINK FENCING, AND HARDWARE SHALL BE PVC COATED. NUTS, BOLTS, AND WASHERS SHALL ALSO BE PVC COATED AND TOUCHED UP AFTER INSTALLATION. PRECOATED LONGITUDINAL RAILS, IF CUT, SHALL HAVE THE CUT END COATED WITH PVC TOUCH UP MATERIAL SUPPLIED BY THE MANUFACTURER PRIOR TO ERECTION. PVC COLOR FOR ALL ELEMENTS OF FENCE SHALL BE BLACK UNLESS OTHERWISE NOTED. PAYMENT FOR PVC COATING SHALL BE INCIDENTAL TO ITEM #727007 - BRIDGE SAFETY FENCE, TYPE 1.
- OVERNIGHT WORK HOURS ARE PROHIBITED FROM 8:00PM 6:00AM UNLESS A NIGHT WORK WAIVER IS APPROVED BY THE DEPARTMENT.

LOAD RATING SUMMARY						
DESIGN VEHICLE	RATING FACTOR	RATING WEIGHT (TON)	CONTROLLING MEMBER	CONTROLLING POINT	LOAD EFFECT	
HL-93 TRUCK (INVENTORY)	1.93	69.59	INTERNAL GIRDER G2	106	STR. I - L. REINF.	
HL-93 TANDEM (INVENTORY)	1.93	48.33	INTERNAL GIRDER G2	105	STR. I - L. REINF.	
HL-93 TRUCK TRAIN (INVENTORY)	N/A	N/A	N/A	N/A	N/A	
HS-20 (INVENTORY)	2.29	82.50	INTERNAL GIRDER G2	106	STR. I - L. REINF.	
HL-93 TRUCK (OPERATING)	2.49	89.58	INTERNAL GIRDER G2	106	STR. I - L. REINF.	
HL-93 TANDEM (OPERATING)	2.49	62.21	INTERNAL GIRDER G2	105	STR. I - L. REINF.	
HL-93 TRUCK TRAIN (OPERATING)	N/A	N/A	N/A	N/A	XXXXXXX	
HS-20 (OPERATING)	2.96	106.39	INTERNAL GIRDER G2	106	STR. I - L. REINF.	
DE S220 & LEGAL-LANE (LEGAL)	3.72	74.45	INTERNAL GIRDER G2	105	SER. III - STRESS	
DE S335 & LEGAL-LANE (LEGAL)	2.00	70.11	INTERNAL GIRDER G2	105	SER. III - STRESS	
DE S437 & LEGAL-LANE (LEGAL)	1.90	69.48	INTERNAL GIRDER G2	105	SER. III - STRESS	
DE T330 & LEGAL-LANE (LEGAL)	3.60	107.86	INTERNAL GIRDER G2	105	SER. III - STRESS	
DE T435 & LEGAL-LANE (LEGAL)	2.92	102.07	INTERNAL GIRDER G2	105	SER. III - STRESS	
DE T540 & LEGAL-LANE (LEGAL)	2.65	106.09	INTERNAL GIRDER G2	105	SER. III - STRESS	
NOTE: LOAD RATING INCLUDES FUTURE WEARING SURFACE AS NOTED IN THE PLANS.						

ADDENDA / REVISIONS CONTRACT 3-162 BRIDGE NO. BR 3-162 ON T201607602 **S466 DELAWARE AVE** NOT TO SCALE **NOTES** DESIGNED BY: S. WEAVER COUNTY SHEET NO. **OVER BROAD CREEK** CHECKED BY: S. WALLS SUSSEX

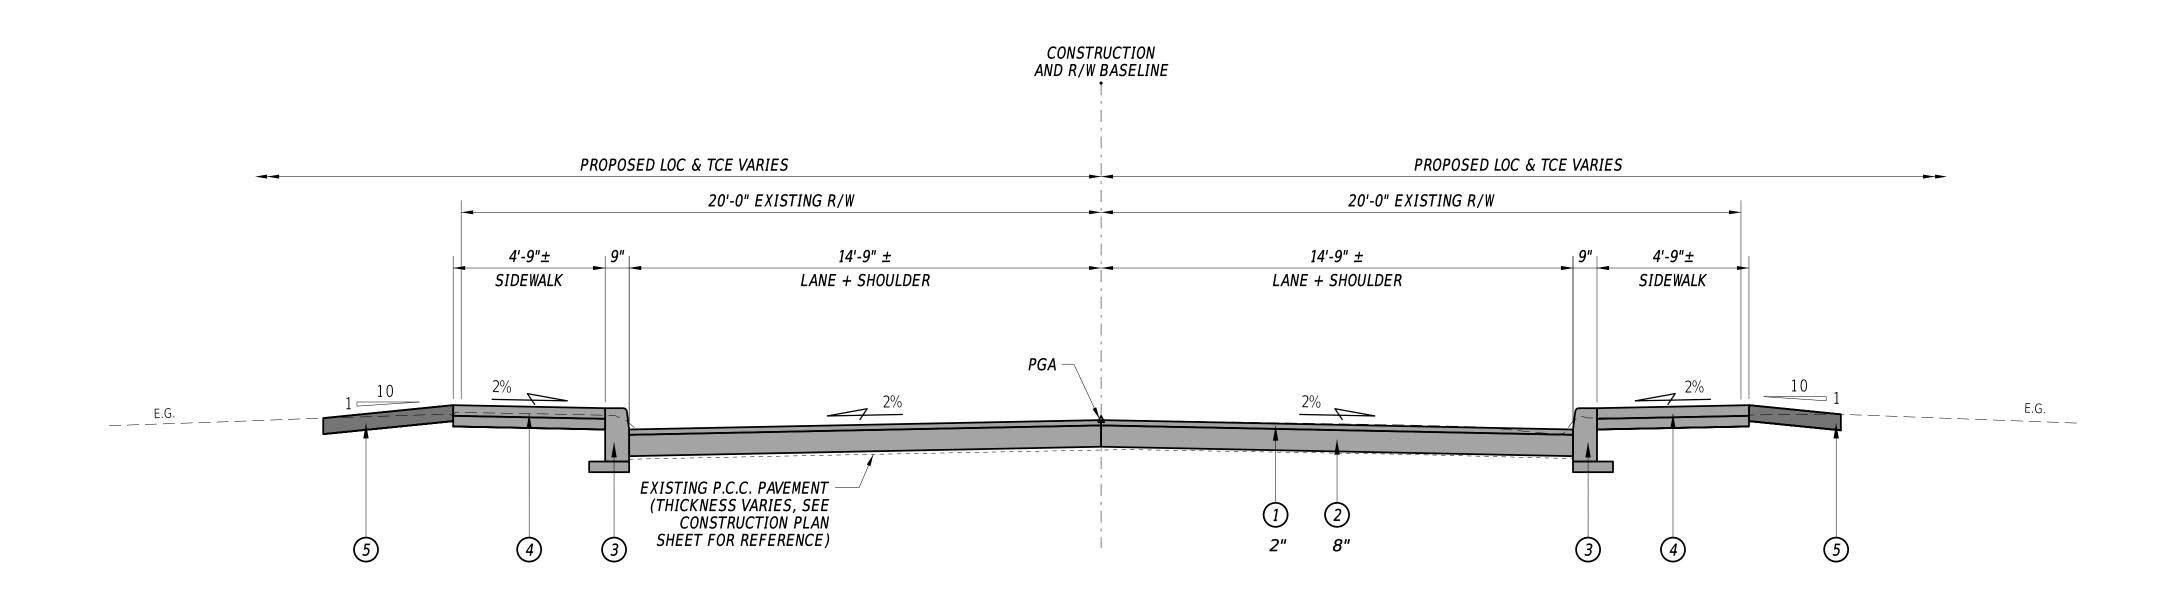

TYPICAL ROADWAY SECTION

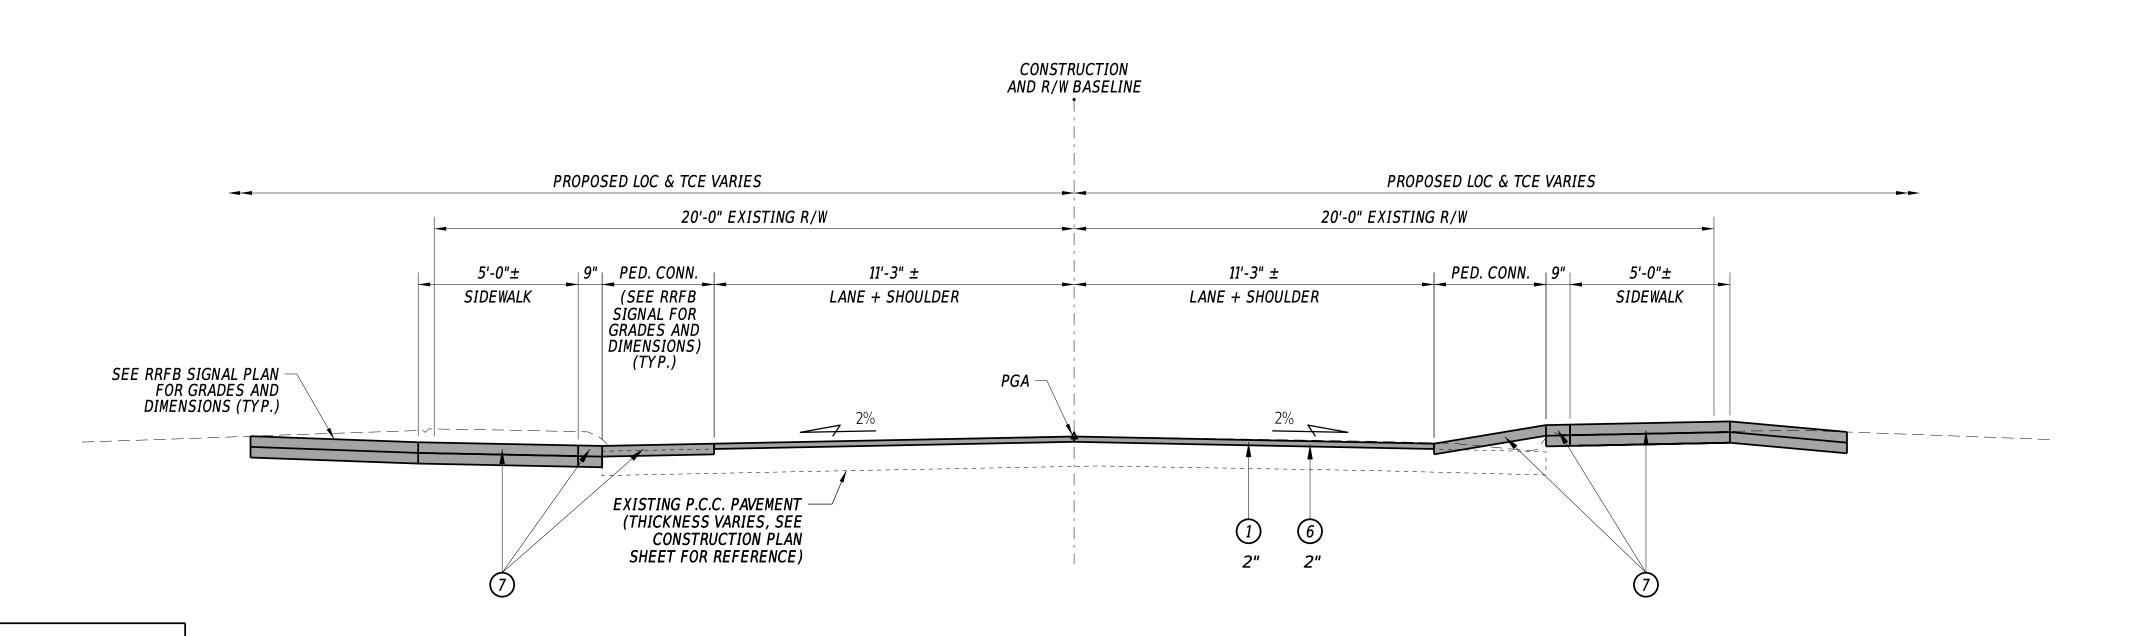

LEGEND

- 1 ITEM #401005 SUPERPAVE, TYPE C, PG 64-22 (CARBONATE STONE)
- 2 ITEM #501001 PORTLAND CEMENT CONCRETE PAVEMENT, 8"
- ③ ITEM #701013 P.C.C. CURB, TYPE 1-8 AND
- 4" GRADED AGGREGATE BASE COURSE, TYPE B

 ITEM #705001 P.C.C. SIDEWALK, 4" AND
- 4" GRADED AGGREGATE BASE COURSE, TYPE B

 5 ITEM #908004 TOPSOIL, 6" DEPTH
 - ITEM #908019 PERMANENT GRASS SEEDING, STREAMBANK
- ITEM #908020 EROSION CONTROL BLANKET MULCH
- 6 ITEM #760010 PAVEMENT MILLING, BITUMINOUS CONCRETE PAVEMENT
- 7) ITEM #705009 PEDESTRIAN CONNECTION, TYPE 2, 3, AND/OR 4

TYPICAL PEDESTRIAN CROSSING AND MILL AND OVERLAY SECTION

MATERIAL	LIFT THICKNESS		
	MINIMUM	MAXIMUM	
SUPERPAVE, TYPE 'C'	1.25"	2"	
SUPERPAVE, TYPE 'B'	2.25"	4"	
SUPERPAVE BCBC	3"	6"	
GRADED AGGREGATE BASE COURSE	-	8"	

ADDENDA / REVISIONS


NOT TO SCALE

BR 3-162 ON
S466 DELAWARE AVE
OVER BROAD CREEK

CONTRACT
T201607602
DESIGNED BY: S. WEAVER
TYPICAL SECTION
SHEET NO.
6

SHORT NO.
6

SHORT NO.
6

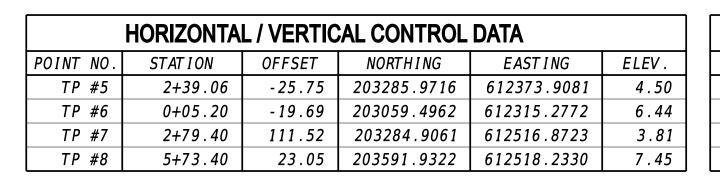


ROADWAY CORE SCHEDULE								
NO. STATION OFFSET DESCRIPTION								
C - 1	4+55.44	6.00	11" HMA, 8.5" PCC					
C-2	2+43.30	6.50	3" HMA, 8" PCC					
C-3	2+55.97	-5.50	5" HMA, 12" PCC					
C - 4	3+73.59	-5.50	2" HMA, 6.5" PCC					
	·							

CONSTRUCTION ALIGNMENT CONTROL OFFSET NORTHING STATION 203049.07 612332.77 0+00.00 0.00 203291.99 612402.42 2+52.71 0.00 10002 6+00.00 0.00 203624.11 612503.96

DATUM REFERENCE:

HORIZONTAL - THIS PROJECT IS REFERENCED TO THE DELAWARE STATE PLANE COORDINATE SYSTEM, NORTH AMERICAN DATUM OF 1983 (NAD 83 / 2011 / EPOCH 2010.00).

CURB SCHEDULE ITEM DESCRIPTION / TYPE LENGTH P.C.C. CURB, TYPE 1-8 50.00

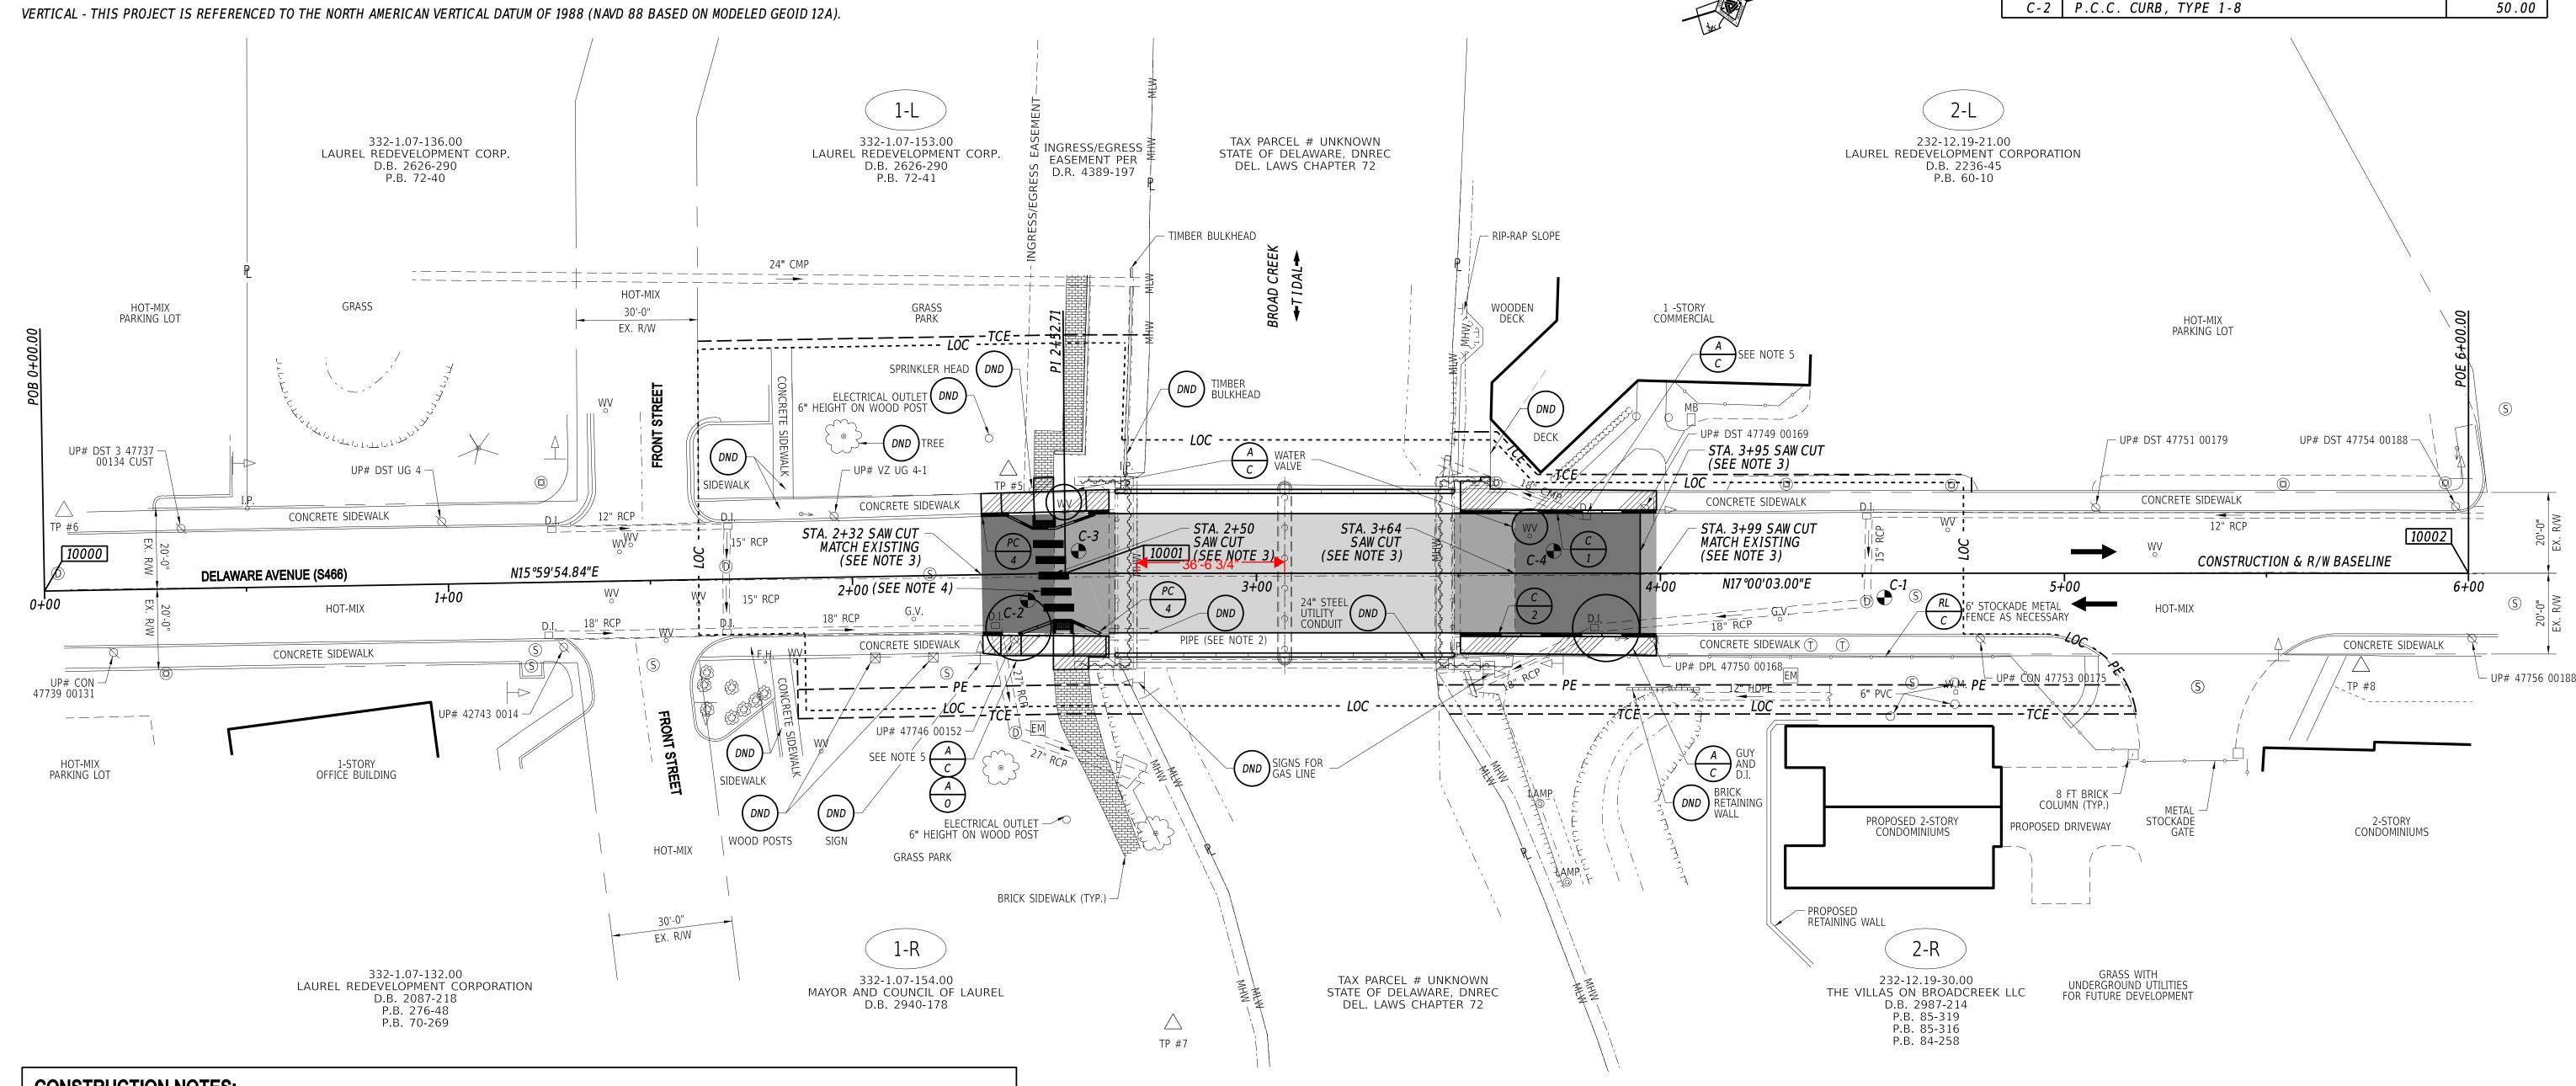

CONSTRUCTION NOTES:

- TRANSITION PROPOSED CURB FROM TYPE 1-8 ON BRIDGE TO EXISTING CURB HEIGHT OVER 10 FT LENGTH
- SIZE AND LOCATION OF PIPE THROUGH SOUTH ABUTMENT IS APPROXIMATELY 24" WITH LID PROTRUDING THROUGH SHEET PILE BELOW ABUTMENT AND IS SHOWN FOR REFERENCE ONLY. TO BE VERIFIED BY CONTRACTOR.
- SAW CUT FULL DEPTH OF HOT-MIX PAVEMENT AT STA. 2+32, 2+50, 3+64, 3+95, AND 3+99 PAID UNDER ITEM #762000 SAW CUTTING, BITUMINOUS CONCRETE. CONCRETE ROAD BOX SHALL REMAIN IN PLACE AND WILL NOT BE CUT AT STA. 2+32. CONCRETE ROAD BOX WILL BE SAW CUT FULL DEPTH AT STA. 2+50, 3+64, 3+95, AND 3+99 PAID UNDER ITEM #762001 - SAW CUTTING, CONCRETE FULL DEPTH. CONCRETE PAVEMENT BETWEEN STA. 3+95 AND 3+99 TO BE REMOVED TO ACCOMMODATE UTILITY RELOCATION, SEE CONSTRUCTION SEQUENCE SHEET AND UTILITY RELOCATION PLAN SHEET FOR FURTHER INFORMATION. APPROACH SLAB SHALL BE REMOVED INCIDENTAL TO ITEM #211000 - REMOVAL OF STRUCTURES AND OBSTRUCTIONS. REMOVAL OF CONCRETE PAVEMENT BETWEEN STA. 3+95 AND 3+99 SHALL BE PAID UNDER ITEM #211001 - REMOVAL OF PORTLAND CEMENT CONCRETE PAVEMENT, CURB AND SIDEWALK
- PERMANENT PAVEMENT STRIPING NOT SHOWN CONTINUOUSLY IN CROSS WALK FOR CLARITY. REFER TO THE RECTANGULAR RAPID FLASHING BEACON (RRFB)
 SIGNAL PLAN DELAWARE AVENUE (ROAD 466) @ EAST FRONT STREET SHEET FOR FURTHER INFORMATION REGARDING THE PERMANENT PAVEMENT STRIPING,
 RRFB INSTALLATION, PEDESTRIAN CONNECTIONS AND ASSOCIATED CROSSWALK DETAILS. CONDUIT AND ELECTRICAL WORK REQUIRED FOR THE RRFB WILL NOT BE INSTALLED UNDER THE INTEGRATED APPROACH.
- DRAINAGE INLET TO BE ADJUST BY CONTRACTOR AS NEEDED TO CONSTRUCT SIDEWALK, CURB, PEDESTRIAN CONNECTION, AND PAVEMENT, TO BE VERIFIED BY FIELD ENGINEER, PAID UNDER ITEM #602130 - ADJUSTING AND REPAIRING EXISTING DRAINAGE INLET. DRAINAGE INLET GRATES TO BE REPLACED WITH TYPE 1 DRAINAGE INLET GRATES PAID UNDER ITEM #602100 - REPLACE DRAINAGE INLET GRATE(S). GUY TO BE ADJUSTED BY OTHERS AS NEEDED TO COMPLETE WORK ASSOCIATED WITH UTILITY RELOCATION.


ADDENDA / REVISIONS					
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			FEET		


BR 3-162 ON	
S466 DELAWARE AVE	
OVER BROAD CREEK	


CONTRACT	BRIDGE NO.	3-162	
T201607602	DECICNED BY	C WEAVED	
COUNTY	DESIGNED BY:	S. WEAVER	
SUSSEX	CHECKED BY:	S. WALLS	

CONSTRUCTION PLAN


SHEET NO.

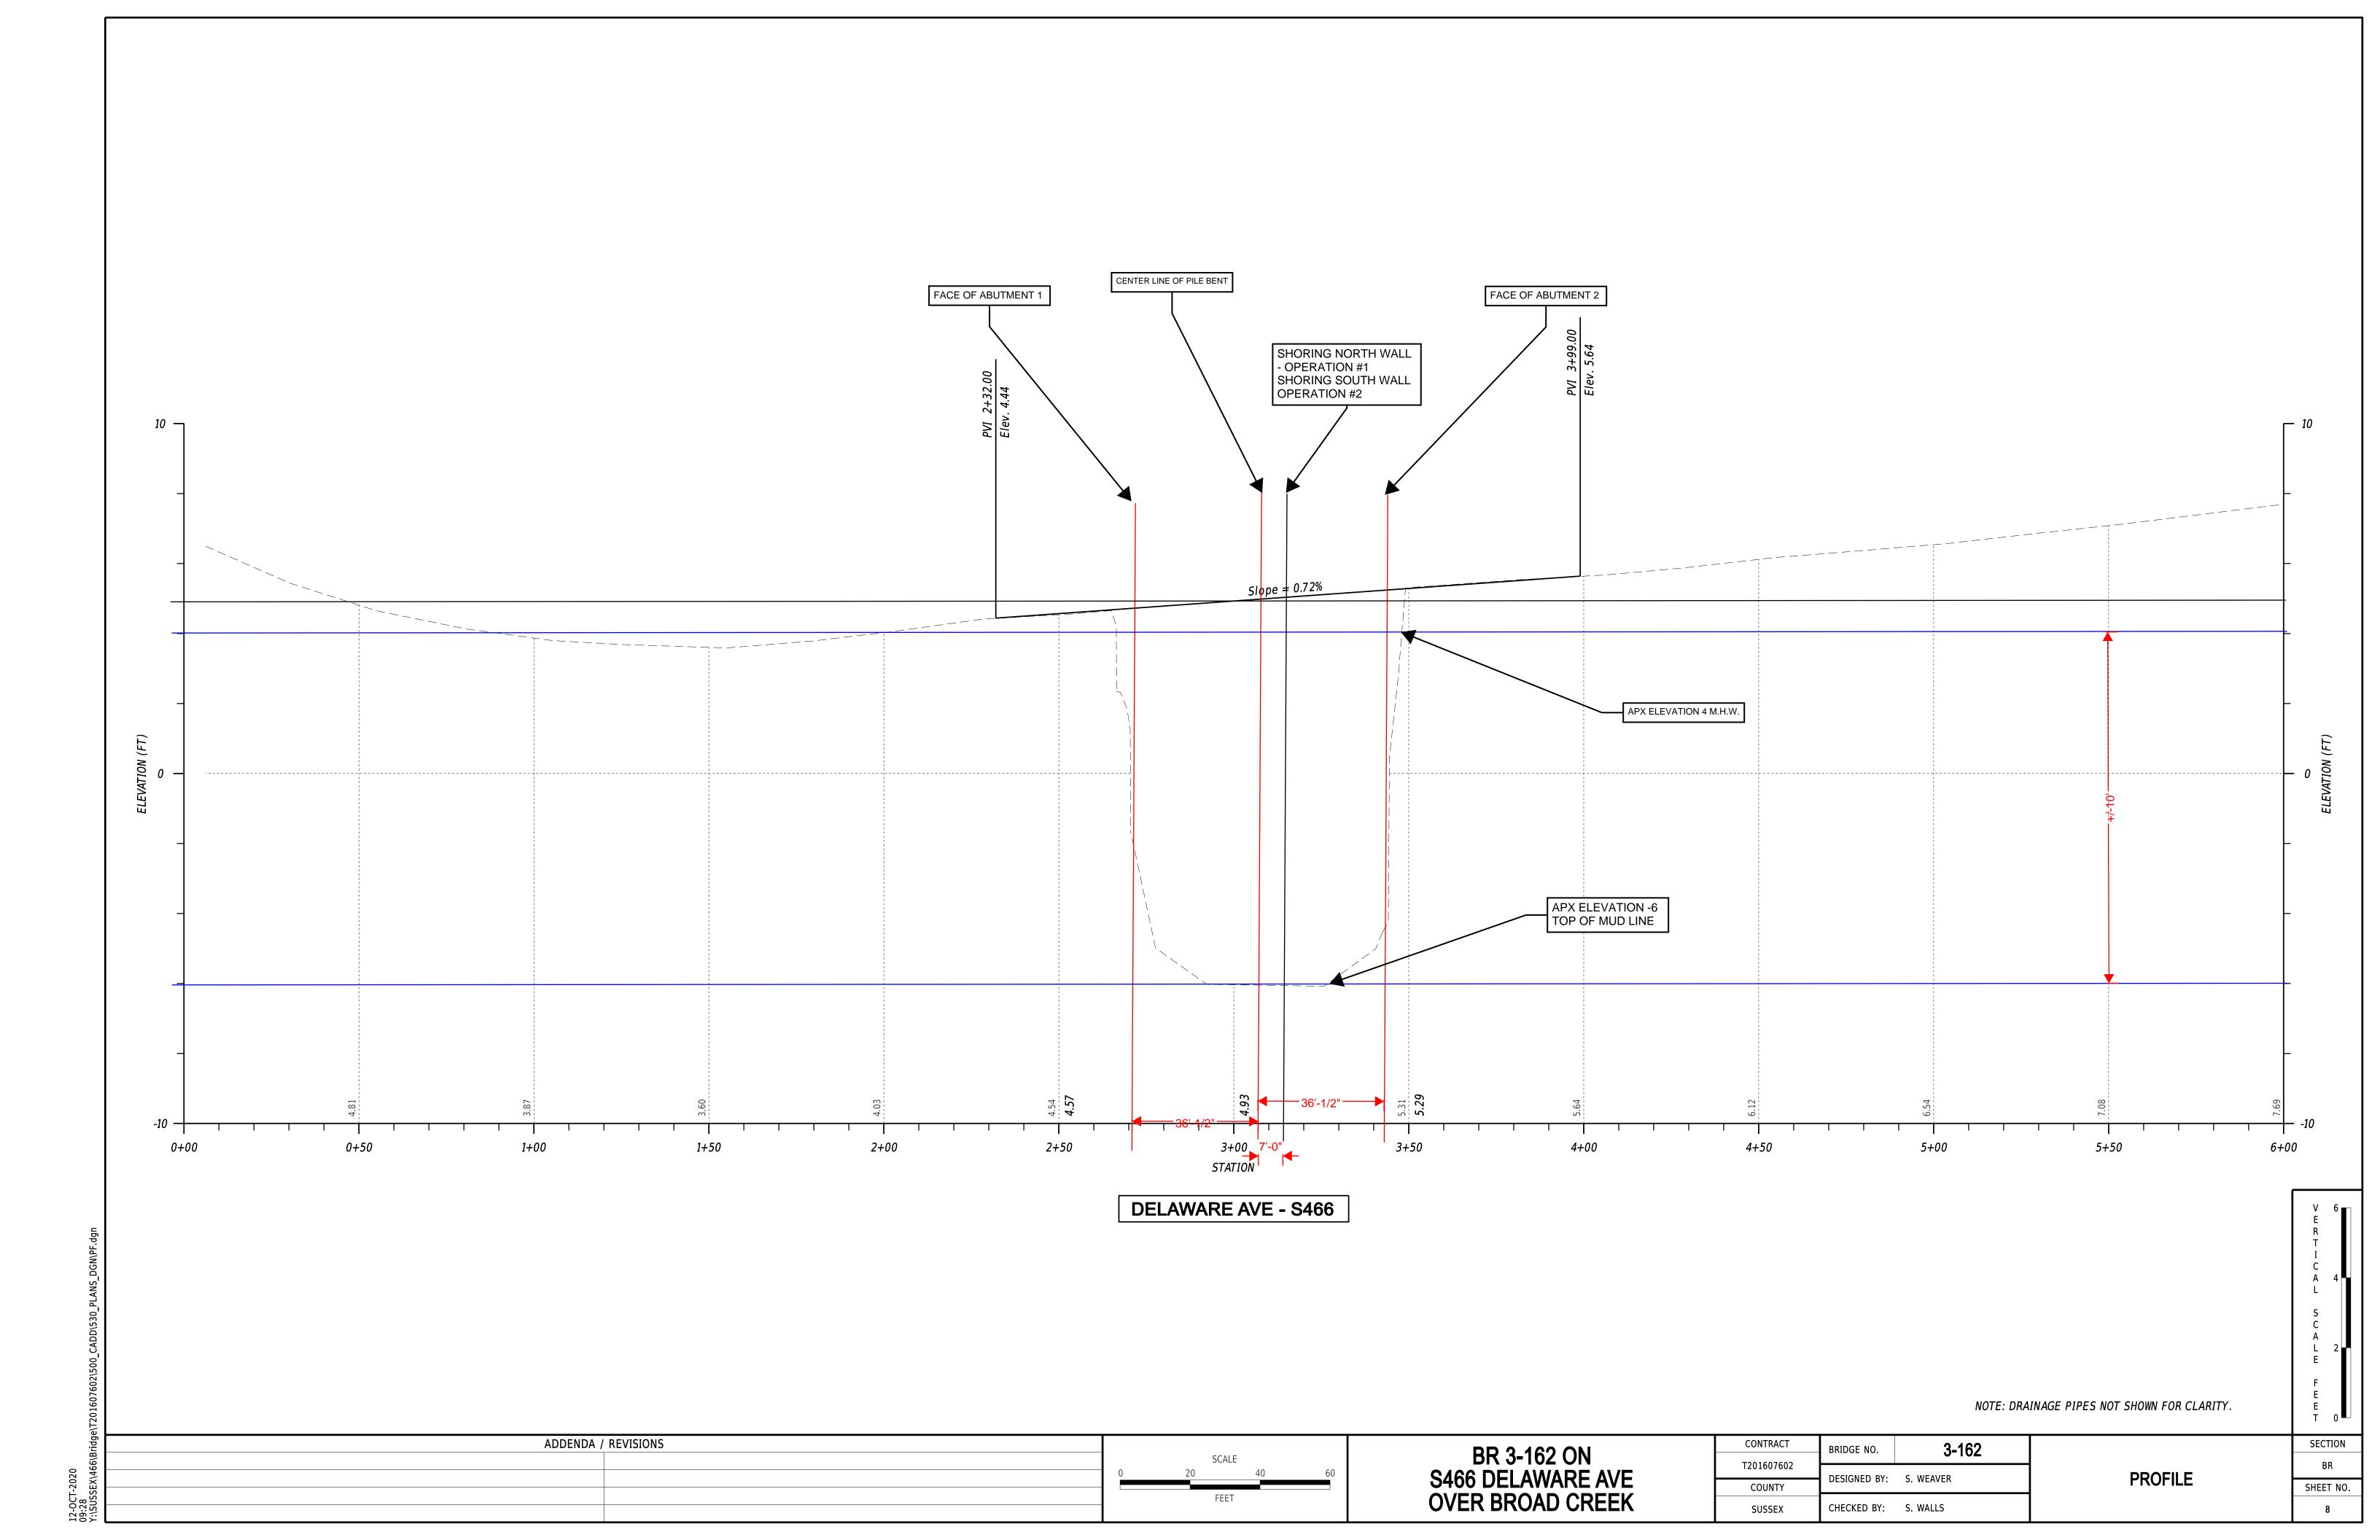

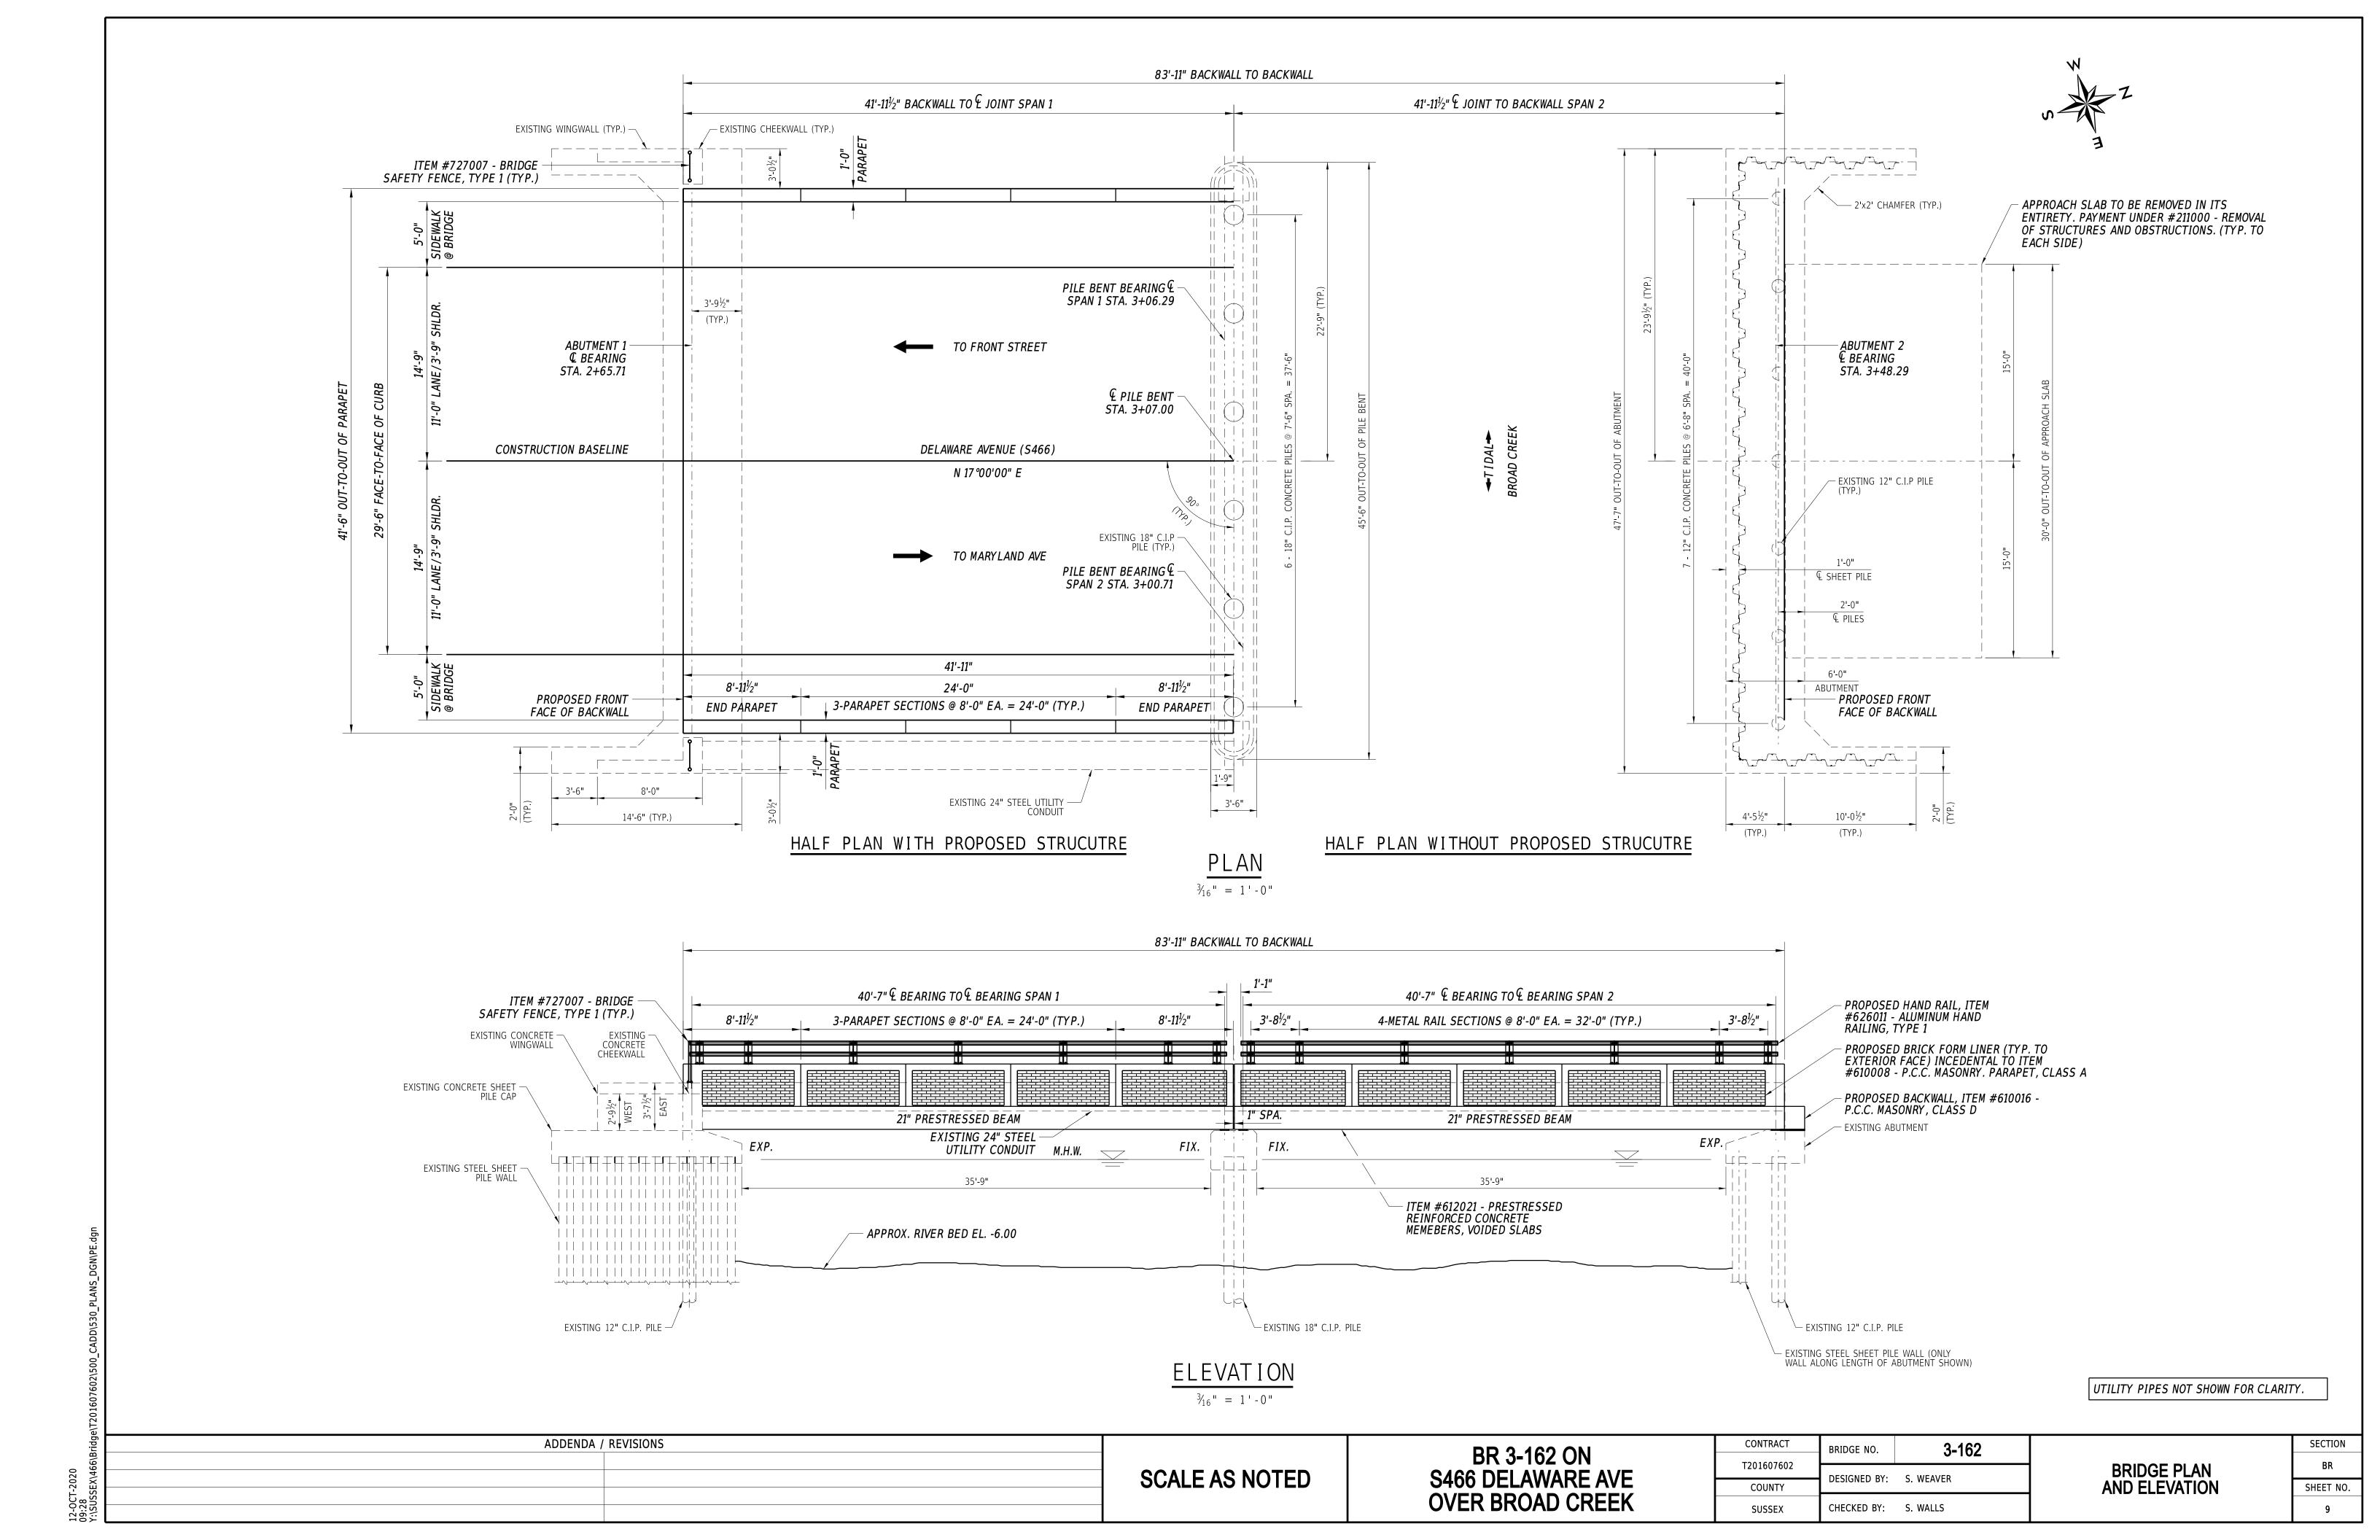

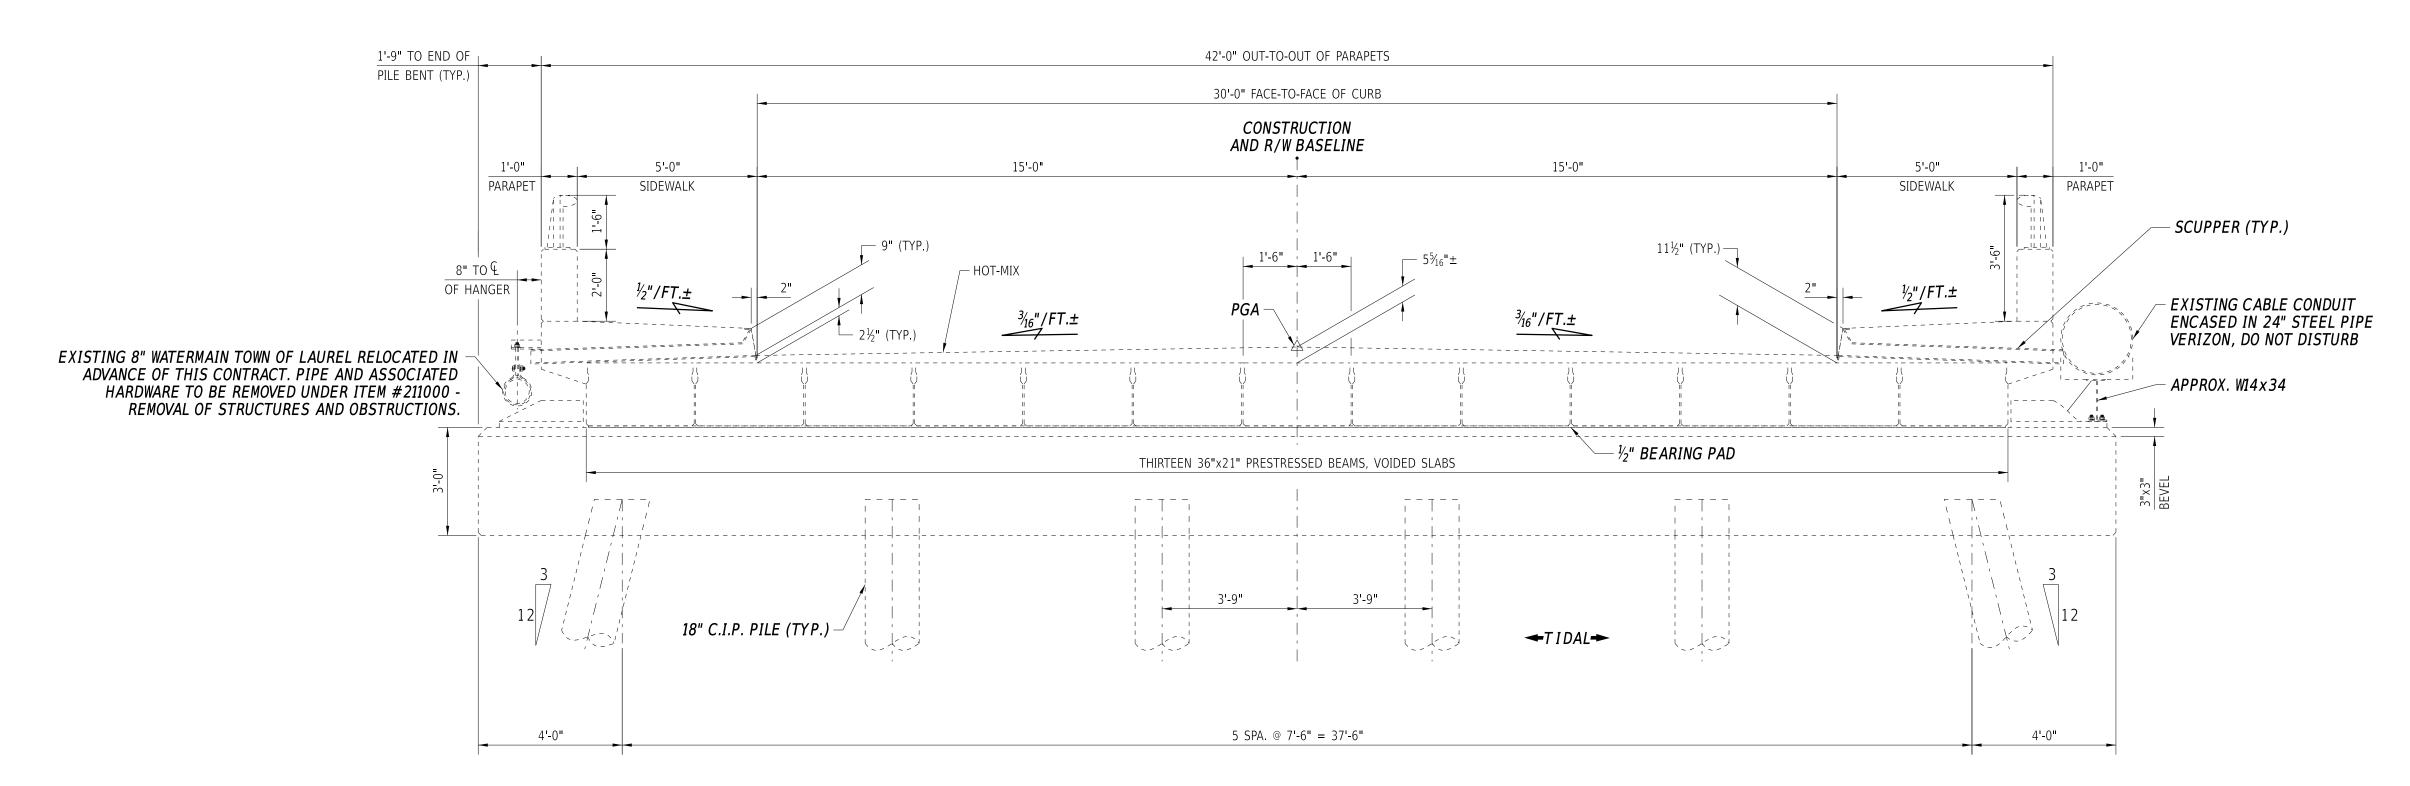

EXISTING TYPICAL SECTION AT PILE BENT

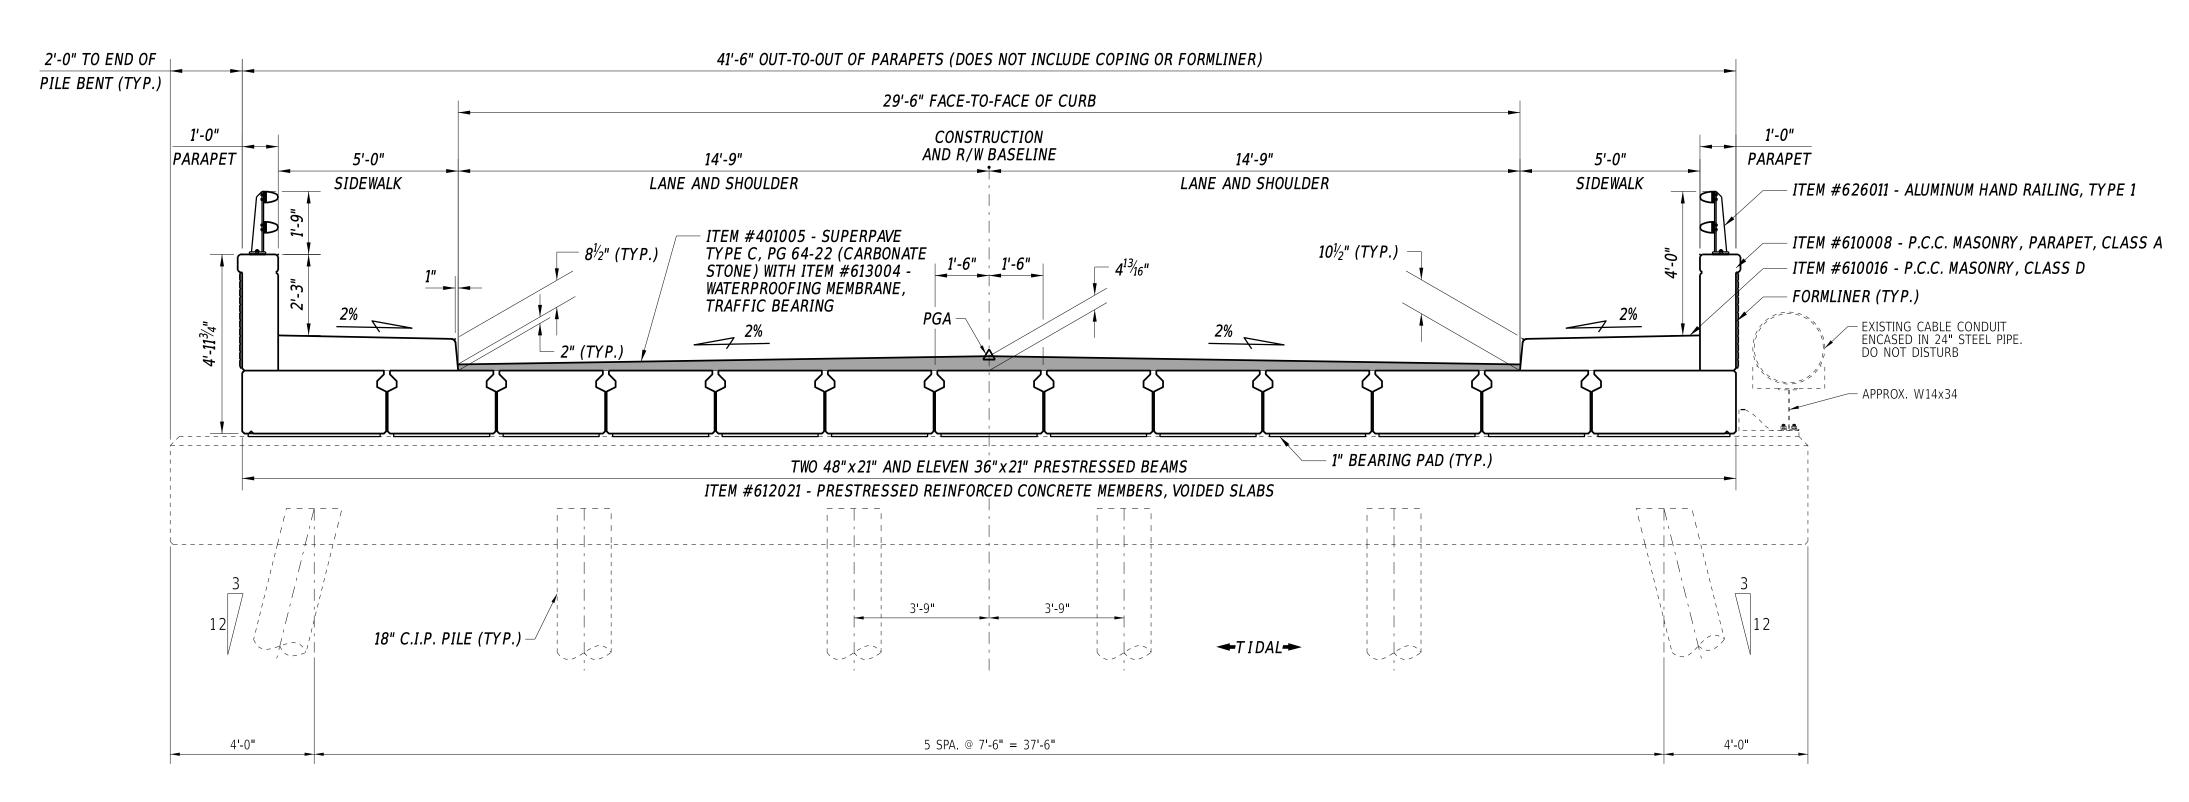


PROPOSED TYPICAL SECTION AT PILE BENT


12-OCT-2020 09:28 Y:\SUSSEX\46 ADDENDA / REVISIONS


BR 3-162 ON
SA66 DELAWARE AVE
OVER BROAD CREEK


CONTRACT
T201607602
DESIGNED BY: S. WEAVER

BRIDGE EXISTING
BRIDGE EXISTING
AND PROPOSED SECTION
SHEET NO.
10

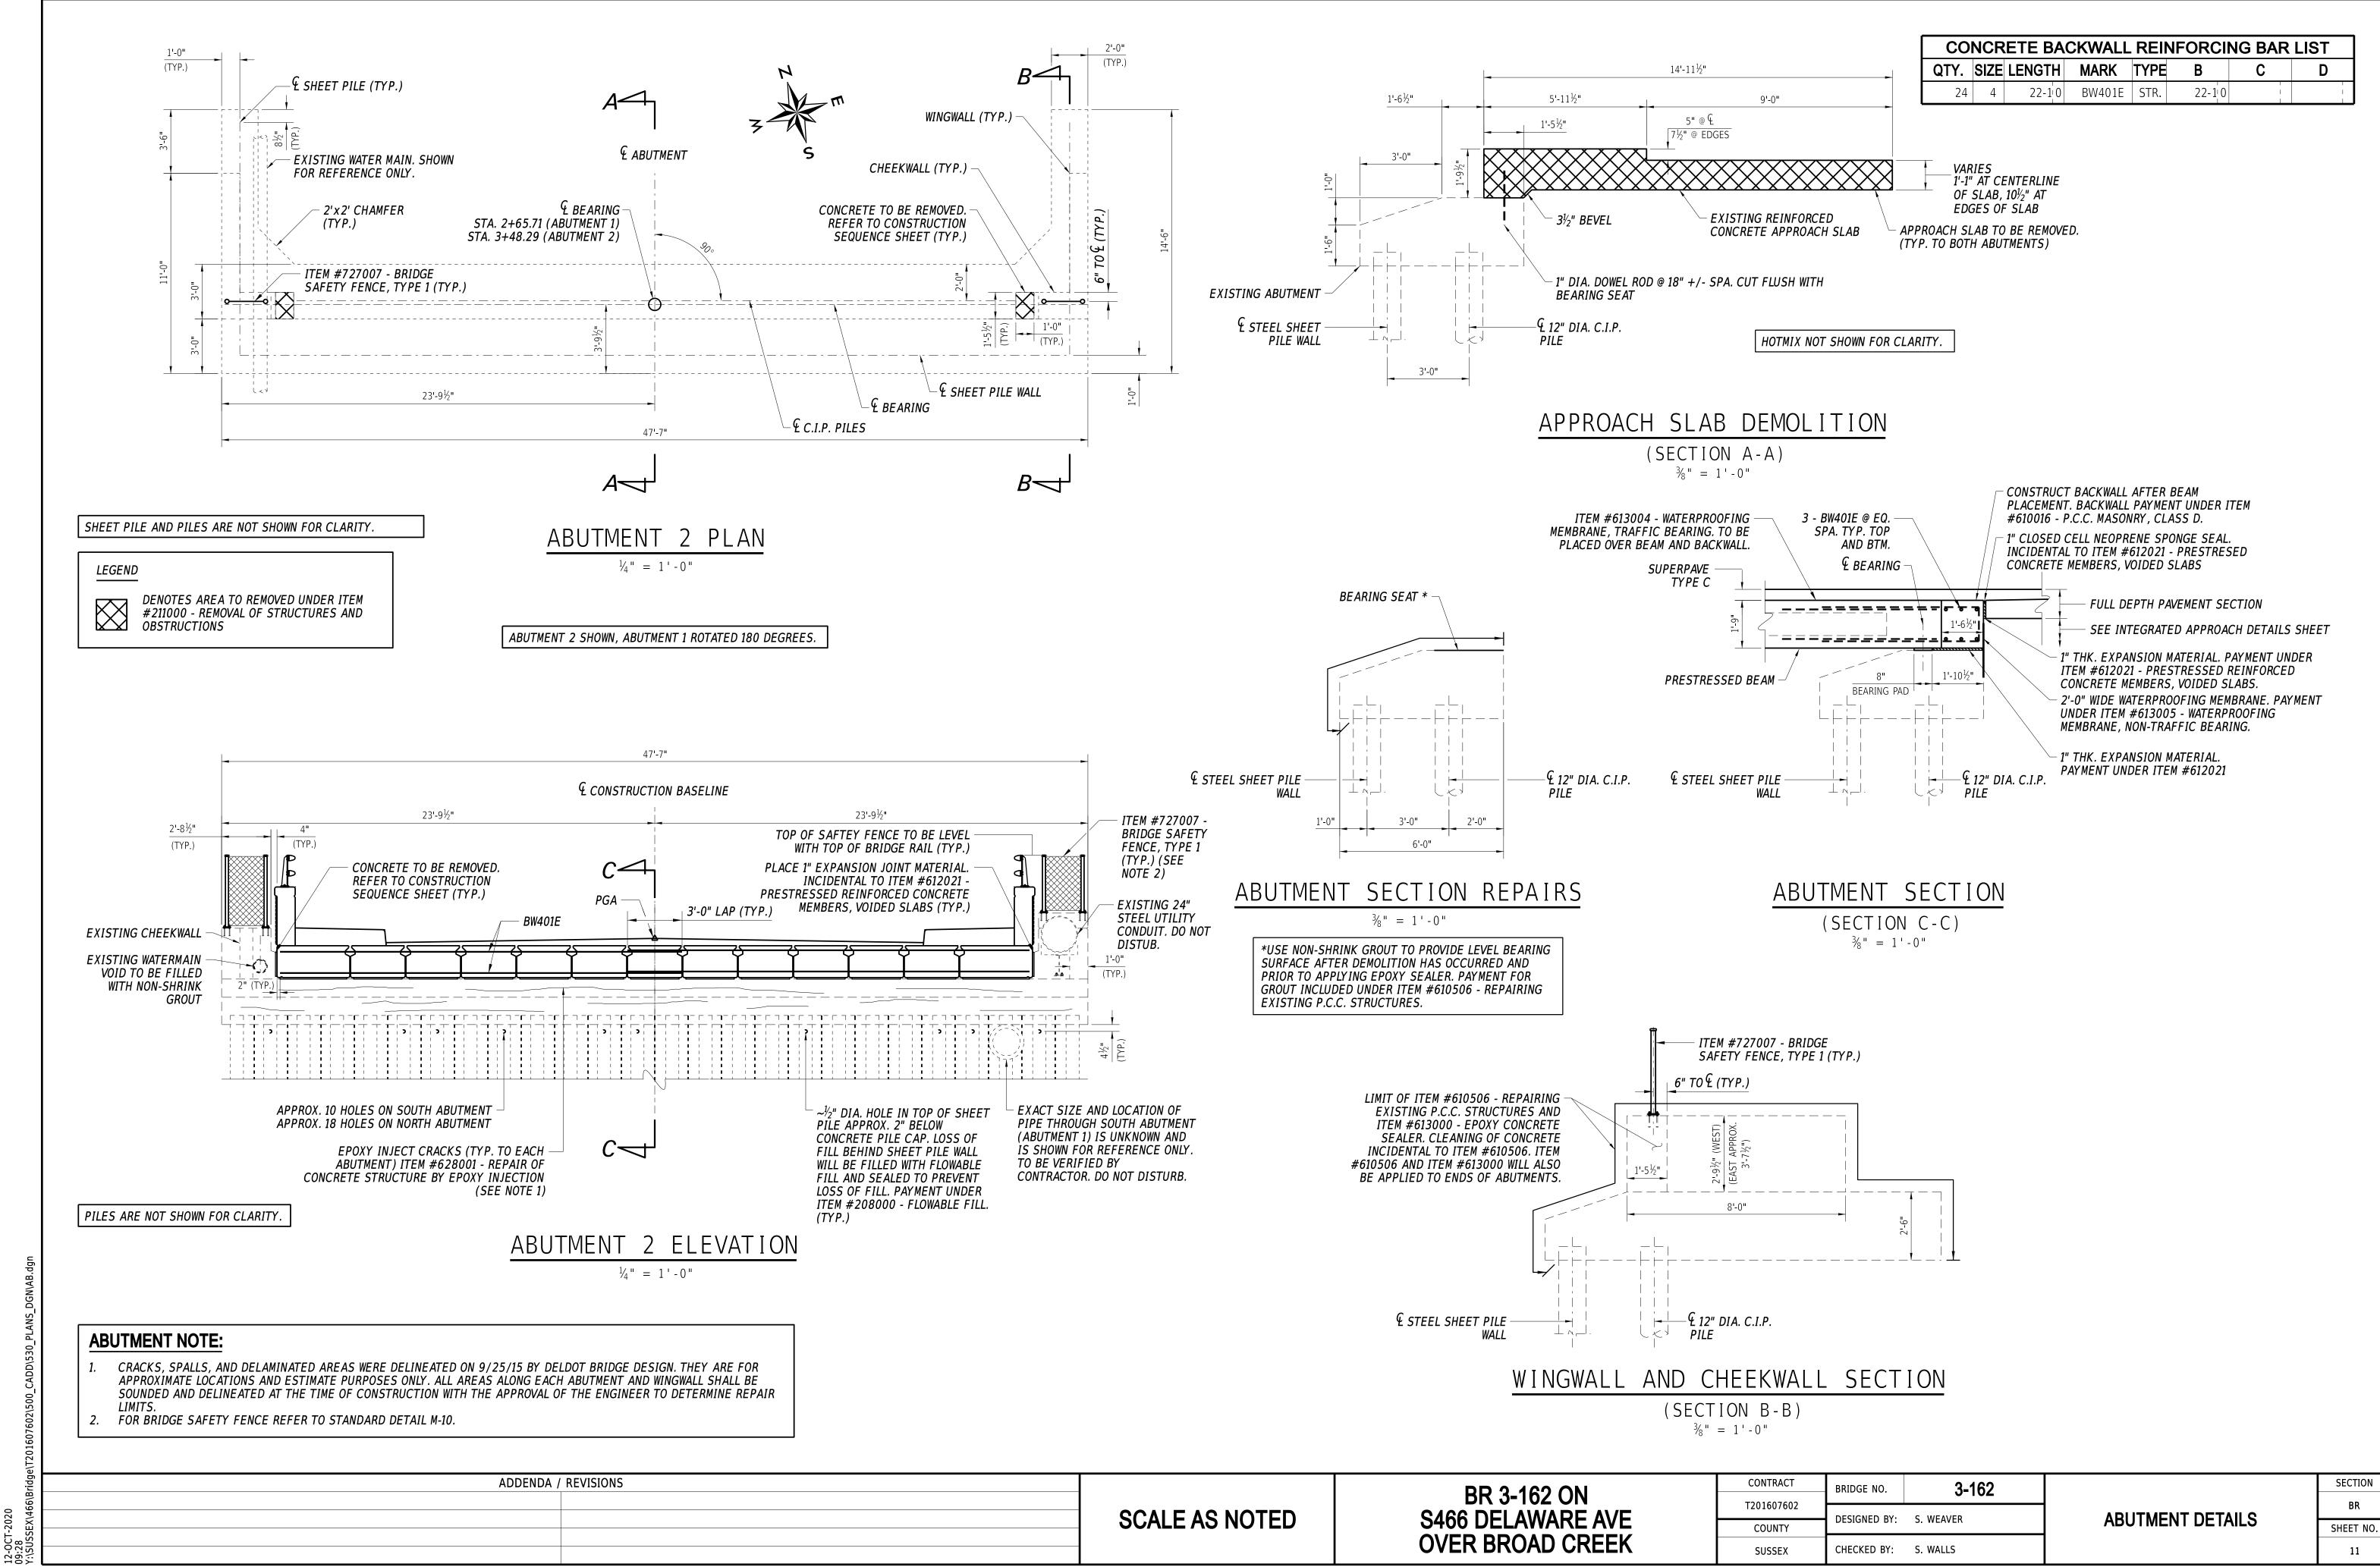

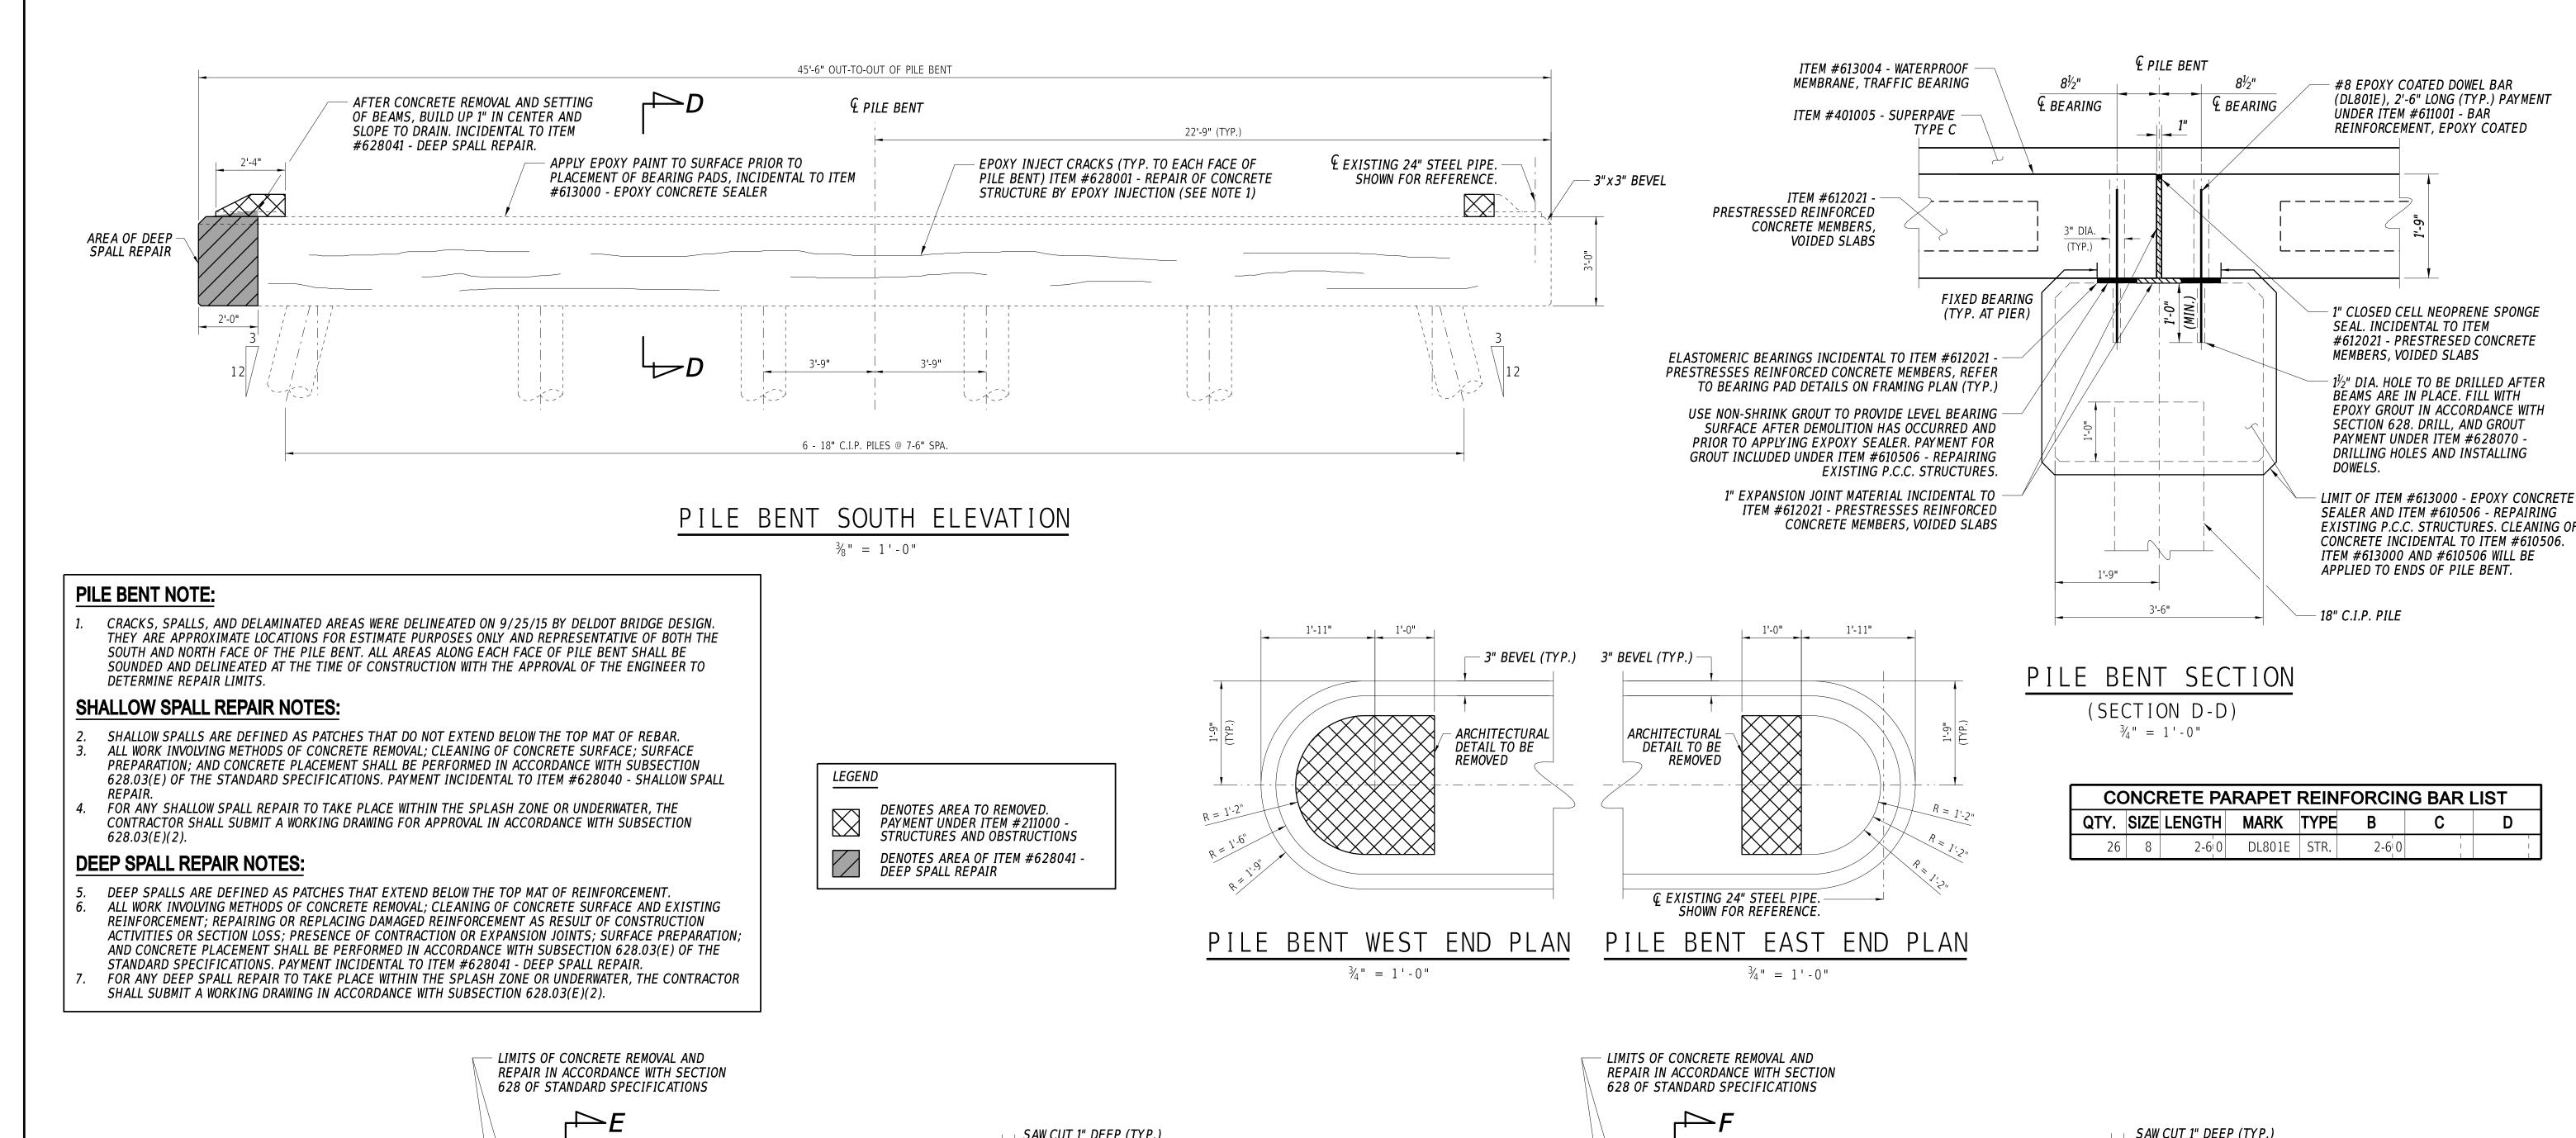

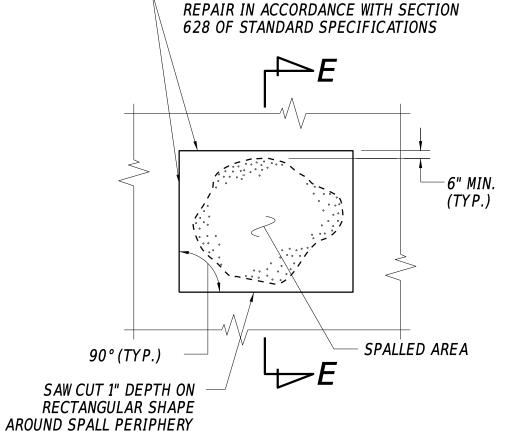

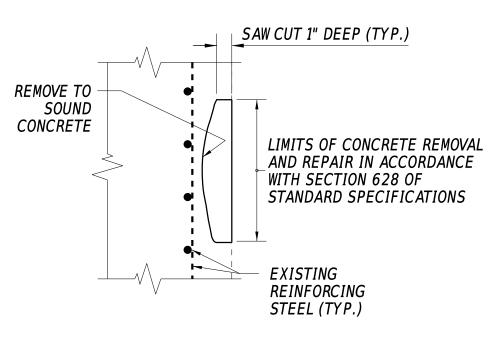

REPAIR IN ACCORDANCE WITH SECTION
628 OF STANDARD SPECIFICATIONS

6" MIN.
(TYP.)

SAW CUT 1" DEPTH ON
RECTANGULAR SHAPE
AROUND SPALL PERIPHERY

REMOVE TO
SOUND
CONCRETE

LIMITS OF CONCRETE REMOVAL
AND REPAIR IN ACCORDANCE
WITH SECTION 628 OF
STANDARD SPECIFICATIONS

EXISTING
REINFORCING
STEEL (TYP.)

MINIMUM 1" BEHIND
THE EXISTING
REINFORCEMENT

PLAN

SECTION E-E

SHALLOW SPALL REPAIR

N.T.S.

PLAN


SECTION F-F

DEEP SPALL REPAIR

N.T.S.

ADDENDA / REVISIONS		BR 3-162 ON S466 DELAWARE AVE	CONTRACT	BRIDGE NO. 3-162		SECTION
			T201607602	0-102		RD
	SCALE AS MOTED		1201007002	DESIGNED BY: S. WEAVER	PILE BENT DETAILS	DIV
	SCALE AS NOTED		COUNTY	DESIGNED DT. S. WEAVER		SHEET NO.
		OVER BROAD CREEK	SUSSEX	CHECKED BY: S. WALLS		12

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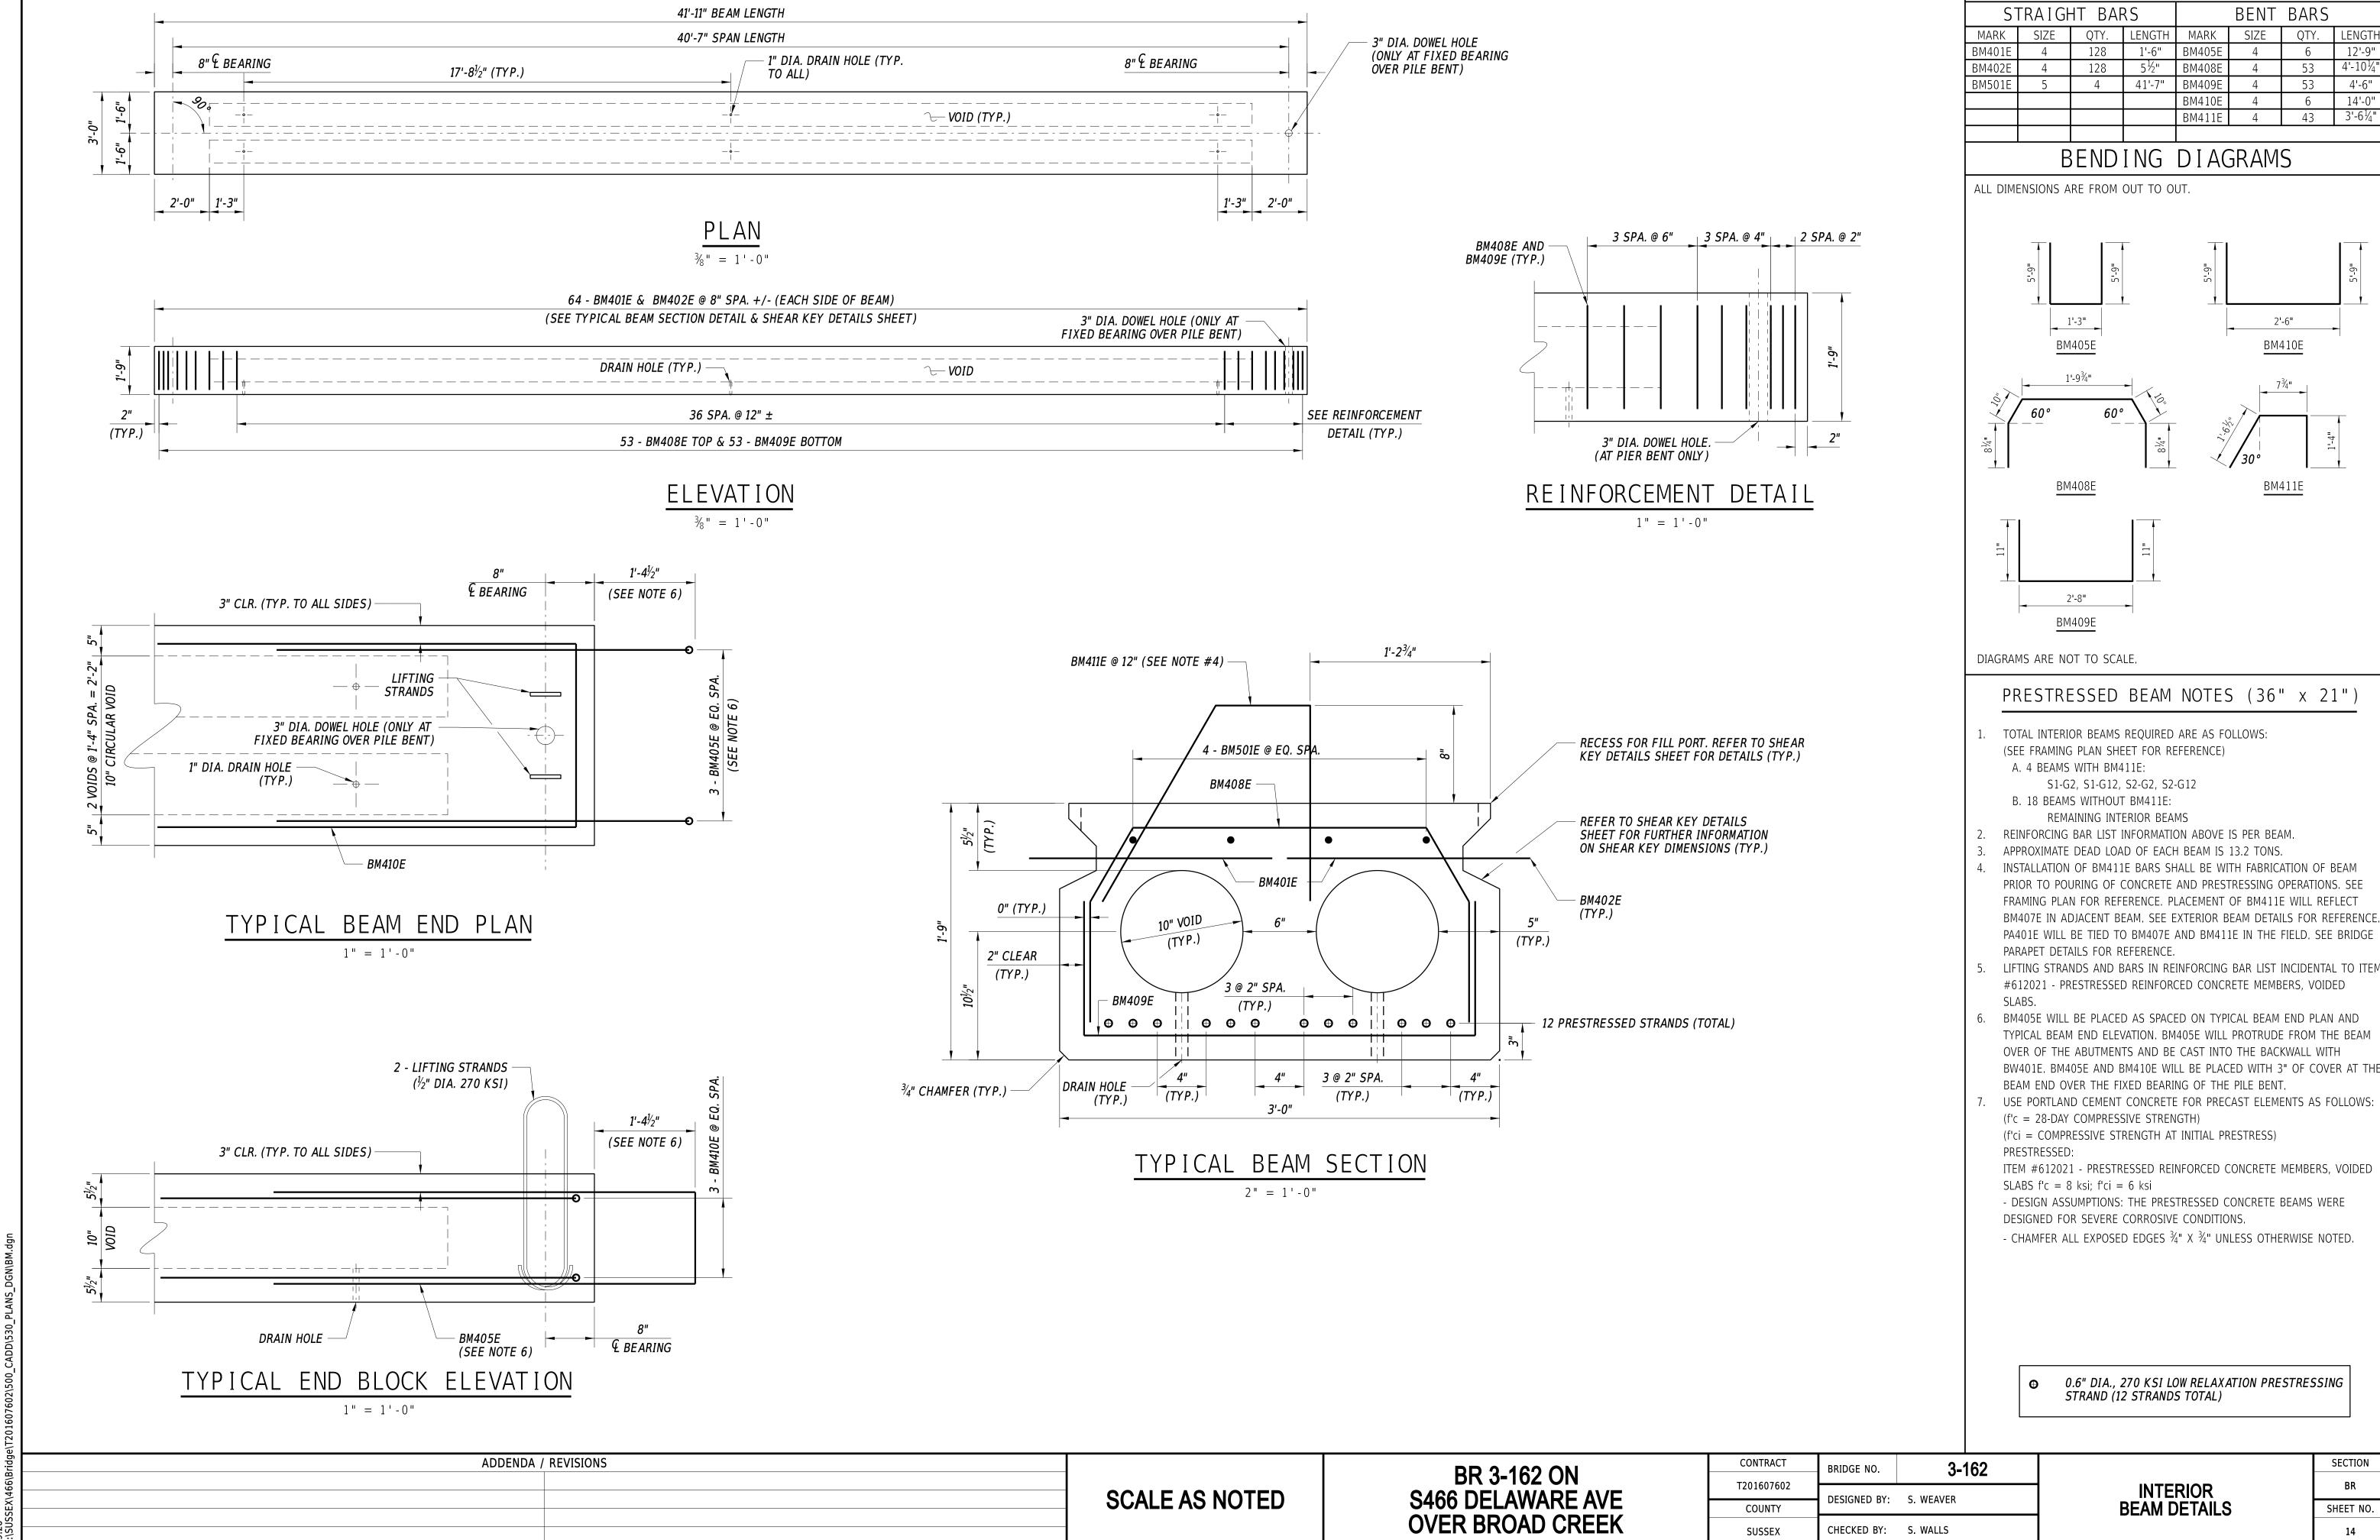
13

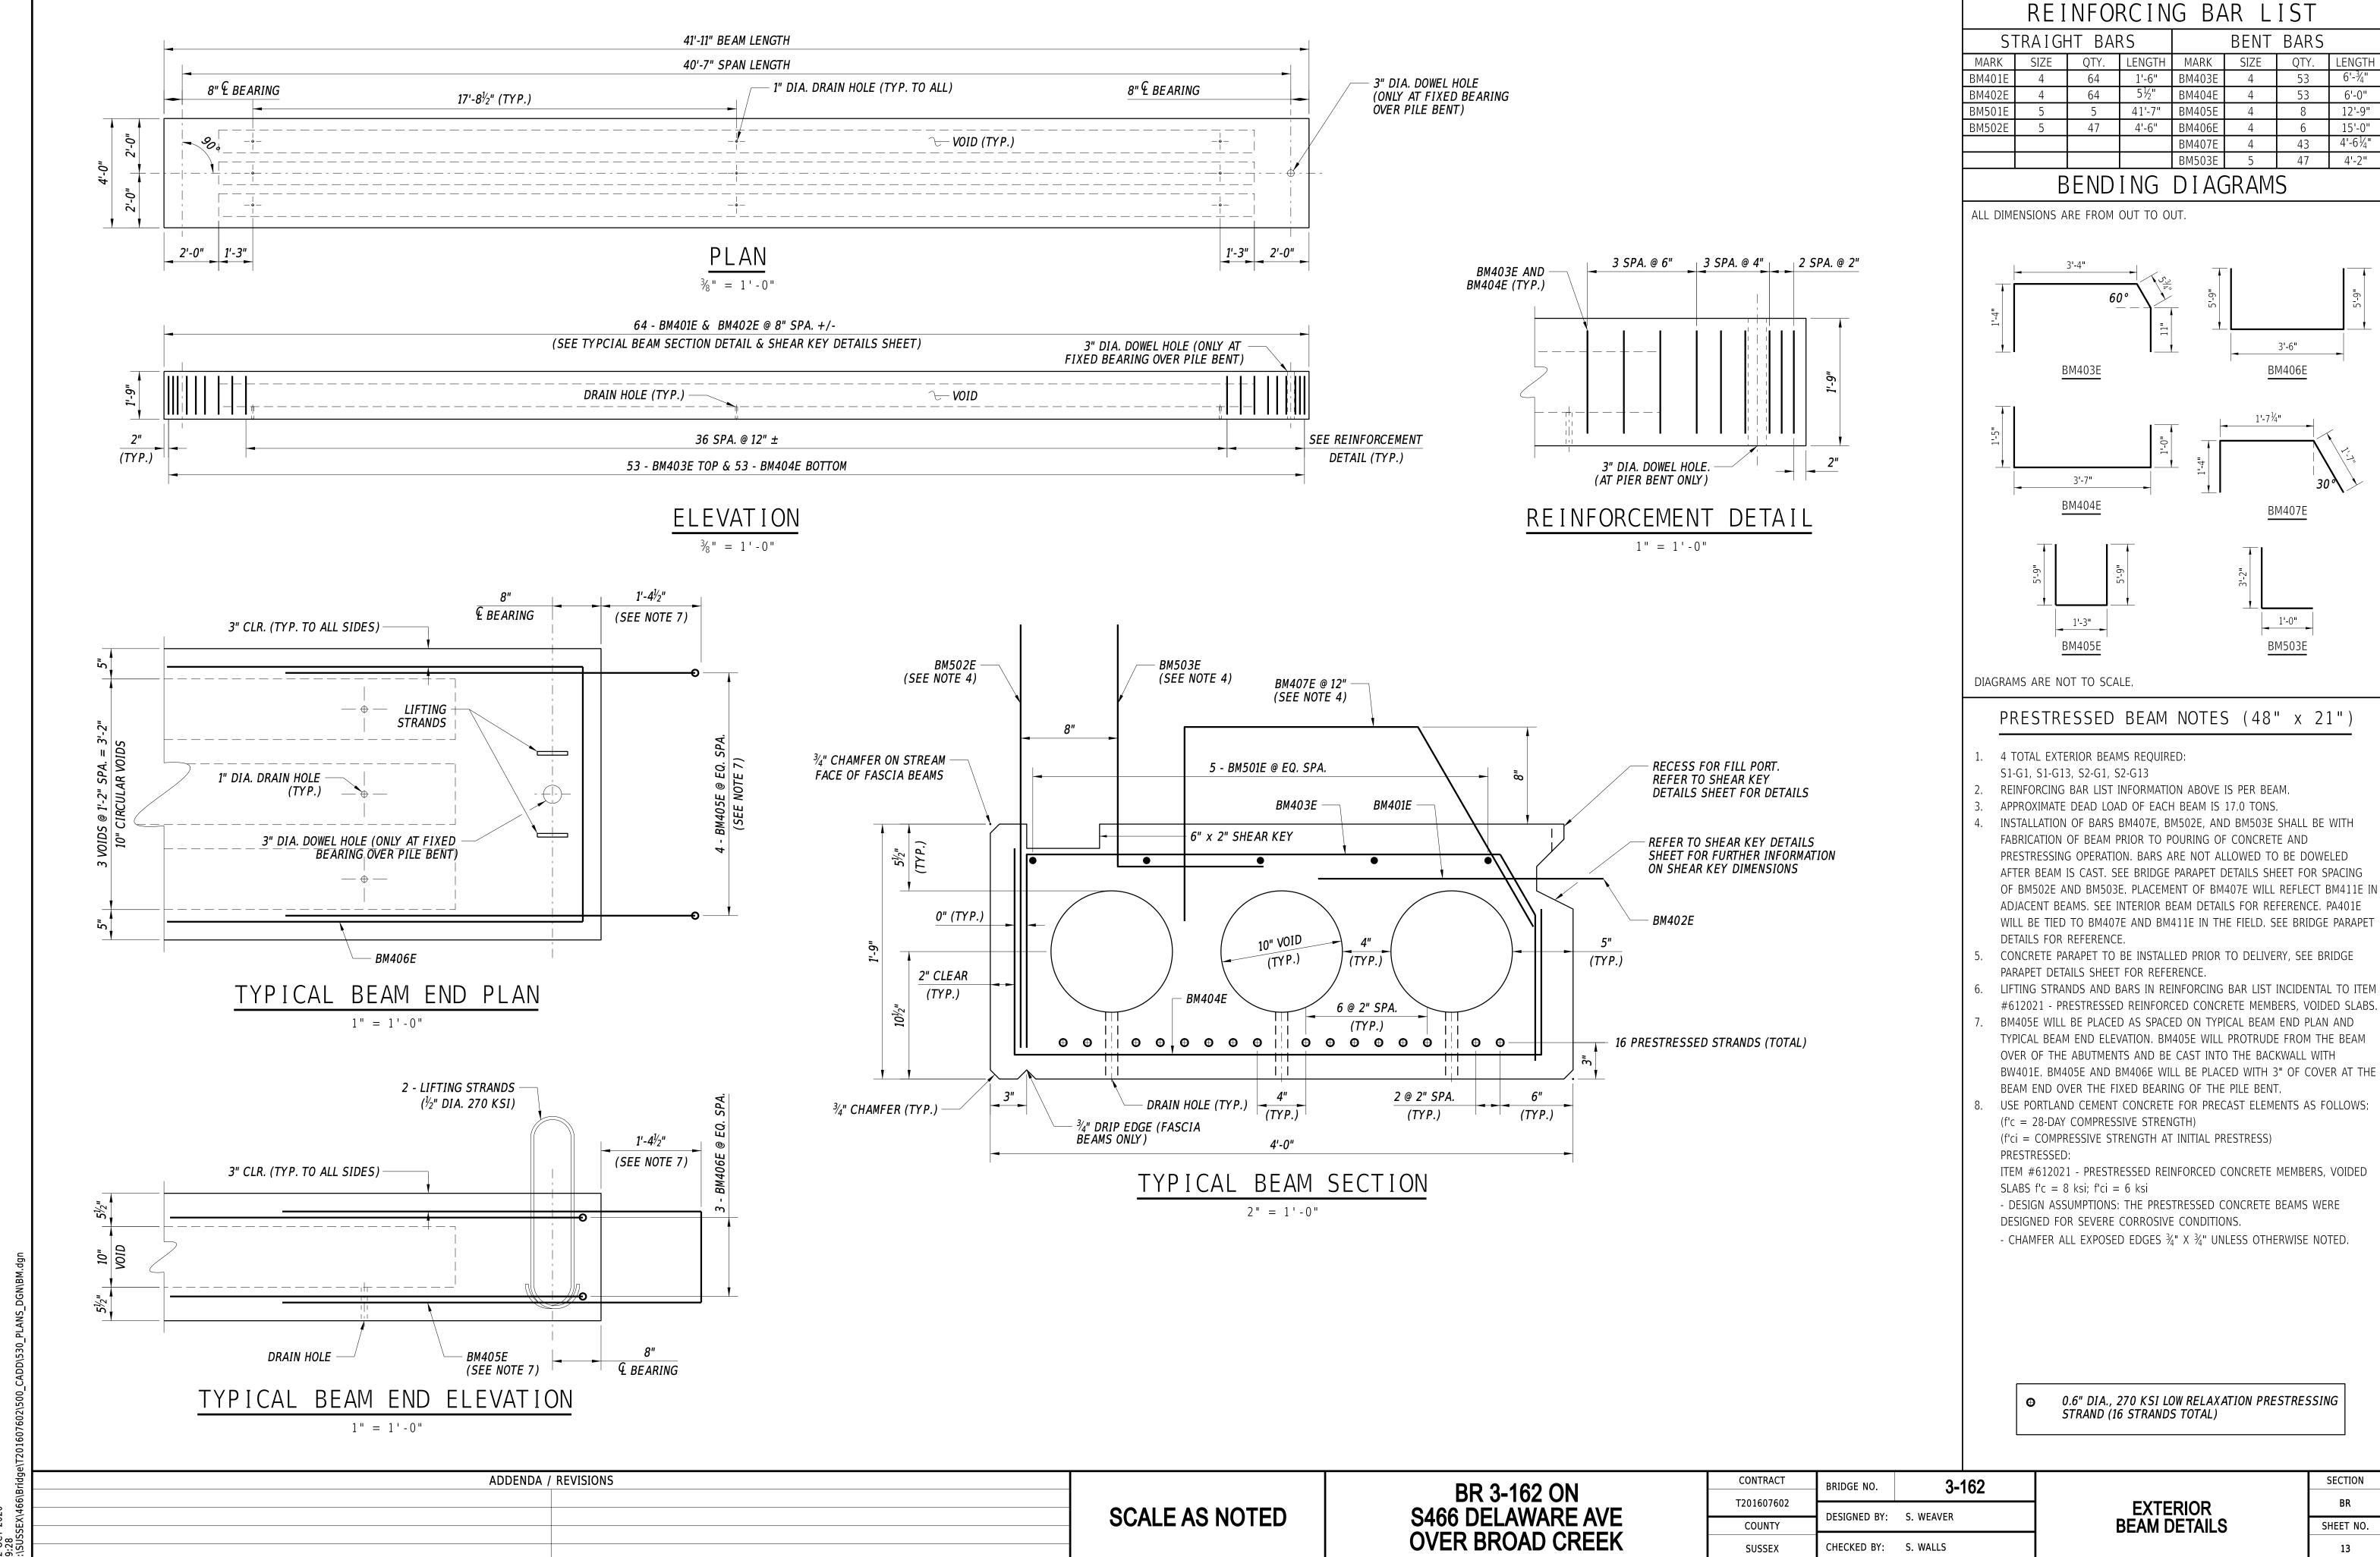COUNTY

SUSSEX

CHECKED BY: S. WALLS

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REINFORCING BAR LIST

BEAM DETAILS

COUNTY

SUSSEX

CHECKED BY: S. WALLS


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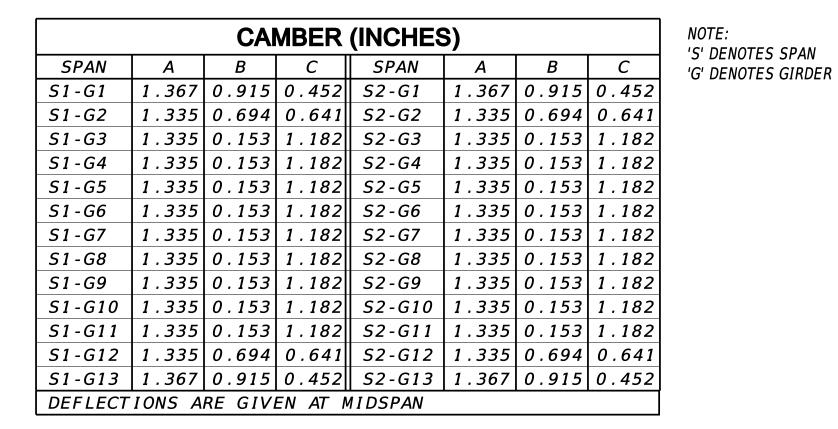
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- A = ESTIMATED PRESTRESS CAMBER LESS DEFLECTION DUE TO DEAD LOAD OF BEAM TIMES CREEP.
- B = DEFLECTION DUE TO DEAD LOAD OF OVERLAY AND PARAPET.
- C = A B = NET CAMBER.


CAMBER DIAGRAM



SHEAR KEY NOTES:


- TO CREATE AN EXPOSED COARSE AGGREGATE SURFACE, AN IN-FORM RETARDER SHALL BE APPLIED FROM THE TOP OF BEAM TO BOTTOM OF THE SHEAR KEY ALONG THE FULL LENGTH OF BEAM ON BOTH SIDES. NO STAINS FROM OIL, GREASE OR OTHER CONTAMINATES SHALL BE PRESENT WITHIN THE SHEAR KEY. OMIT THE SHEAR KEY DETAIL AND BM401E AND BM402E BARS ON THE STREAM FACE OF THE FASCIA BEAMS.
- BM402E BARS SHALL BE INSTALLED PRIOR TO DELIVERING BEAMS TO THE CONSTRUCTION SITE. AN ALTERNATIVE METHOD TO THREADED BM402E BARS PROTRUDING INTO THE SHEAR KEY SPACE MAY BE SUBMITTED FOR APPROVAL BY THE ENGINEER. BARS SHALL BE STAGGERED ACCORDING TO THE DETAILS PROVIDED ON THIS SHEET TO FORM A NON CONTACT LAP SPLICE.
- RECESS TOP OF SHEAR KEY 1" x 8" FOR A FILL PORT, AT BEAM ENDS AND AT QUARTER POINTS ALONG THE BEAM.

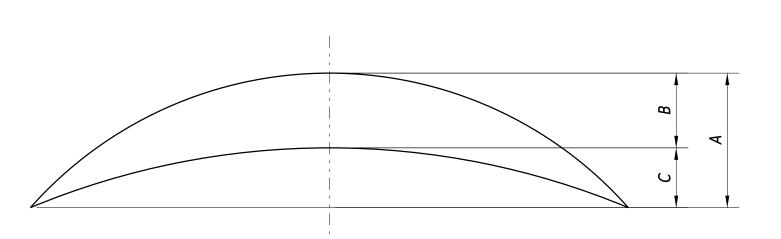VALUE ENGINEERING PROPOSALS ELIMINATING THE USE OF UHPC WILL NOT BE CONSIDERED.

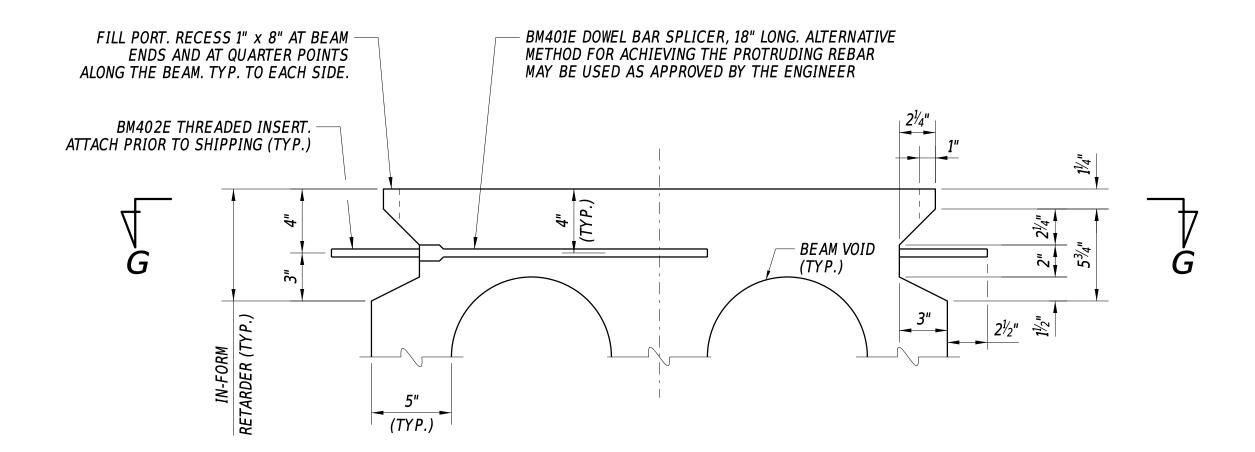



SHEAR KEY SECTION

2" = 1' - 0"

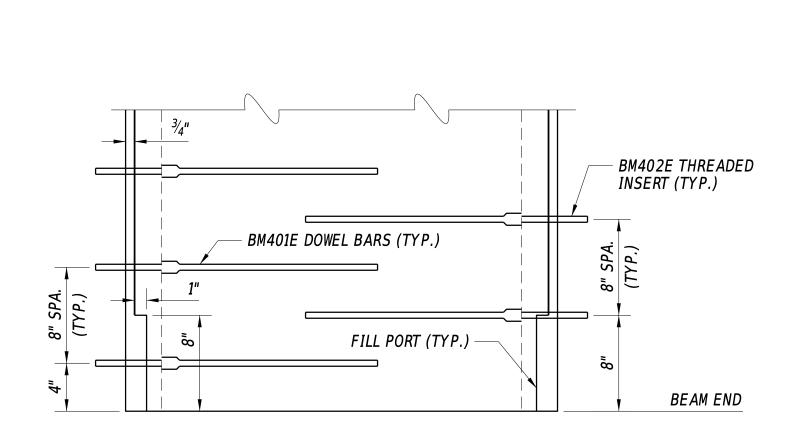

BEAM PLAN (SECTION G-G) $1\frac{1}{2}$ " = 1'-0"

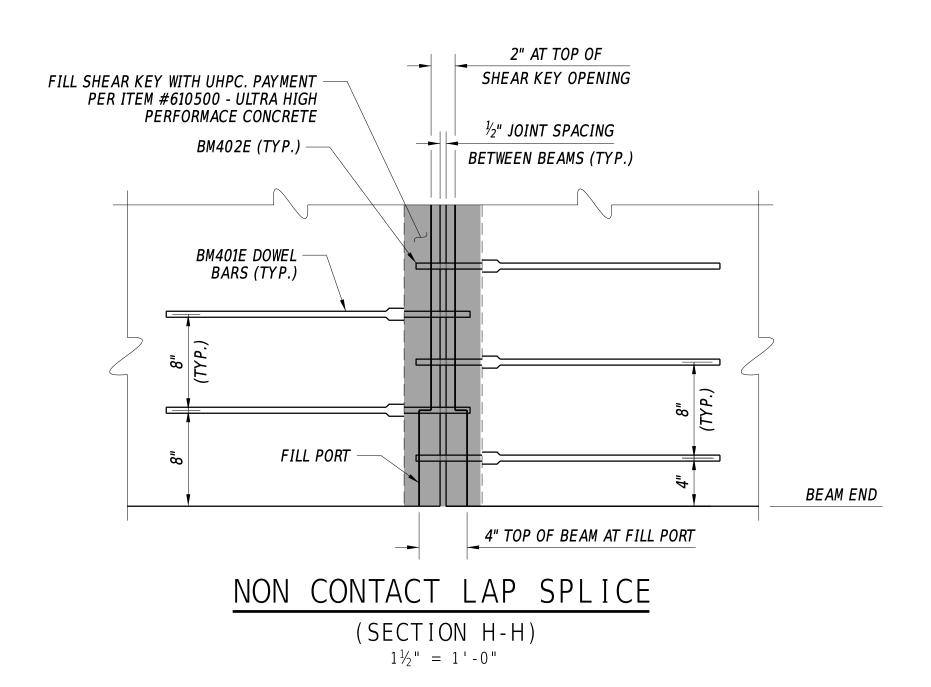

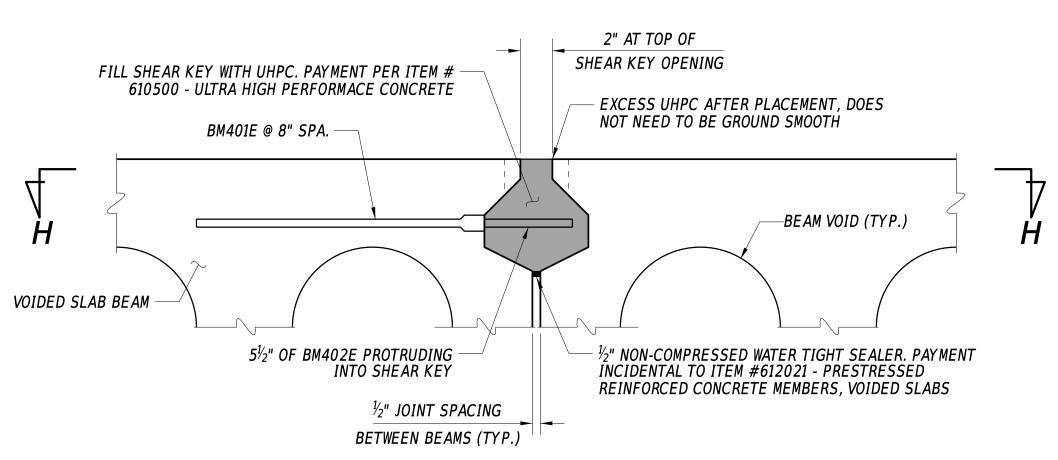

SHEAR	KEY	DE	TAIL
2	" = 1'-	0"	

ADDENDA / REVISIONS SCALE AS NOTED


BR 3-162 ON S466 DELAWARE AVE OVER BROAD CREEK

CONTRACT	BRIDGE NO.	3-162					
T201607602		0 102	1				
120100/002	DECICNED BY.	C MEAVED					
COUNTY	DESIGNED BY:	5. WEAVER					
SUSSEX	CHECKED BY:	S. WALLS					

SHEAR KEY DETAILS

SECTION SHEET NO.

12-OCT-2020 09:28 Y:\SUSSEX\46

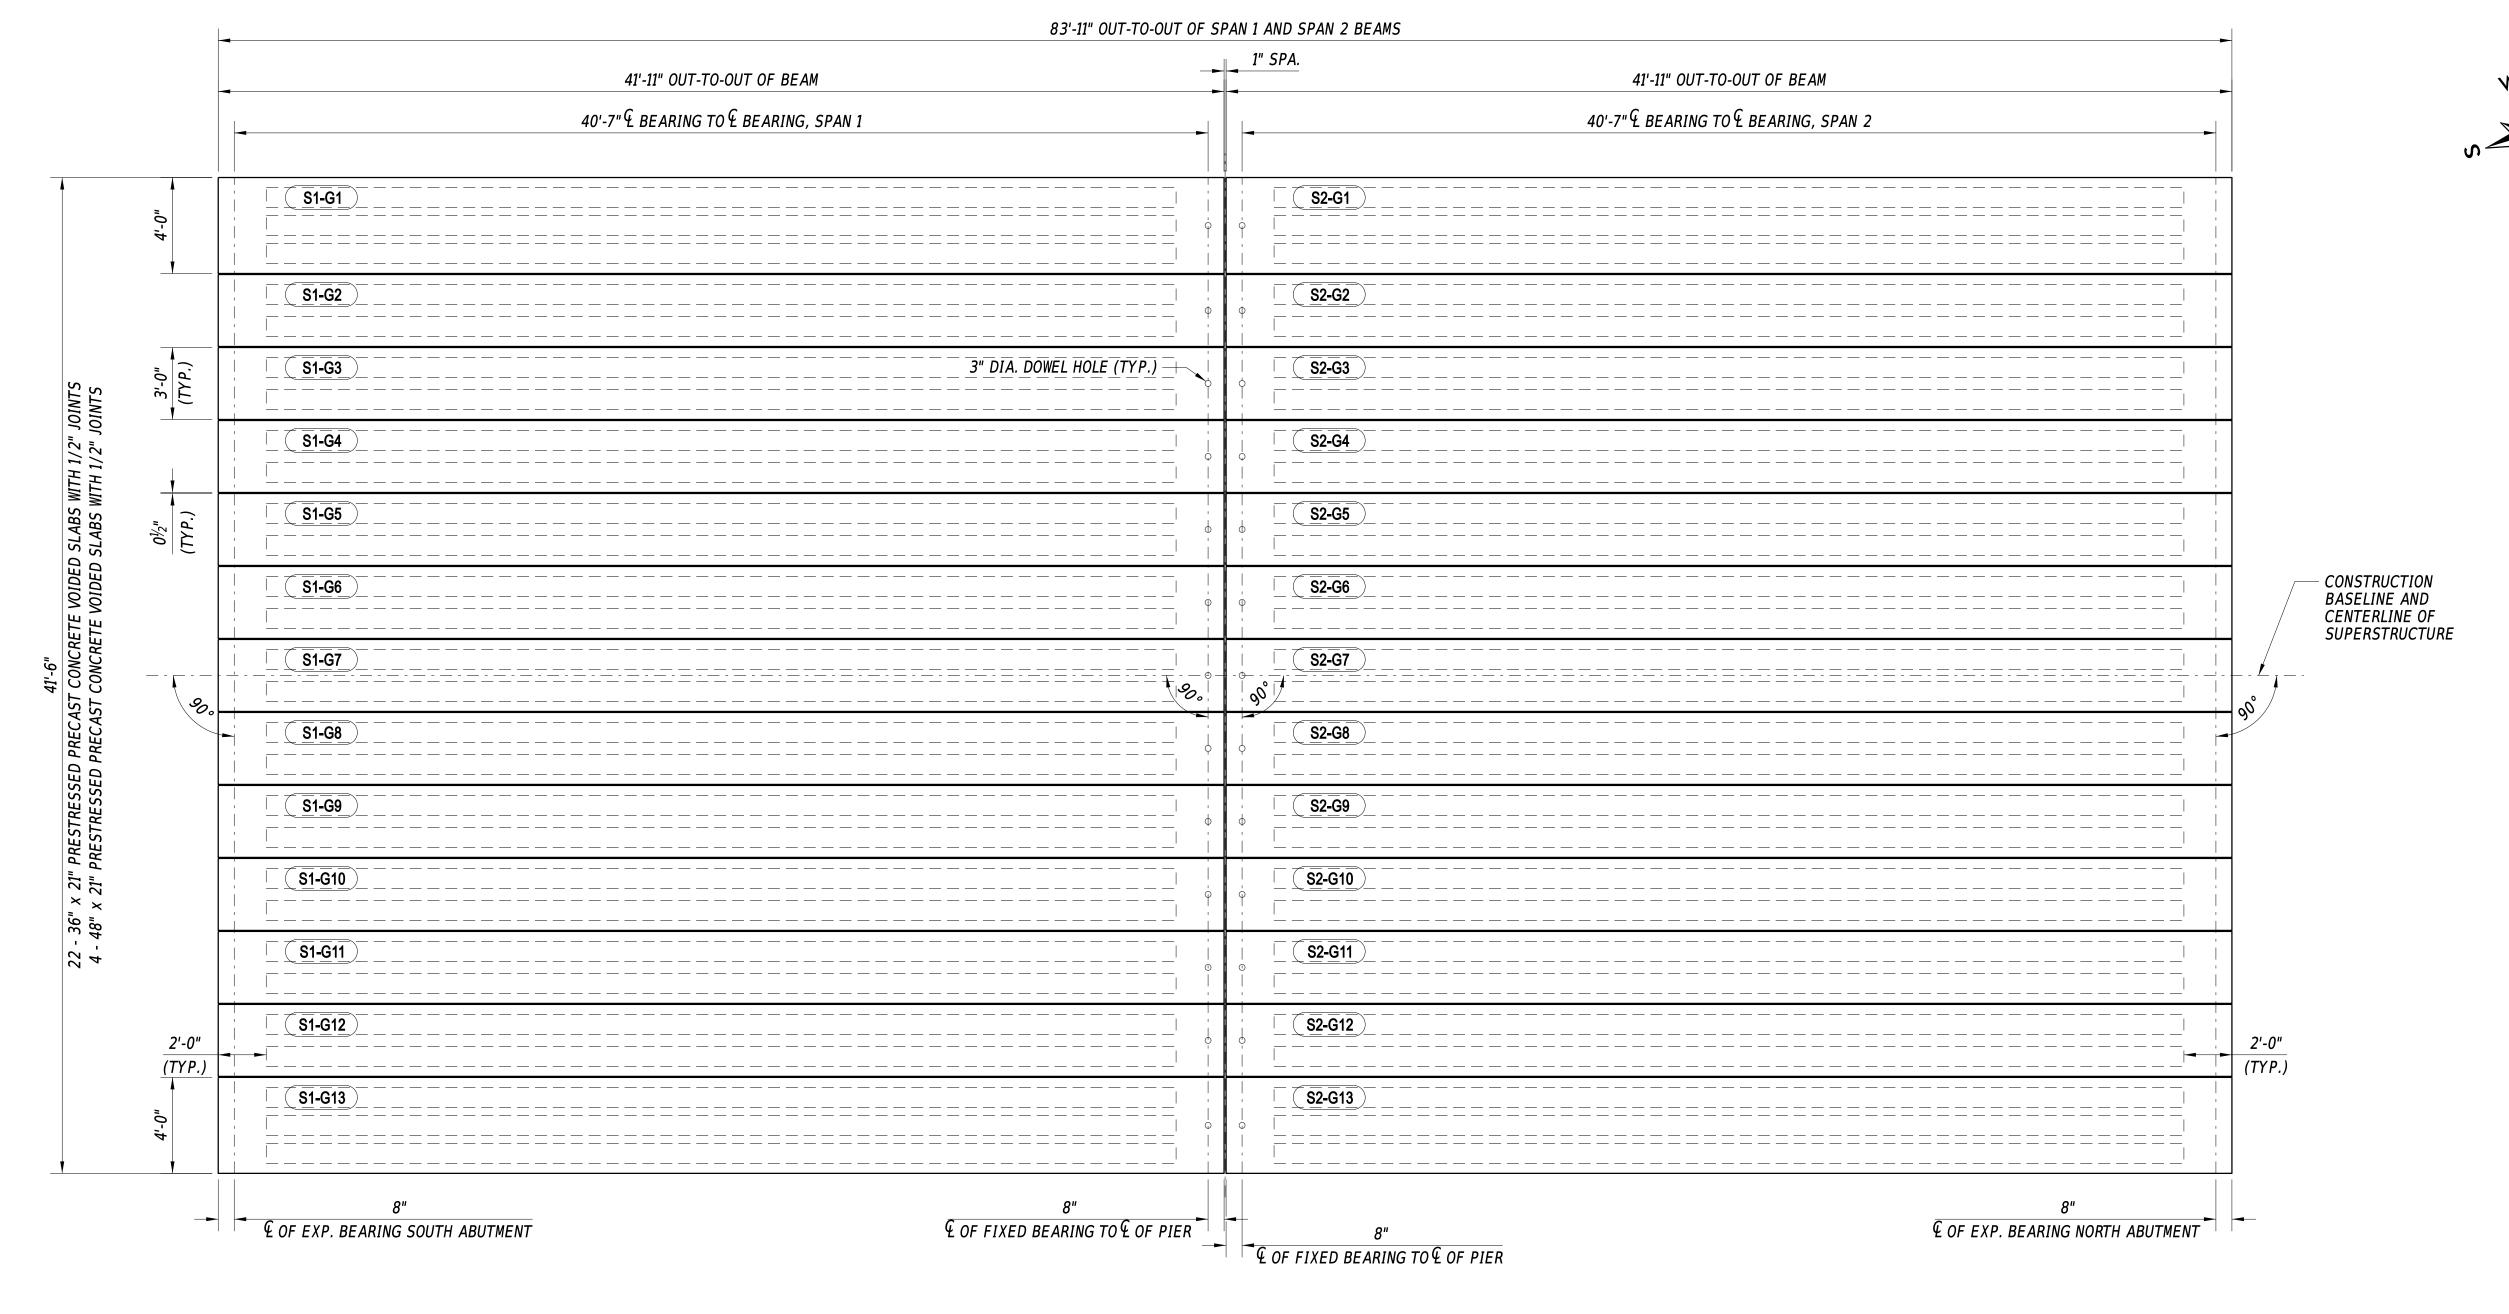


FRAMING PLAN

FRAMING PLAN NOTES:

- FILL BEARING DOWEL HOLES WITH APPROVED HIGH STRENGTH, NON-SHRINK, NON-EXPANDING, NON-STAIN GROUT. PAYMENT INCLUDED UNDER ITEM #628070 - DRILLING HOLES AND INSTALLING DOWELS.
- 2. FILL ALL SHEAR KEYWAYS AND CAVITIES WITH APPROVED ULTRA HIGH PERFORMANCE CONCRETE (UHPC). PAYMENT UNDER ITEM #610500 - ULTRA HIGH PERFORMANCE CONCRETE.
- DO NOT MIX OR POUR UHPC WITHOUT A MANUFACTURING REPRESENTATIVE ONSITE.
 PRE-WET THE SHEAR KEY VOID TO A SATURATED-SURFACE-DRY (SSD) CONDITION IMMEDIATELY BEFORE THE PLACEMENT OF UHPC. PLACING UHPC BETWEEN BEAM SECTIONS SHALL BE DONE WHEN THE AIR TEMPERATURE IS ABOVE 40°F OR AS PER THE
- MANUFACTURER'S RECOMMENDATION, WHICHEVER IS HIGHER. NO TRAFFIC OR EQUIPMENT SHALL BE PERMITTED ON THE BRIDGE UNTIL THE UHPC HAS A MINIMUM COMPRESSIVE STRENGTH OF 15 KSI OR UNLESS OTHERWISE APPROVED BY THE ENGINEER. WATERPROOFING MEMBRANE SHALL BE INSTALLED ACROSS THE TOP OF BEAMS AND BACKWALLS. PAYMENT UNDER ITEM #613004 -WATERPROOFING MEMBRANE, TRAFFIC BEARING. WATERPROOFING MEMBRANE WILL NOT BE APPLIED UNTIL UHPC COMPRESSIVE STRENGTH HAS REACHED 10KSI.

BEARING PAD NOTES:

- 52 TOTAL ELASTOMERIC BEARINGS REQUIRED. 44 2'-8" BEARING PADS AND 8 3'-8" BEARING PADS ARE REQUIRED. (22 2'-8" PADS AND 4 3'-8" PADS SHALL INCLUDE 3" DIA. DOWEL HOLE TO BE USED AT FIXED BEARING OVER PIER)
- ALL ELASTOMERIC BEARINGS SHALL BE 50 MIN. DUROMETER IN ACCORDANCE WITH REQUIREMENTS SPECIFIED IN SECTION 623 OF THE STANDARD SPECIFICATIONS.
- ELASTOMERIC BEARINGS SHALL BE ATTACHED TO THE TOP OF ABUTMENT SEAT AND TOP OF PILE BENT WITH AN APPROVED EPOXY ADHESIVE IN ACCORDANCE WITH SECTION 623.03(C) OF THE STANDARD SPECIFICATIONS IN SUCH A WAY THAT VISIBLE CONCRETE SURFACES WILL NOT BE STAINED. ENSURE THE EPOXY ADHESIVE HAS SET PRIOR TO PLACEMENT OF BEAMS.
- 4. PAYMENT FOR FABRICATION AND INSTALLATION OF ELASTOMERIC BEARINGS SHALL BE INCIDENTAL TO ITEM #612021 - PRESTRESSED REINFORCED CONCRETE MEMBERS, VOIDED SLAB.

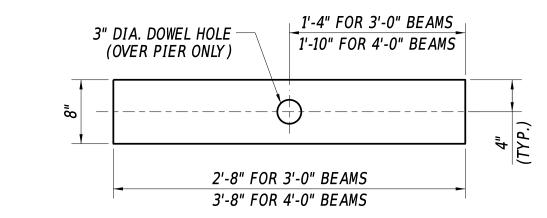


THICK ELASTOMERIC BEARING DETAIL

1" = 1'-0"

ALL EXISTING BEARING PADS AND EXISTING BONDING AGENTS SHALL BE REMOVED IN THEIR ENTIRETY. PAYMENT INCLUDED UNDER #211000 - REMOVAL OF STRUCTURES AND OBSTRUCTIONS.

ADDENDA / REVISIONS			DD 0 400 ON	CONTRACT	BRIDGE NO.	3-162		SECTION
			BR 3-162 ON	T201607602		0-102		BR
		SCALE AS NOTED	S466 DELAWARE AVE		DESIGNED BY:	S. WEAVER	FRAMING PLAN	CUEET NO
				COUNTY				SHEET NO.
			OVER BROAD CREEK	SUSSEX	CHECKED BY:	S. WALLS		16

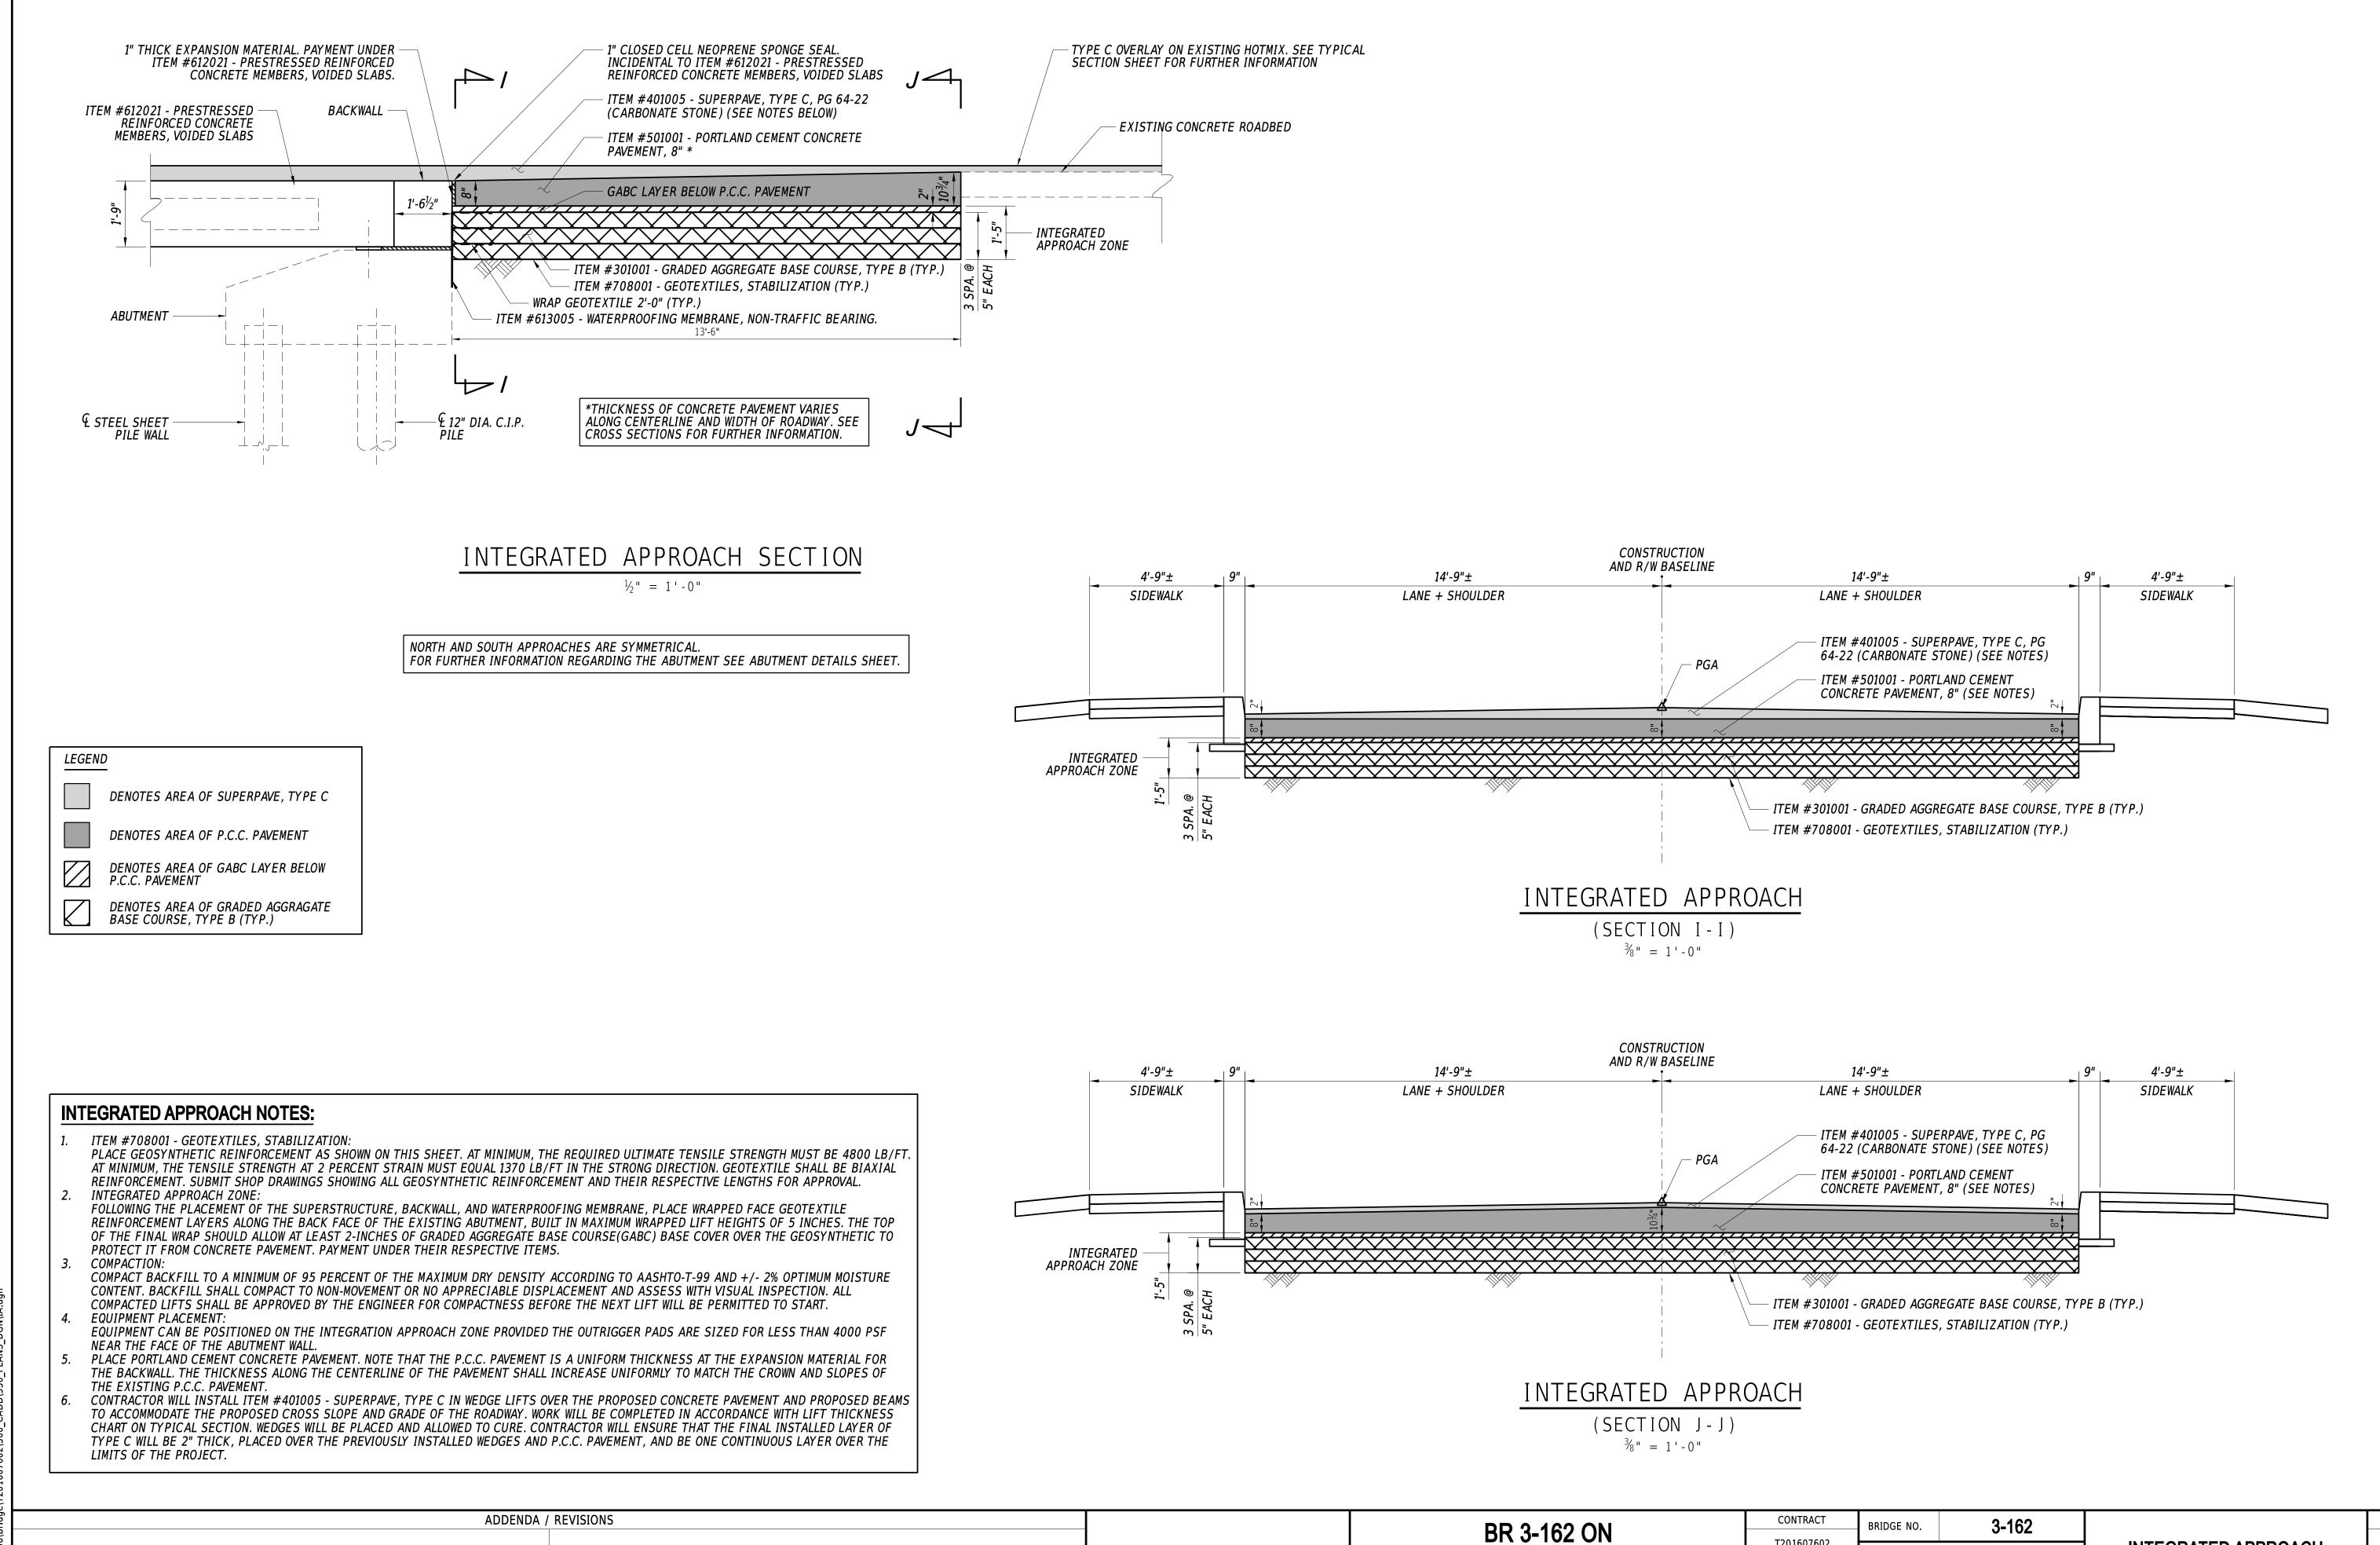

SCALE AS NOTED

T201607602

COUNTY

SUSSEX

DESIGNED BY: S. WEAVER

CHECKED BY: S. WALLS

S466 DELAWARE AVE


OVER BROAD CREEK

INTEGRATED APPROACH

DETAILS

SHEET NO.


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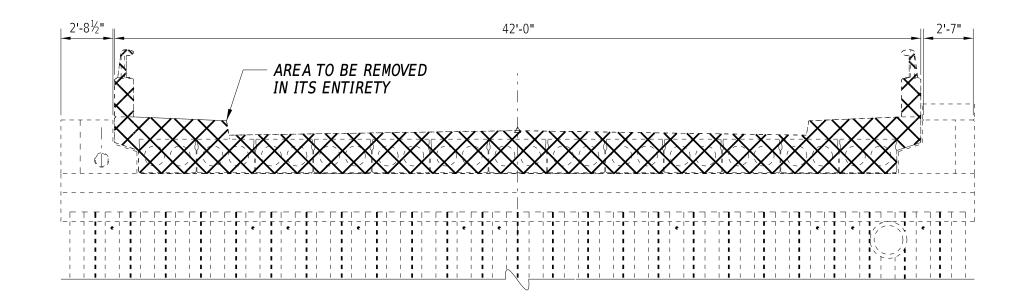
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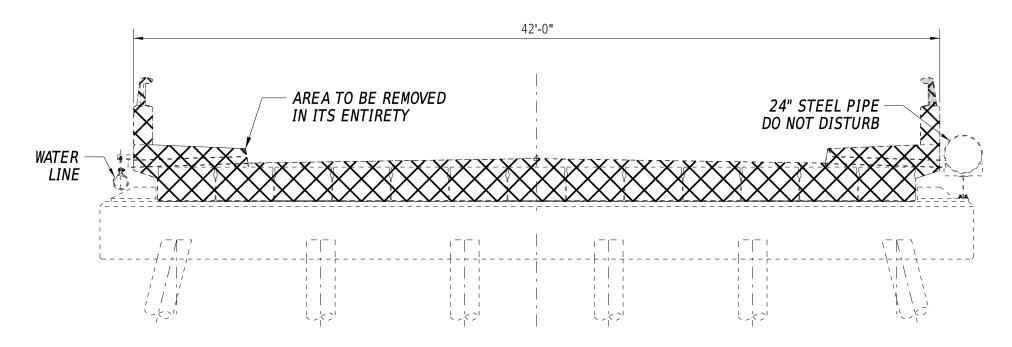
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LEGEND

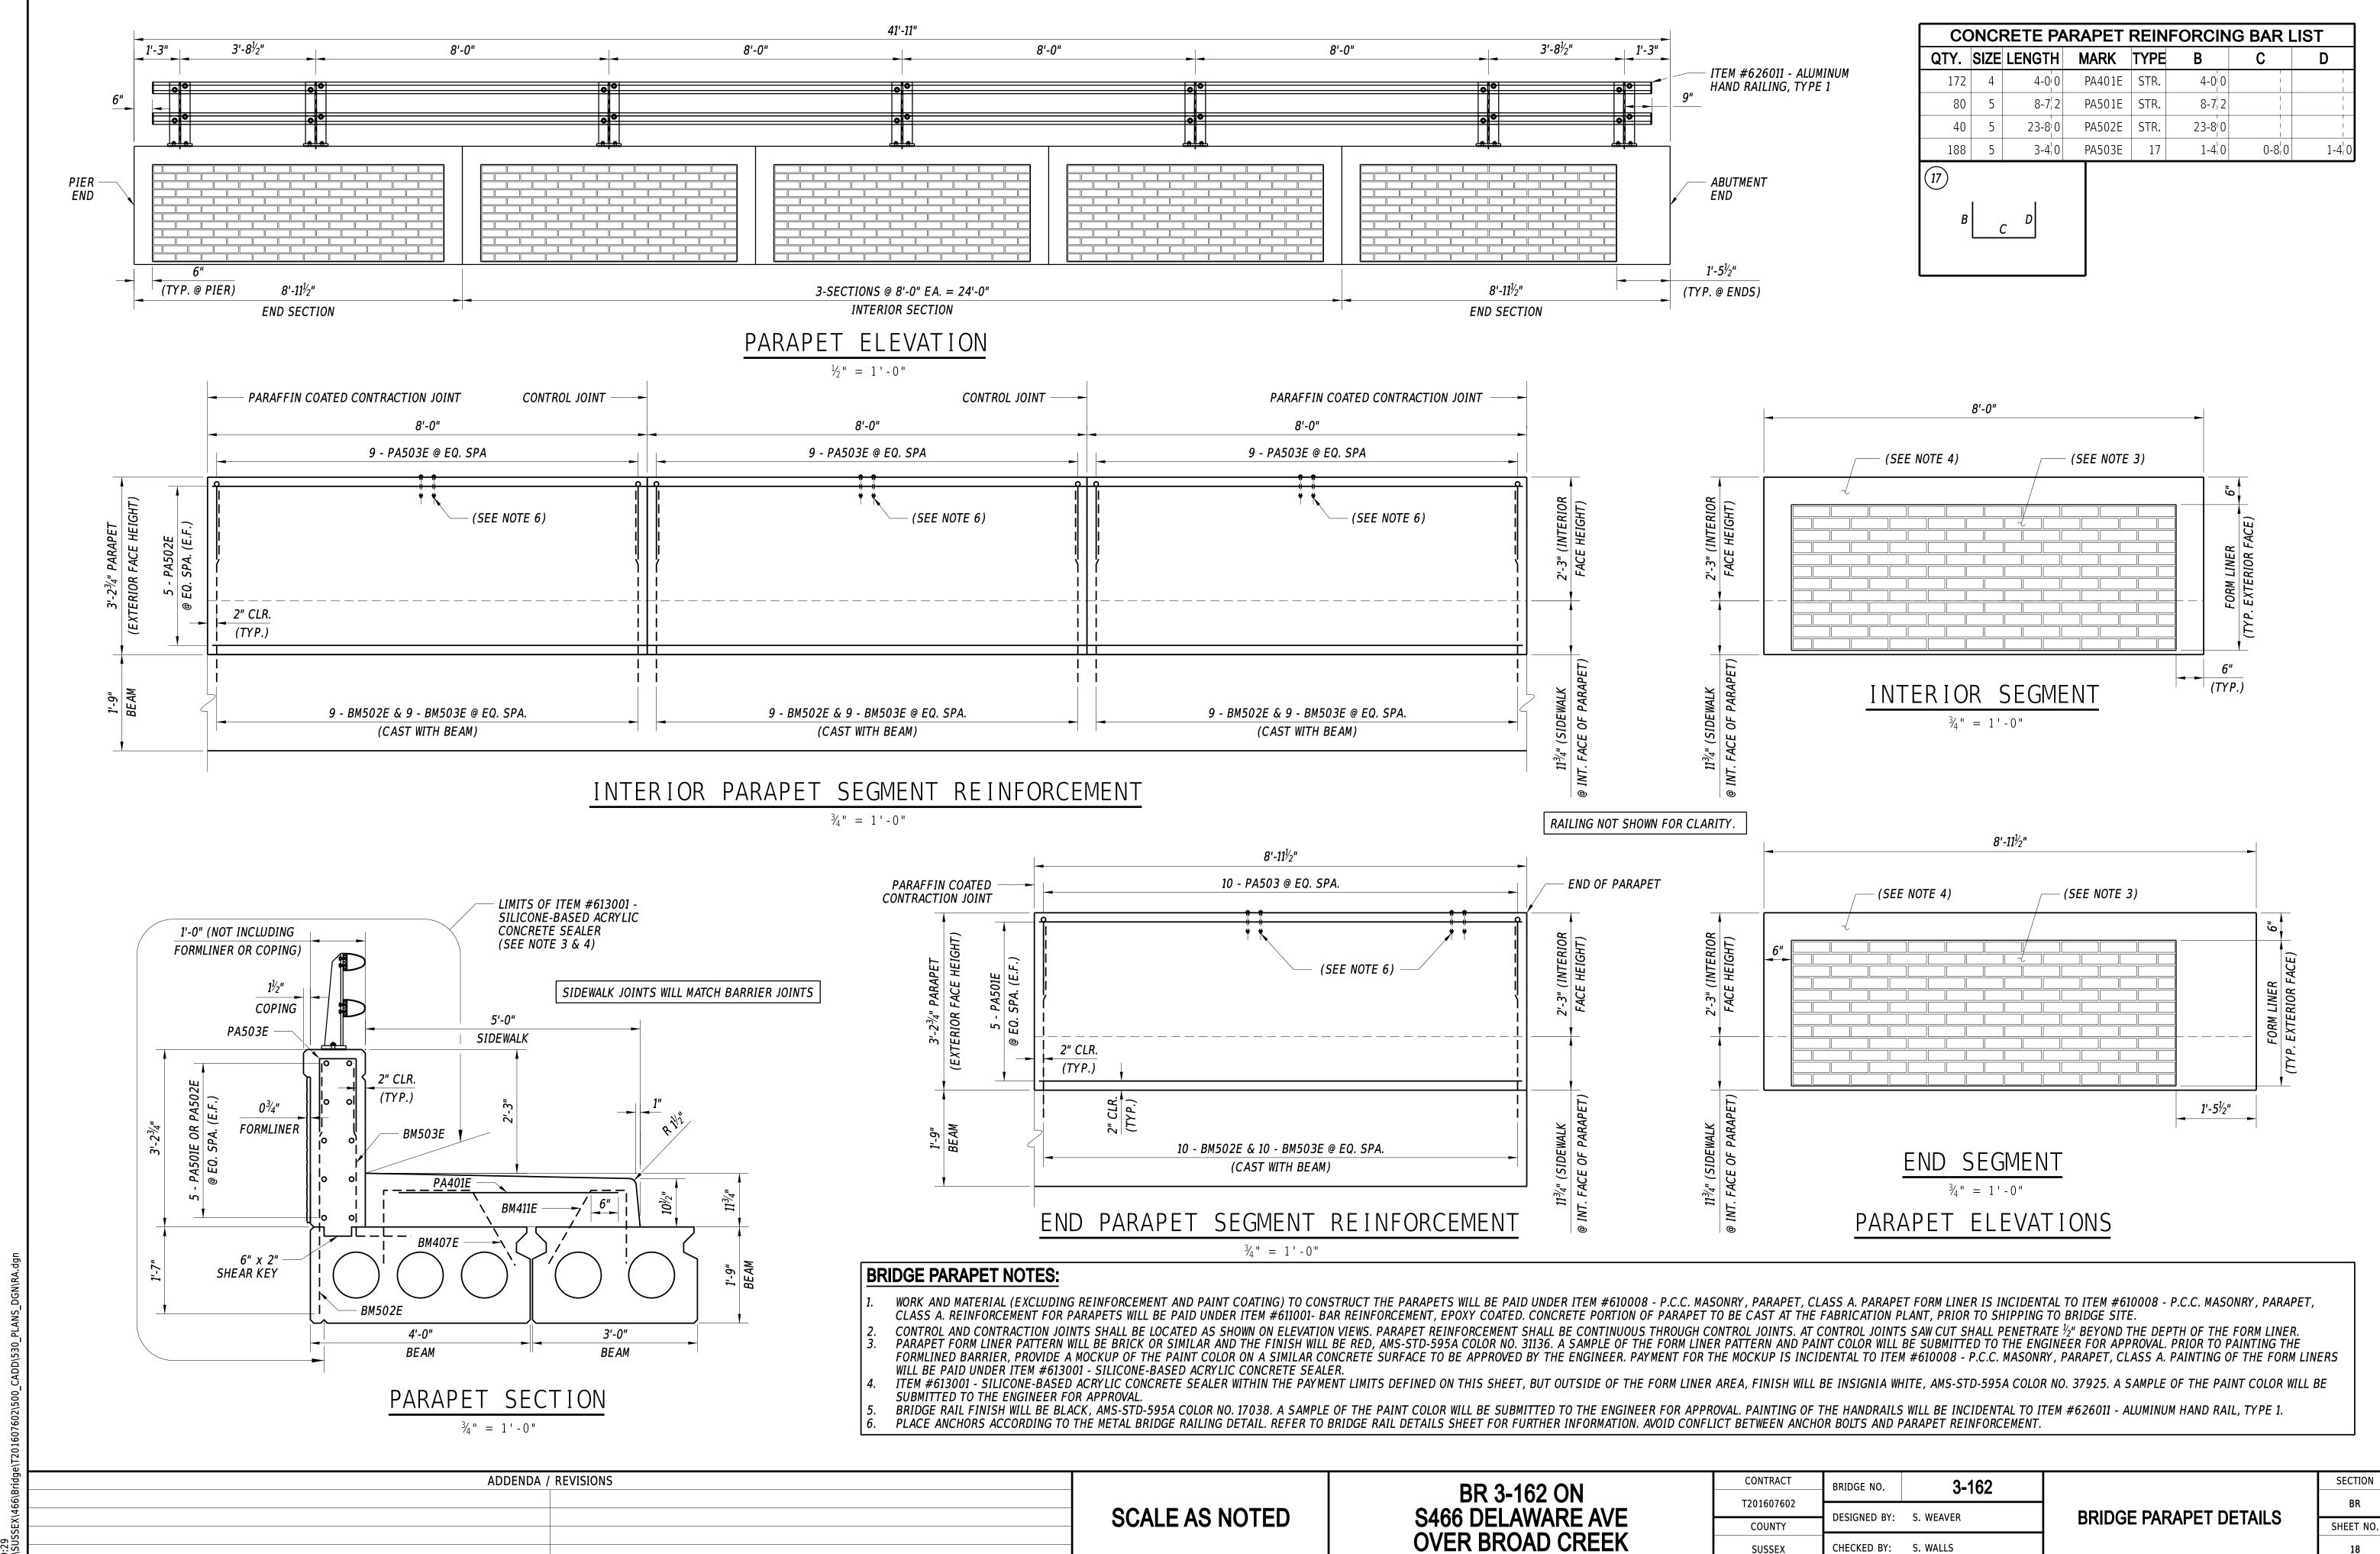
DENOTES AREA TO REMOVED UNDER ITEM
#211000 - REMOVAL OF STRUCTURES AND
OBSTRUCTIONS




TYPICAL DEMOLITION OVER ABUTMENT PHASE 1

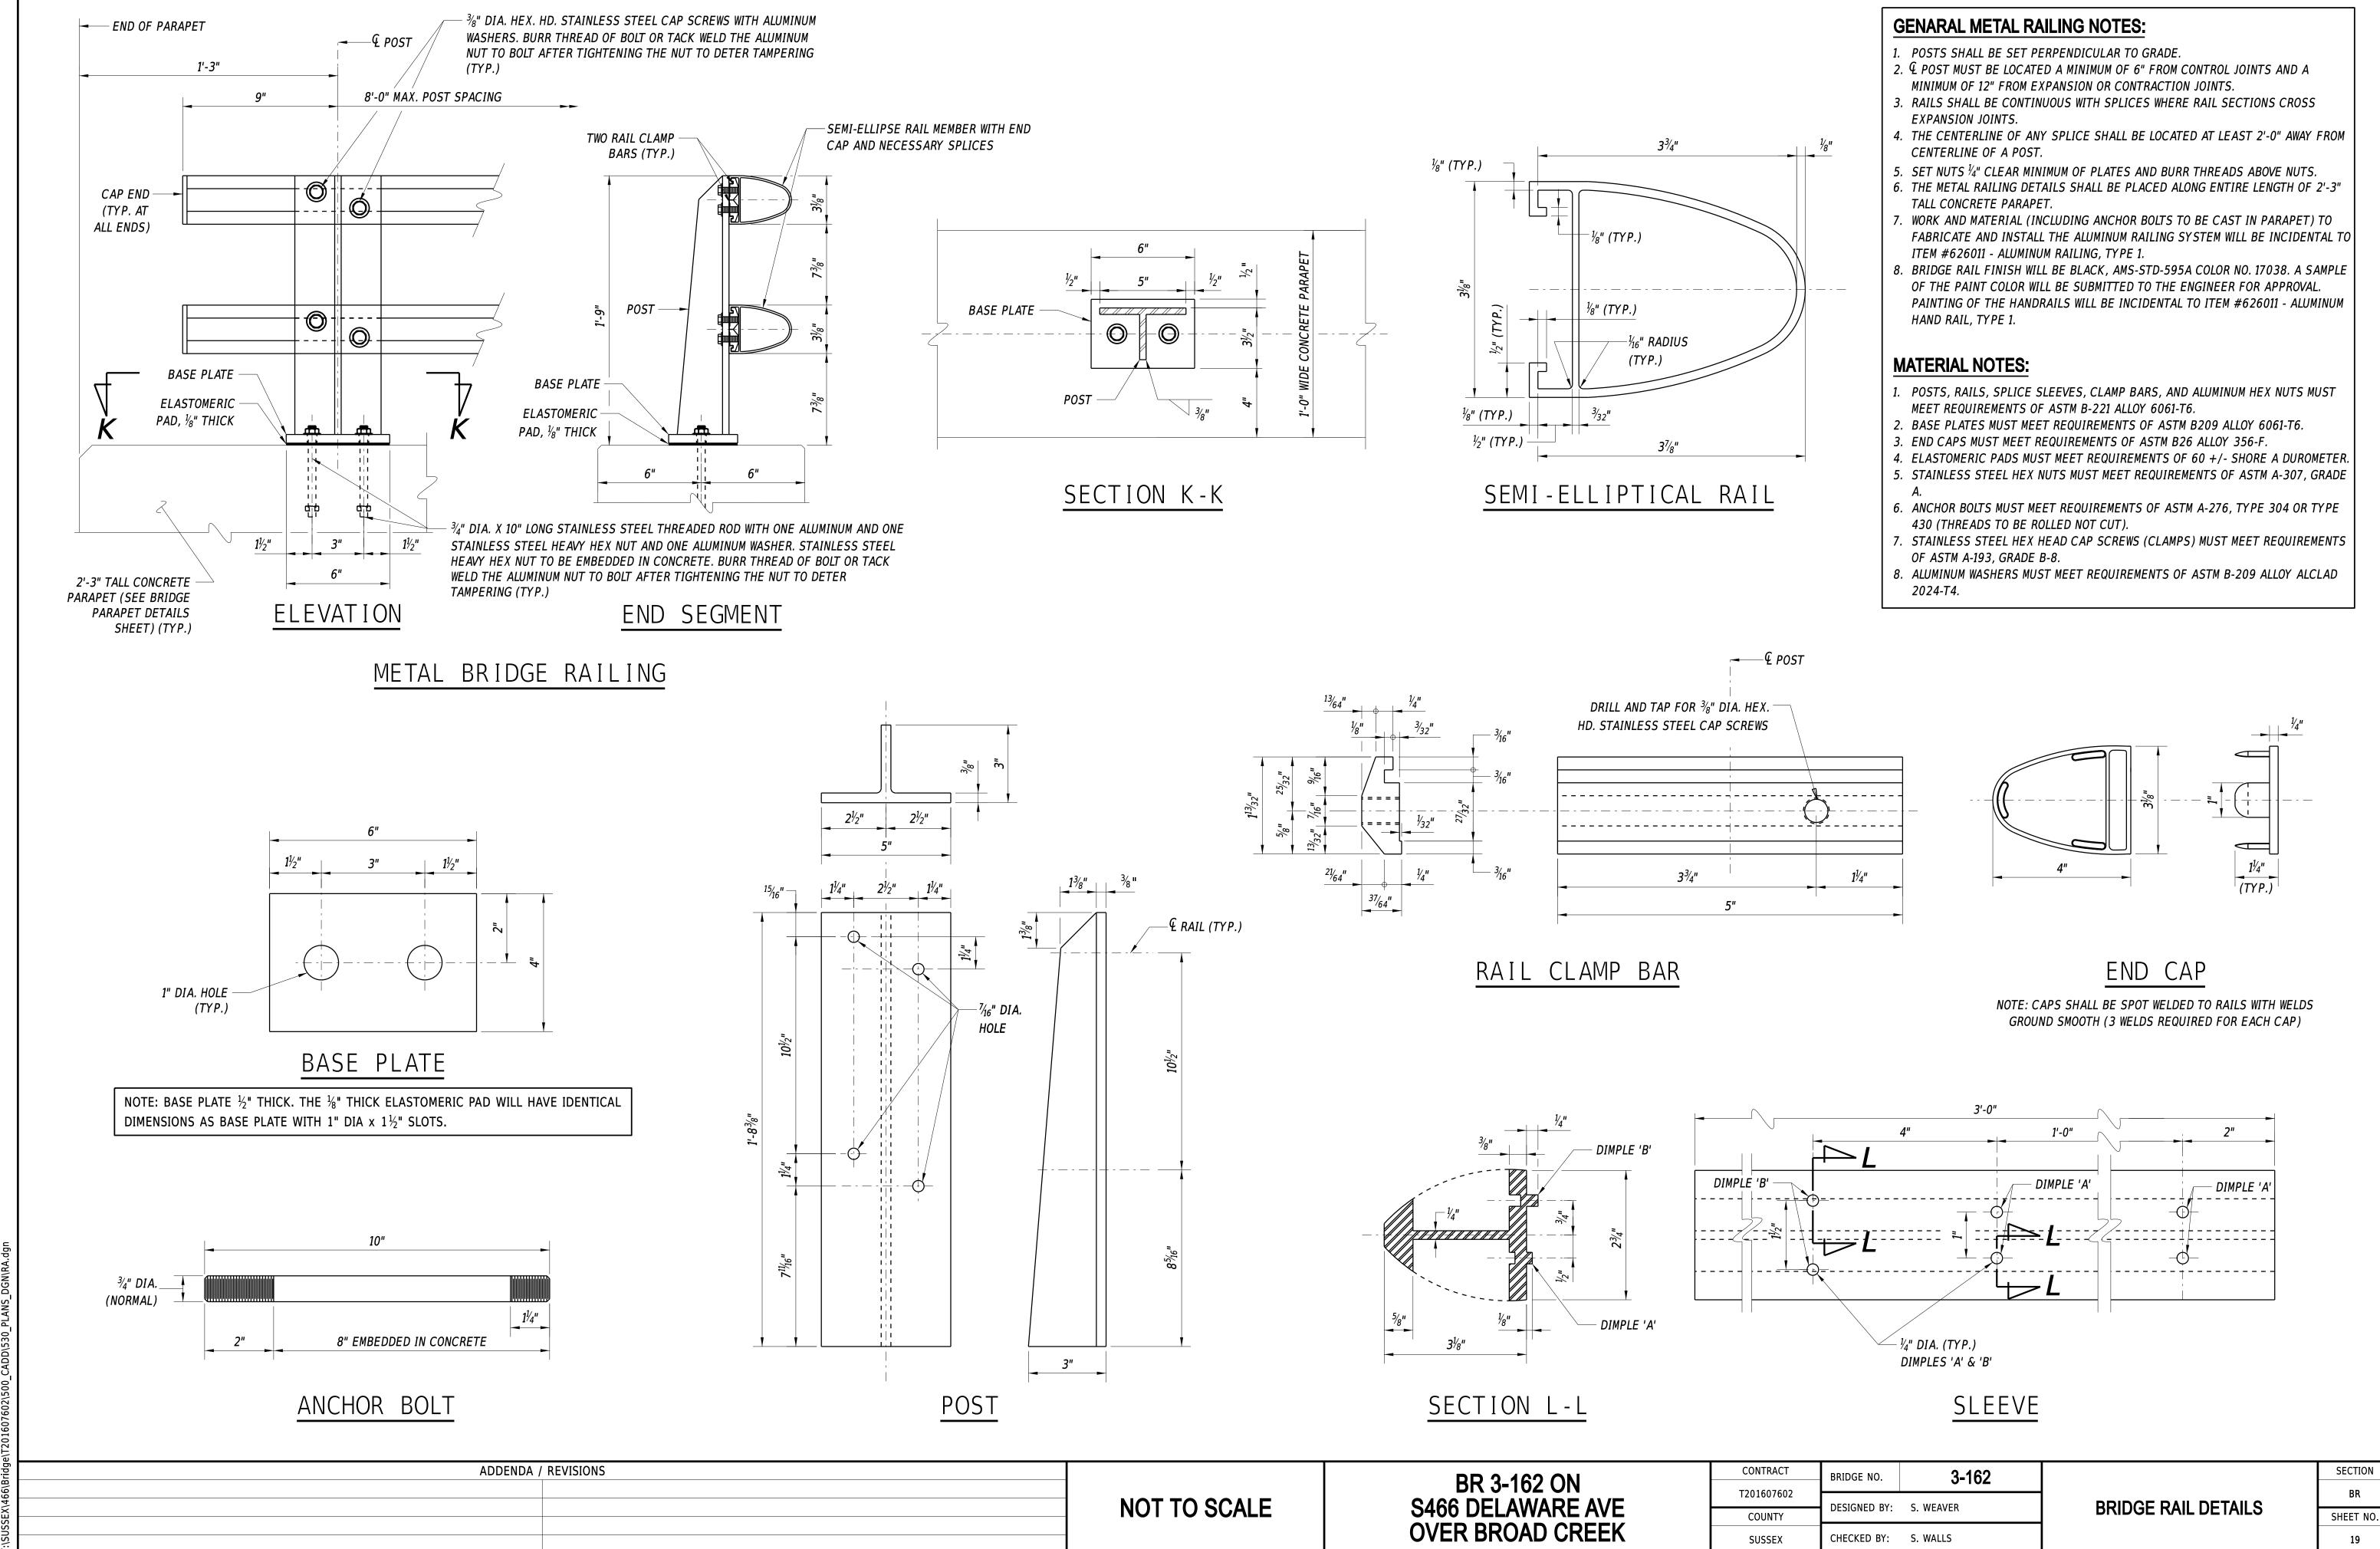

TYPICAL DEMOLITION OVER PILE BENT PHASE

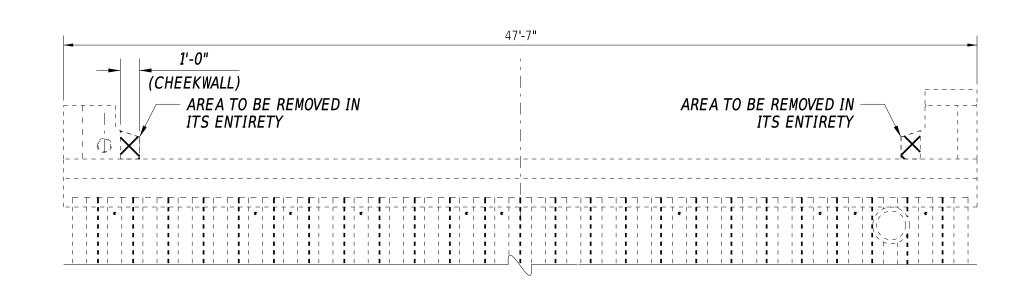

TYPICAL DEMOLITION OF ABUTMENT PHASE 2

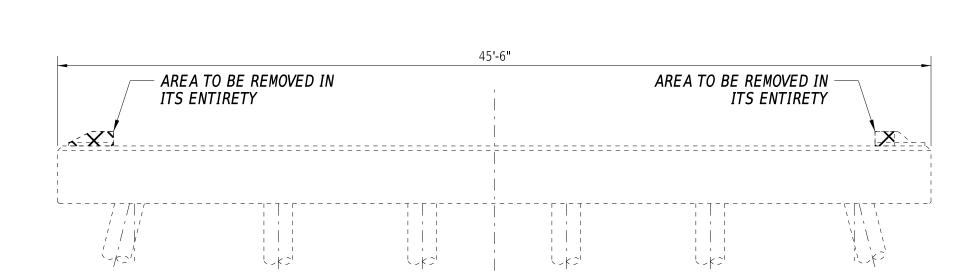

TYPICAL DEMOLITION OF PILE BENT PHASE 2

EROSION NOTES:


- 1. THE DISTURBED AREA FOR THIS PROJECT IS 0.0213 ACRES.
- 2. THE ADDITIONAL IMPERVIOUS AREA FOR THIS PROJECT IS 0.00 SQUARE FEET.
- 3. THE SEDIMENT AND STORMWATER MANAGEMENT PLANS HAVE BEEN APPROVED BY DELDOT'S STORMWATER ENGINEER UNDER DELDOT'S DELEGATED AUTHORITY. THE SEDIMENT AND STORMWATER MANAGEMENT PLANS ARE VALID FOR A FIVE YEAR PERIOD, BEGINNING ON THE DATE THE STORMWATER ENGINEER SIGNED THE CONSTRUCTION SEQUENCE SHEET. IF THE FINAL ACCEPTANCE OF THE PROJECT IS ANTICIPATED TO EXTEND BEYOND THE FIVE YEARS, THE CONTRACTOR WILL INFORM THE ENGINEER THREE MONTHS PRIOR TO THE EXPIRATION OF THE APPROVED SEDIMENT AND STORMWATER MANAGEMENT PLANS. THE STORMWATER ENGINEER WILL REVIEW THE CURRENT SEDIMENT AND STORMWATER MANAGEMENT PLAN AND ISSUE AN EXTENSION WITH ANY APPROPRIATE MODIFICATIONS.

1.	EROSION POTENTIAL FOR THIS PROJECT	CONTRACTOR EROSION AND SEDIMENT CONTROL SUPERVISOR REQUIREMENT
	() INSIGNIFICANT	NONE
	() MINOR	CONTRACTOR TRAINING PROGRAM, AS DEFINED IN SECTION 6.2 OF THE DELAWARE SEDIMENT AND STORMWATER REGULATIONS.
	(X) MAJOR	CERTIFIED CONSTRUCTION REVIEWER (CCR), AS DEFINED IN SECTION 6.3 OF THE DELAWARE SEDIMENT AND STORMWATER REGULATIONS.


ATTSA REQUIREMENTS:

1. AMERICAN TRAFFIC SAFETY SERVICES ASSOCIATION (ATSSA) CERTIFIED TRAFFIC CONTROL SUPERVISOR REQUIREMENT FOR THIS PROJECT.

(X)	THE CONTRACTOR SHALL NOT BE REQUIRED TO HAVE AN ATSSA SUPERVISOR ASSIGNED TO THIS PROJECT.
()	THE CONTRACTOR SHALL HAVE AN ATSSA SUPERVISOR ASSIGNED TO THIS PROJECT. THE CONTRACTOR'S GENERAL SUPERINTENDENT FOR THIS PROJECT OR ANOTHER ATSSA CERTIFIED MEMBER OF THE CONTRACTOR'S PROJECT STAFF MAY BE THE ATSSA SUPERVISOR. PAYMENT FOR ATSSA SUPERVISOR IS INCIDENTAL TO ITEM 801000.

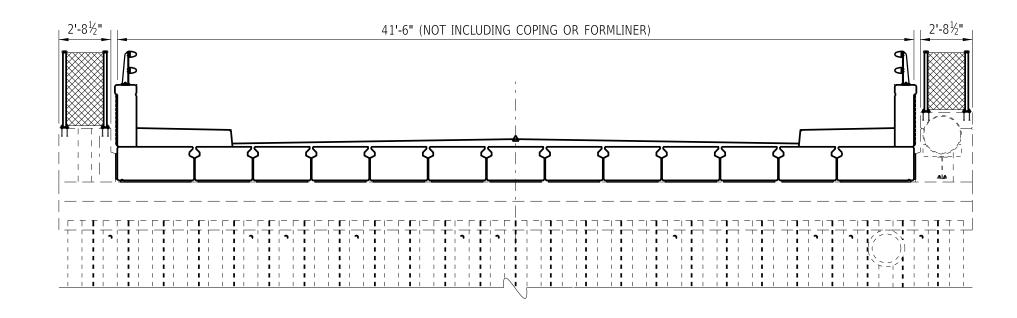

PROPOSED SECTION OVER ABUTMNET

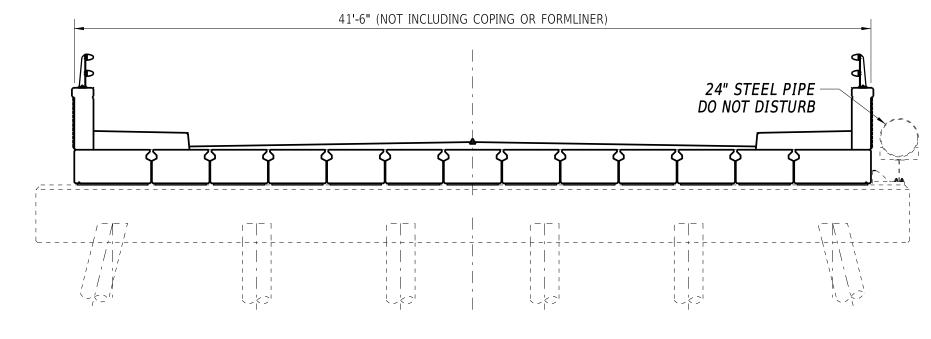

PROPOSED SECTION OVER PILE BENT

SEQUENCE OF CONSTRUCTION:

PHASE 1:

- CLOSE DELAWARE AVE IN ACCORDANCE WITH THE APPROVED VEHICULAR AND PEDESTRIAN DETOUR PLANS.
- 2. INSTALL E&S DEVICES IN ACCORDANCE WITH THE STANDARD SPECIFICATIONS AND THE EROSION AND SEDIMENT CONTROL PLAN.
 3. SAW CUT AND EXCAVATE BETWEEN STA. 3+95 AND 3+99 AS INDICATED ON THE CONSTRUCTION PLAN SHEET. INSTALL TWO (2) 2" PVC CONDUIT AND TWO (2) 4" PVC CONDUITS, PAID UNDER ITEM #831513 FURNISH AND INSTALL 2" SCHEDULE 80 PVC CONDUIT (TRENCH) RESPECTIVELY. CONDUIT SHALL BE INSTALLED FROM UP# 47750 00168 TO UP# 47749 00169. INCIDENTAL TO THE PAY ITEMS #831513 AND #831516 ARE A 90° ELBOW AT EACH POLE FOR EACH RUN, AN ADDITIONAL 8' OF CONDUIT EXTENDING UP THE UTILITY HARDWARE TO SECURE THE PIPE TO THE POLES, AND BACKFILL REQUIRED UP TO THE BOTTOM ELEVATION OF PROPOSED ROADWAY. REFER TO TYPICAL SECTIONS SHEET FOR FURTHER GUIDANCE REGARDING PROPOSED ROADWAY. CONTRACTOR WILL SUPPLY AND INSTALL 1500LB TEST PULL ROPE THROUGH CONDUITS FOR OVERHEAD ELECTRICAL UTILITY RELOCATION. ONCE CONDUIT AND WIRES ARE IN PLACE UTILITY OWNER WILL CONNECT TO EXISTING SERVICES.
- 1. REMOVE ABANDONED WATER LINE ON WEST SIDE OF STRUCTURE AND CAP EXISTING PIPE ENDS.
- 5. REMOVE EXISTING SUPERSTRUCTURE TO INCLUDE HOT-MIX SURFACE, SIDEWALK, METAL RAIL, BARRIERS, VOIDED SLAB BEAMS, BEARING PADS AND APPROACH SLABS.

PHASE 2:

- 6. IN WATER WORK TO INCLUDE INSTALLATION AND REMOVAL OF COFFERDAMS, CONCRETE REPAIRS TO THE PIERS AND/OR ABUTMENTS, ANY RIPRAP PLACEMENT, MUST OCCUR FROM 7/2 TO 8/14. INSTALLATION OF SHEETPILES WITH VIBRATORY HAMMER WILL NOT BE ALLOWED AT ANY TIME OF YEAR. REFER TO ENVIRONMENTAL COMPLIANCE NOTES SHEET FOR FURTHER INFORMATION REGARDING TIME OF YEAR RESTRICTIONS ASSOCIATED WITH FISHERIES AND MIGRATORY BIRDS.
- . FILL HOLE IN CHEEKWALL WHERE EXISTING WATER LINE PROTRUDED WITH HIGH-STRENGTH NON-SHRINK GROUT, INCIDENTAL TO ITEM #610506 - REPAIRING EXISTING PORTLAND CEMENT CONCRETE STRUCTURES.
- 8. SAW CUT AND REMOVE PART OF CHEEKWALL ON BOTH ABUTMENTS TO ACCOMMODATE PROPOSED STRUCTURE.
- 9. INSTALL COFFERDAMS AS NEEDED. VERIFY AND DO NOT DISTURB LOCATION OF UNDERGROUND UTILITIES. 10. SAW CUT AND REMOVE ARCHITECTURAL DETAIL ON TOP OF PILE BENT AS INDICATED ON EAST AND WEST ENDS.
- 11. CLEAN PILE BENT WITH PRESSURE WASH, SEAL CRACKS, MATCH MORTAR, REPAIR DEEP AND SHALLOW SPALLS ON PILE BENT, AND
- APPLY EPOXY CONCRETE SEALER. REFER TO PILE BENT DETAILS FOR FURTHER GUIDANCE.
 2. CLEAN ABUTMENTS WITH PRESSURE WASH, SEAL CRACKS, MATCH MORTAR, REPAIR DEEP AND SHALLOW SPALLS ON ABUTMENTS,
- 2. CLEAN ABUTMENTS WITH PRESSURE WASH, SEAL CRACKS, MAICH MORTAK, REPAIR DEEP AND SHALLOW SPALLS ON ABUTMENT AND APPLY EPOXY CONCRETE SEALER. REFER TO ABUTMENT DETAILS FOR FURTHER GUIDANCE.
- 13. REMOVE COFFERDAMS WHEN SUBSTRUCTURE REPAIRS ARE COMPLETE.

SUPERSTRUCTURE REPLACEMENT:

- 14. INSTALL NEW BEARING PADS AND ERECT PROPOSED PRESTRESSED CONCRETE BEAMS WITH CONCRETE PORTION OF THE PARAPET ATTACHED TO EXTERIOR BEAMS. REFER TO EXTERIOR BEAM DETAILS, INTERIOR BEAM DETAILS, AND FRAMING PLAN FOR FURTHER GUIDANCE.
- 15. CONSTRUCT PROPOSED BACKWALL ON EACH ABUTMENT AND FILL SHEAR KEY VOIDS WITH UHPC.
- 16. APPLY WATERPROOFING MEMBRANE OVER PRESTRESSED BOX BEAMS AND BACKWALL AND ALONG INTERFACE OF BACKWALL AND EXISTING ABUTMENT.
- 17. CONSTRUCT CONCRETE SIDEWALKS OVER BRIDGE AND CONCRETE CURB AND SIDEWALKS APPROACHING THE BRIDGE. INSTALL METAL RAIL ON PARAPETS.
- 18. INSTALL RECTANGULAR RAPID FLASHING BEACON SIGNAL.
- 9. PLACE FILL BEHIND ABUTMENTS, CONSTRUCT INTEGRATED BRIDGE APPROACHES, INSTALL PROPOSED P.C.C. PAVEMENT, PLACE SUPERPAVE.
- 20. COORDINATE WITH DP&L TO REINSTALL AND REENERGIZE AERIAL PRIMARY ELECTRIC OVER THE BRIDGE.
- 21. REPAIR FENCE ON PARCEL 2-R IF DISTURBED.
- 22. INSTALL BRIDGE SAFETY FENCE ON CHEEKWALLS.
- 23. REMOVE TEMPORARY EROSION AND SEDIMENT CONTROL DEVICES AFTER VEGETATION HAS STABILIZED ON ALL DISTURBED AREAS IN ACCORDANCE WITH THESE PLANS AND AS DIRECTED BY THE ENGINEER.
- 24. REMOVE ALL MOT DEVICES AND REOPEN THE ROADWAY. REMOVAL OF MOT DEVICES MAY OCCUR PRIOR TO REMOVAL OF ALL TEMPORARY EROSION AND SEDIMENT CONTROL DEVICES.

DELDOT STORMWATER ENGINEER

7/16/2020

DRMWATER ENGINEER DA

"I CERTIFY TO THE BEST OF MY KNOWLEDGE AND BELIEF THAT THESE PLANS MEET THE REQUIREMENTS OF THE DELAWARE SEDIMENT AND STORMWATER REGULATIONS AND THAT ALL CLEARING, GRADING, AND CONSTRUCTION WILL BE ACCOMPLISHED PURSUANT TO THE PLAN."

ADDENDA / REVISIONS

NOT TO SCALE

BR 3-162 ON S466 DELAWARE AVE OVER BROAD CREEK CONTRACT
T201607602
COUNTY


BRIDGE NO.

3-162
DESIGNED BY: S. WEAVER

CHECKED BY: S. WALLS

SUSSEX

CONSTRUCTION SEQUENCE AND EROSION AND SEDIMENT CONTROL NOTES BR SHEET NO.

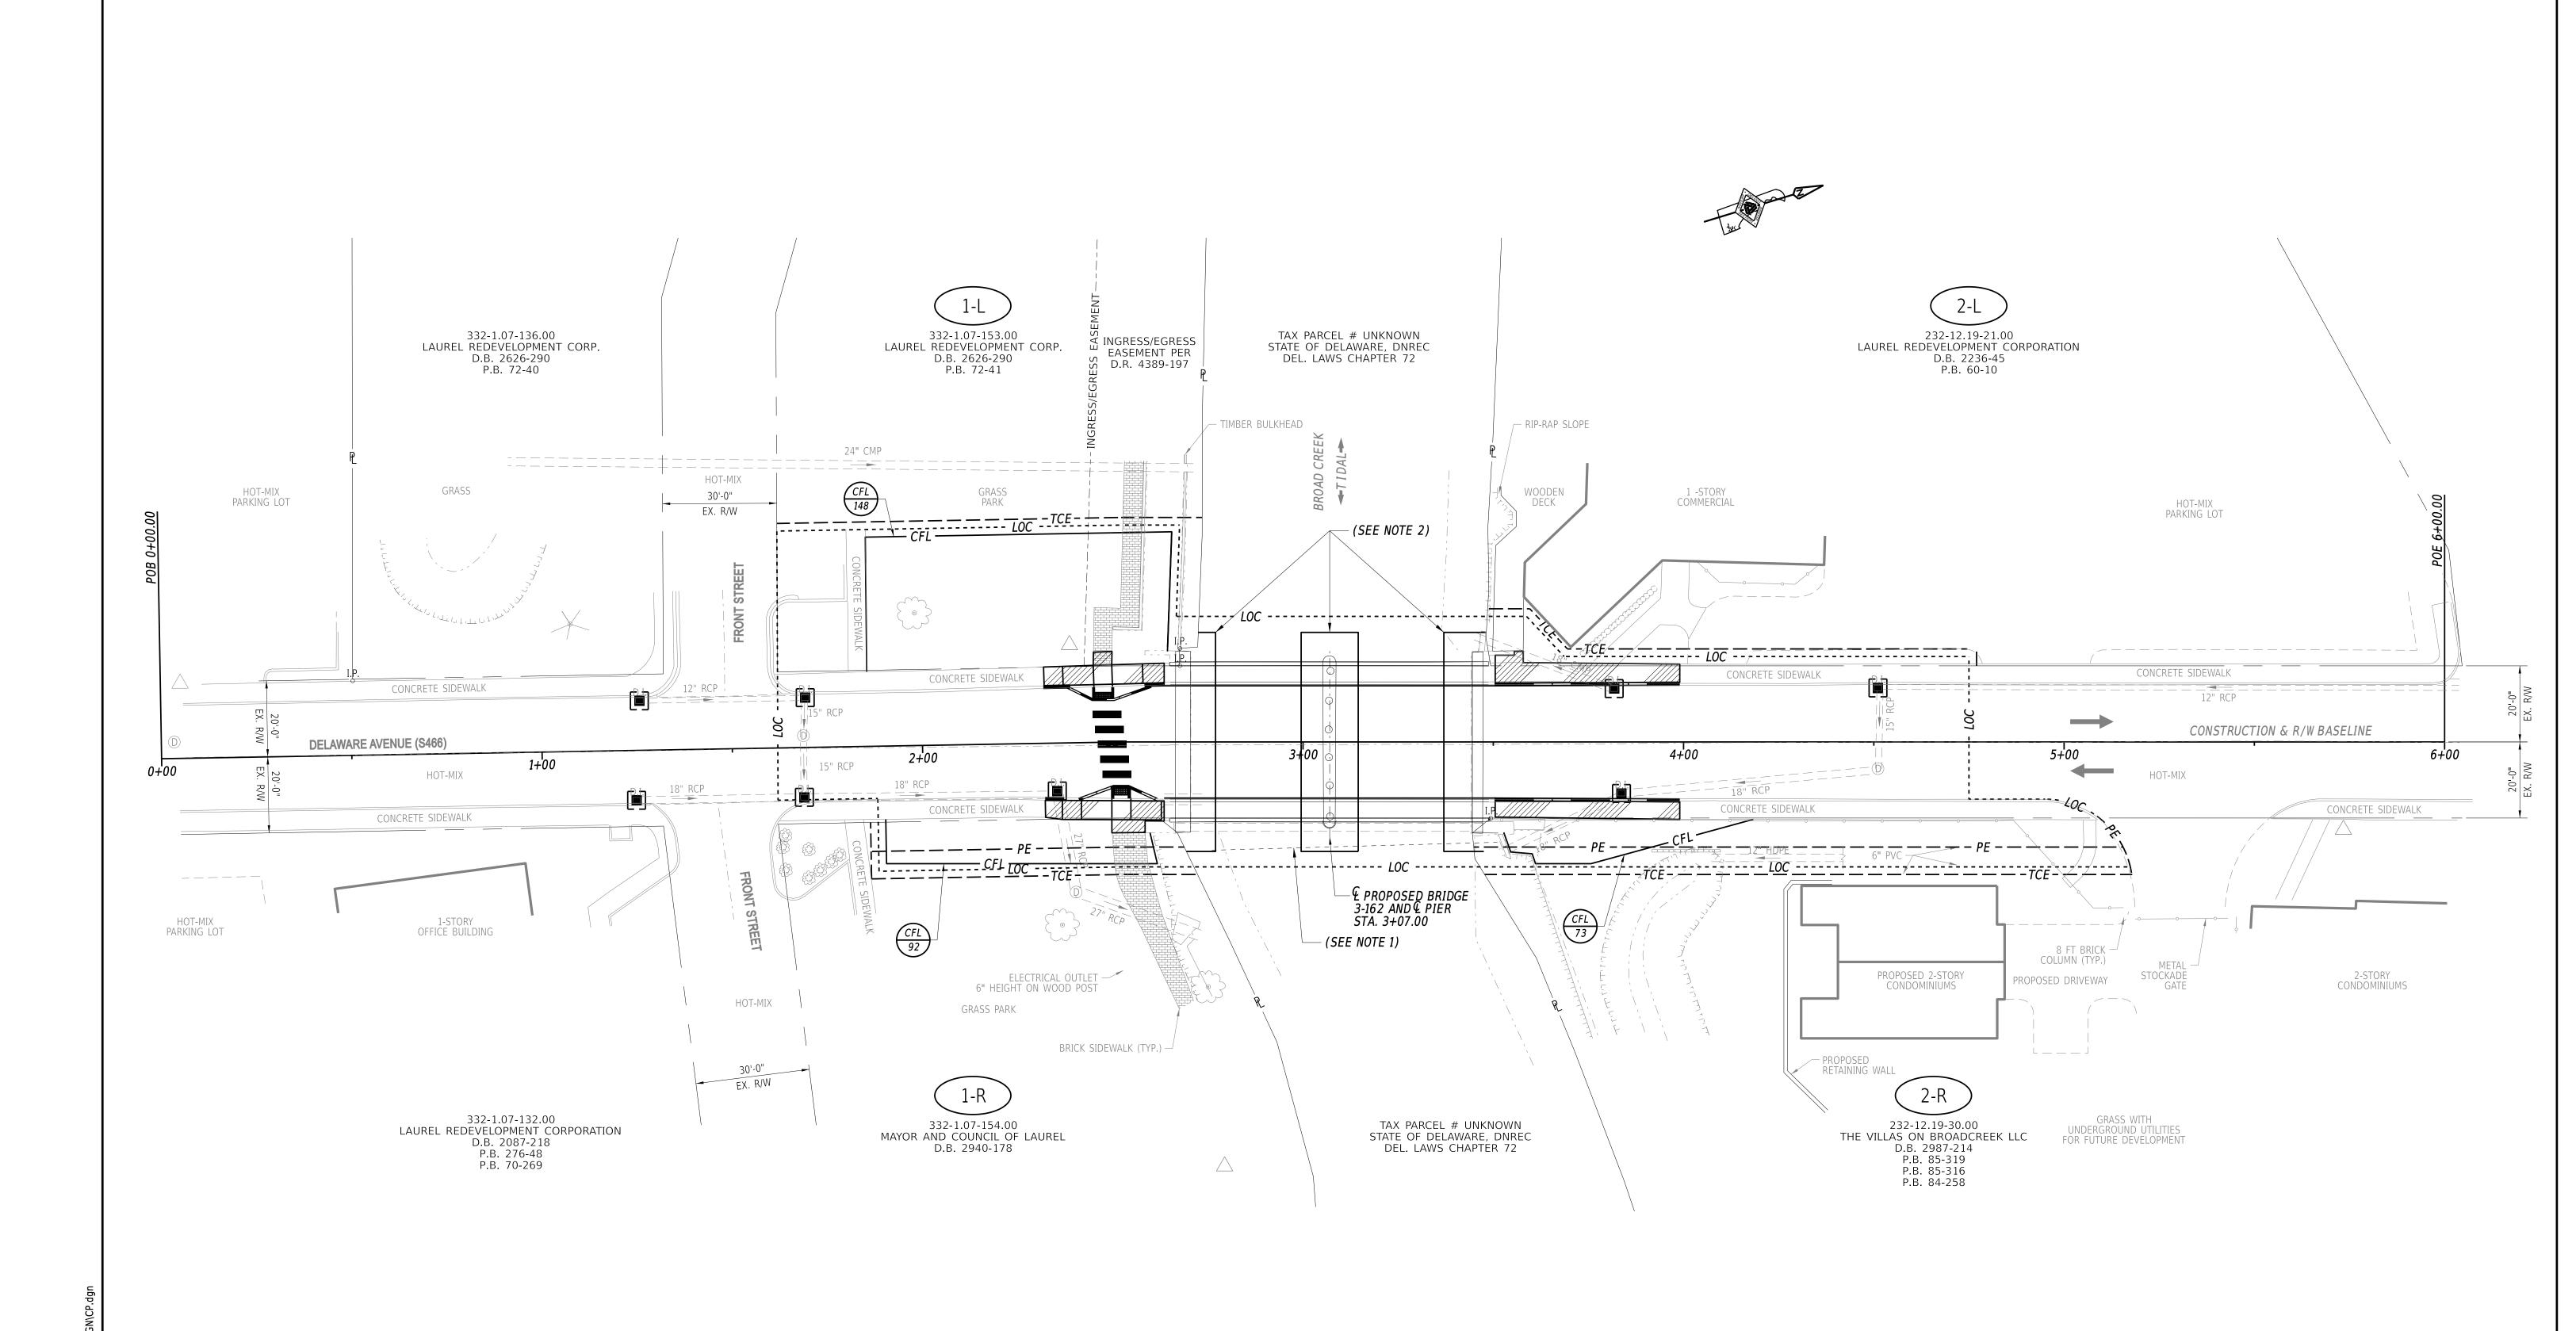

EROSION AND SEDIMENT CONTROL PLAN NOTES:

- 1. APPROXIMATE LOCATION OF UNDERGROUND GAS LINE SHOWN FOR REFERENCE ONLY. CONTRACTOR WILL VERIFY EXACT LOCATION. DO NOT DISTURB UNDERGROUND UTILITIES.
- 2. COFFERDAM TO BE DESIGNED BY CONTRACTOR IN ORDER TO MAKE REPAIRS TO SUBSTRUCTURE UNITS. LOWERING OF WATER LEVEL REQUIRED TO COMPLETE WORK INCIDENTAL TO ITEM #604002 COFFERDAMS. CONTRACTOR TO PROVIDE STAMPED PLANS FOR COFFERDAM AND DEWATERING PROCEDURE TO BE APPROVED BY ENGINEER.

ADDENDA / REVISIONS		DD 0 400 ON		BRIDGE NO.	3-162		SECTION
	SCALE	BR 3-162 ON	T201607602	J. 110 0 1 110 1	0-102	EDOCION AND CEDIMENT	RR
	0 20 40 60	S466 DELAWARE AVE	1201007002	DESIGNED BY:	S. WEAVER	EROSION AND SEDIMENT	J.
			COUNTY			CONTROL PLAN	SHEET NO.
	-	OVER BROAD CREEK	SUSSEX	CHECKED BY:	S. WALLS		21

ENVIRONMENTAL COMPLIANCE NOTES

1. GENERAL NOTES:

- A. THE PURPOSE OF THIS SHEET IS TO IDENTIFY THOSE ITEMS ASSOCIATED WITH ENVIRONMENTAL COMPLIANCE. IMPACT CALCULATIONS ARE FOR THE AGENCY PERMIT REPORTING PURPOSES ONLY AND ARE NOT TO BE USED FOR BIDDING PURPOSES.
- B. IF A DEPARTURE FROM THE APPROVED PLANS (WHICH WOULD AFFECT ANY NATURAL AND/OR CULTURAL RESOURCES) IS NECESSARY, CONTACT THE ENVIRONMENTAL STUDIES SECTION AT (302-760-2259 OR DOT_ENVIRONMENTALSTUDIES@DELAWARE.GOV) TO ALLOW FOR COORDINATION WITH THE APPROPRIATE RESOURCE AGENCIES AND APPROVAL.
- C. USE OF THIS SHEET DOES NOT ALLEVIATE THE CONTRACTOR'S RESPONSIBILITY TO COMPLY WITH ALL CONDITIONS SET FORTH IN THE ENVIRONMENTAL STATEMENT AND PERMITS.

2. NATURAL RESOURCE ISSUES:

A. PERMIT REQUIREMENTS/APPROVALS *:

U.S. ARMY CORPS OF ENGINEERS (COE): NWP 23 W/PCN DNREC - WETLANDS & SUBAQUEOUS LANDS (WLSL): SUBAQUEOUS LANDS PERMIT

DNREC - WATER QUALITY (WQC) & COASTAL ZONE CONSISTENCY (CZM): ISSUED (PROJECT IS NOT LOCATED IN CRW) US COAST GUARD (USCG): PERMIT

- * THE PERMITS/APPROVALS LISTED ARE THOSE REQUIRED FOR THIS PROJECT. THE ENVIRONMENTAL STUDIES SECTION IS RESPONSIBLE FOR COORDINATING AND/OR OBTAINING THESE APPROVALS.
- ** THE CONTRACTOR MUST ENSURE THAT THESE PERMITS/APPROVALS ARE IN THEIR POSSESSION PRIOR TO BEGINNING CONSTRUCTION IN THE PERMITTED AREA(S) AND ENSURE THEY ARE DISPLAYED ON-SITE DURING THE ENTIRE CONSTRUCTION PERIOD.
- B. CONSTRUCTION RESTRICTIONS:

FISHERIES - NO INSTREAM WORK TO BE PERFORMED FROM MARCH 1ST TO JULY 1ST AND FROM AUGUST 15TH TO NOVEMBER 1ST DUE TO THE PRESENCE OF ATLANTIC STURGEON AND ANADROMOUS FISH SPECIES IN BROAD CREEK. DURING THESE RESTRICTED PERIODS, WORK ABOVE THE WATERLINE MAY INCLUDE THE USE OF A BARGE OR BOAT FOR LABORERS AND SMALL EQUIPMENT (HAND TOOLS). LARGE EQUIPMENT INCLUDING CRANES MAY NOT BE STAGED FROM IN-WATER PLATFORMS DURING THE RESTRICTED PERIODS. ANY BARGES OR BOATS SHOULD NOT BE LEFT IN THE RIVER AFTER THE END OF A SHIFT, BUT REDEPLOYED DAILY TO ALLOW FOR PERIODS OF UNRESTRICTED MOVEMENT BY THE SPAWNING FISH SPECIES.

ENDANGERED SPECIES - NORTHERN LANCE MUSSELS HAVE BEEN DOCUMENTED IN BROAD CREEK IN THE VICINITY OF THE PROPOSED PROJECT. ALL EFFORTS TO DECREASE DOWNSTREAM SEDIMENTATION SHALL BE TAKEN. IN ADDITION, ANY PRESERVATIVES OR EPOXIES INJECTED IN TO THE BRIDGE STRUCTURES SHALL BE MARINE STABLE AND SHALL BE CONTAINED SO THEY DO NOT FLOW IN TO THE CREEK.

MIGRATORY BIRDS - APRIL 15TH - AUGUST 1ST (INCLUSIVE). EITHER BEGIN CONSTRUCTION ON THE ABUTMENTS AND PILE BENT PRIOR TO APRIL 15TH (TO PREVENT BIRDS FROM NESTING) OR WAIT UNTIL AFTER AUGUST 1ST (AFTER HATCHLINGS HAVE LEFT) TO BEGIN WORK ON THE ABUTMENTS AND PILE BENT. IF EITHER OF THESE OPTIONS IS NOT PRACTICABLE, THEN PRIOR TO APRIL 15TH, DETERRENT NETTING (OR SIMILAR DEVICE) SHALL BE INSTALLED. NETTING SHALL BE PAID FOR UNDER ITEM #763623 - NETTING MIGRATORY BIRD EXCLUSION.

3. CULTURAL RESOURCE ISSUES:

A. BASED ON CURRENT COORDINATION, THE PROJECT IS CLEAR FOR CULTURAL RESOURCES AND EXEMPT FROM SHPO REVIEW UNDER STIPULATION III OF DELDOT'S PROGRAMMATIC AGREEMENT WITH FEDERAL HIGHWAY ADMINISTRATION (FHWA) AND DELAWARE STATE HISTORIC PRESERVATION OFFICE (SHPO). WORK WILL OCCUR WITHIN THE BOUNDARY OF THE LAUREL HISTORIC DISTRICT, BUT NO CONTRIBUTING FEATURES WILL BE AFFECTED. THERE ARE NO CULTURAL RESOURCE CONCERNS AS LONG AS THE PROJECT SCOPE IS NOT MODIFIED AND ALL STAGING AND STOCKPILING REMAIN WITHIN THE EXISTING ROADWAY FOOTPRINT. SHOULD IT BE NECESSARY TO ADD ADDITIONAL ACCESS LOCATIONS, OTHER STOCKPILING/STAGING AREAS, OR OTHERWISE ALTER THE SCOPE OF THE PROJECT, DELDOT ENVIRONMENTAL STUDIES STAFF WILL NEED TO REVIEW THESE CHANGES FOR POTENTIAL CULTURAL RESOURCES CONCERNS.

4. STREAM RESTORATION:

A. RESTORE OTHER AREAS OF THE CHANNEL BOTTOM AFFECTED BY CONSTRUCTION (INCLUDING, BUT NOT LIMITED TO, THE LOCATION OF SUMP PITS, STABILIZED OUTFALLS, TEMPORARY PIPES AND/OR SANDBAG DIKES AND DIVERSIONS) TO EXISTING CONDITIONS. FILL ANY CAVITIES OR SCOUR HOLES RESULTING FROM CONSTRUCTION ACTIVITIES WITH CHANNEL BED FILL. PAYMENT INCIDENTAL TO ITEM #604002 - COFFERDAMS.

5. PROTECTION OF RESOURCES:


- A. TO PROTECT AQUATIC SPECIES (INCLUDING EGGS) FROM IMPINGEMENT AND/OR ENTRAINMENT, TEMPORARY INTAKES RELATED TO CONSTRUCTION OCCURRING FROM MARCH 1ST TO OCTOBER 31ST MUST BE QUIPPED WITH 2 MILLIMETER (MM) WEDGE WIRE SCREENS WITH A MAXIMUM INTAKE VELOCITY OF 0.5 FEET PER SECOND (FT/SEC). PAYMENT FOR THE SCREENS WILL BE INCIDENTAL TO ITEM #604002 COFFERDAMS. CONTRACTOR MAY CHOOSE FROM ANY OF THE FOLLOWING APPROVED PRODUCTS, AND ALTERNATIVE PRODUCTS WILL NOT BE CONSIDERED:
 - LAKOS FILTRATION SOLUTIONS: PC-SELF CLEANING INTAKE SCREEN (HTTPS://WWW.LAKOS.COM/PRODUCT/PC-SERIES-SELF-CLEANING-INTAKE-SCREEN/)
 - FEDERAL SCREEN PRODUCTS INC. INTAKE SCREEN
 - HTTPS://WWW.FEDERALSCREEN.COM/INTAKE-SCREENS)
 - HENDRICK SCREEN COMPANY: PASSIVE WATER INTAKE WEDGE WIRE SCREENS
 - (HTTPS://WWW.HENDRICKCORP.COM/SCREEN/MARKETS/WATER-INTAKE-WATER-TREATMENT/)
 BIG BRAND WATER FILTER, INC: SELF-CLEANING PUMP INTAKE SCREENS PC-915
 - (HTTPS://WWW.BIGBRANDWATER.COM/SELF-CLEANING-PUMP-INTAKE-SCREENS-PC-915_P_17721.HTML)


6. U.S. COAST GUARD ADVANCED COORDINATION/APPROVAL:


THE WATERWAYS ARE USED FOR RECREATIONAL PURPOSES. THE CONTRACTOR SHALL PROVIDE SAFE PASSAGE THROUGH THE WORK AREAS FOR THE WATERWAY USERS AND SHALL HAVE THE PASSAGEWAY CLEARLY MARKED. PAYMENT IS INCLUDED UNDER PAY ITEM #763522 - COAST GUARD SPECIFIC CONDITIONS. ANY CONTRACTOR ACTIVITY, WHICH WILL RESULT IN THE SHORT-TERM RESTRICTION OF THE WATERWAYS TO THOSE INDIVIDUALS, IS TO BE COORDINATED WITH THE ENGINEER AND THE U.S. COAST GUARD 5TH COAST GUARD DISTRICT 30 DAYS IN ADVANCE, AND WITH U.S. COAST GUARD SECTOR DELAWARE BAY 60 DAYS IN ADVANCE. THE WORK WITHIN THE WATER SHALL BE LIMITED TO WHAT APPEARS ON THESE PLANS AND BARGE PLACEMENT. IF ANY ADDITIONAL IN-WATER/WETLANDS WORK IS NEEDED, IT MUST BE COORDINATED WITH U.S. COAST GUARD PRIOR TO BEGINNING WORK AND BE IN CONFORMANCE WITH ITEM #763522 - COAST GUARD SPECIFIC CONDITIONS. CONTACT MIKE THOROUGHGOOD (MICHAEL.R.THOROUGHGOOD@USCH.MIL, (757)-398-6557), AS WELL AS SUBMIT A WRITTEN NOTICE (WHICH INCLUDES A SKETCH DEPICTING THE LOCATION AND DURATION OF ALL RESTRICTIONS) TO THE COMMANDING OFFICER (AOWB), 5TH COAST GUARD DISTRICT, FEDERAL BUILDING 431 CRAWFORD ST., PORTSMOUTH, VA 23704 FOR APPROVAL 30 DAYS IN ADVANCE. CONTACT MIKE THOROUGHGOOD (MICHAEL.R.THOROUGHGOOD@USCH.MIL, (757)-398-6557), AS WELL AS SUBMIT A WRITTEN NOTICE (WHICH INCLUDES THE LOCATION OF THE PROJECT, THE TYPE OF WORK AND MEANS AND METHODS USED, AND DATES, TIMES, AND DURATION OF WATERWAYS CLOSURE) TO THE SECTOR DELAWARE BAY USCG WWM DEPARTMENT, 1 WASHINGTON AVE, PHILADELPHIA, PA 19147 FOR COORDINATION AND APPROVAL 60 DAYS IN ADVANCE.


7. A PORTION OF THE LOC EXTENDS INTO JANOSIK PARK (PARCEL 332-1.07-154.00), A PROPERTY PROTECTED UNDER SECTION 4(F)
OF THE USDOT ACT OF 1966. IF THERE ARE ANY ALTERATIONS TO THE RIGHT-OF-WAY IMPACTS ON THIS PROPERTY DETAILED IN
THESE PLANS, ALEX TARANTINO OF DELDOT ENVIRONMENTAL STUDIES MUST BE NOTIFIED AT (302) 760-4887.


ADDENDA / REVISIONS CONTRACT 3-162 BRIDGE NO. BR 3-162 ON T201607602 **ENVIRONMENTAL** S466 DELAWARE AVE NOT TO SCALE DESIGNED BY: S. WEAVER **COMPLIANCE NOTES** COUNTY SHEET NO. **OVER BROAD CREEK** CHECKED BY: S. WALLS SUSSEX 22

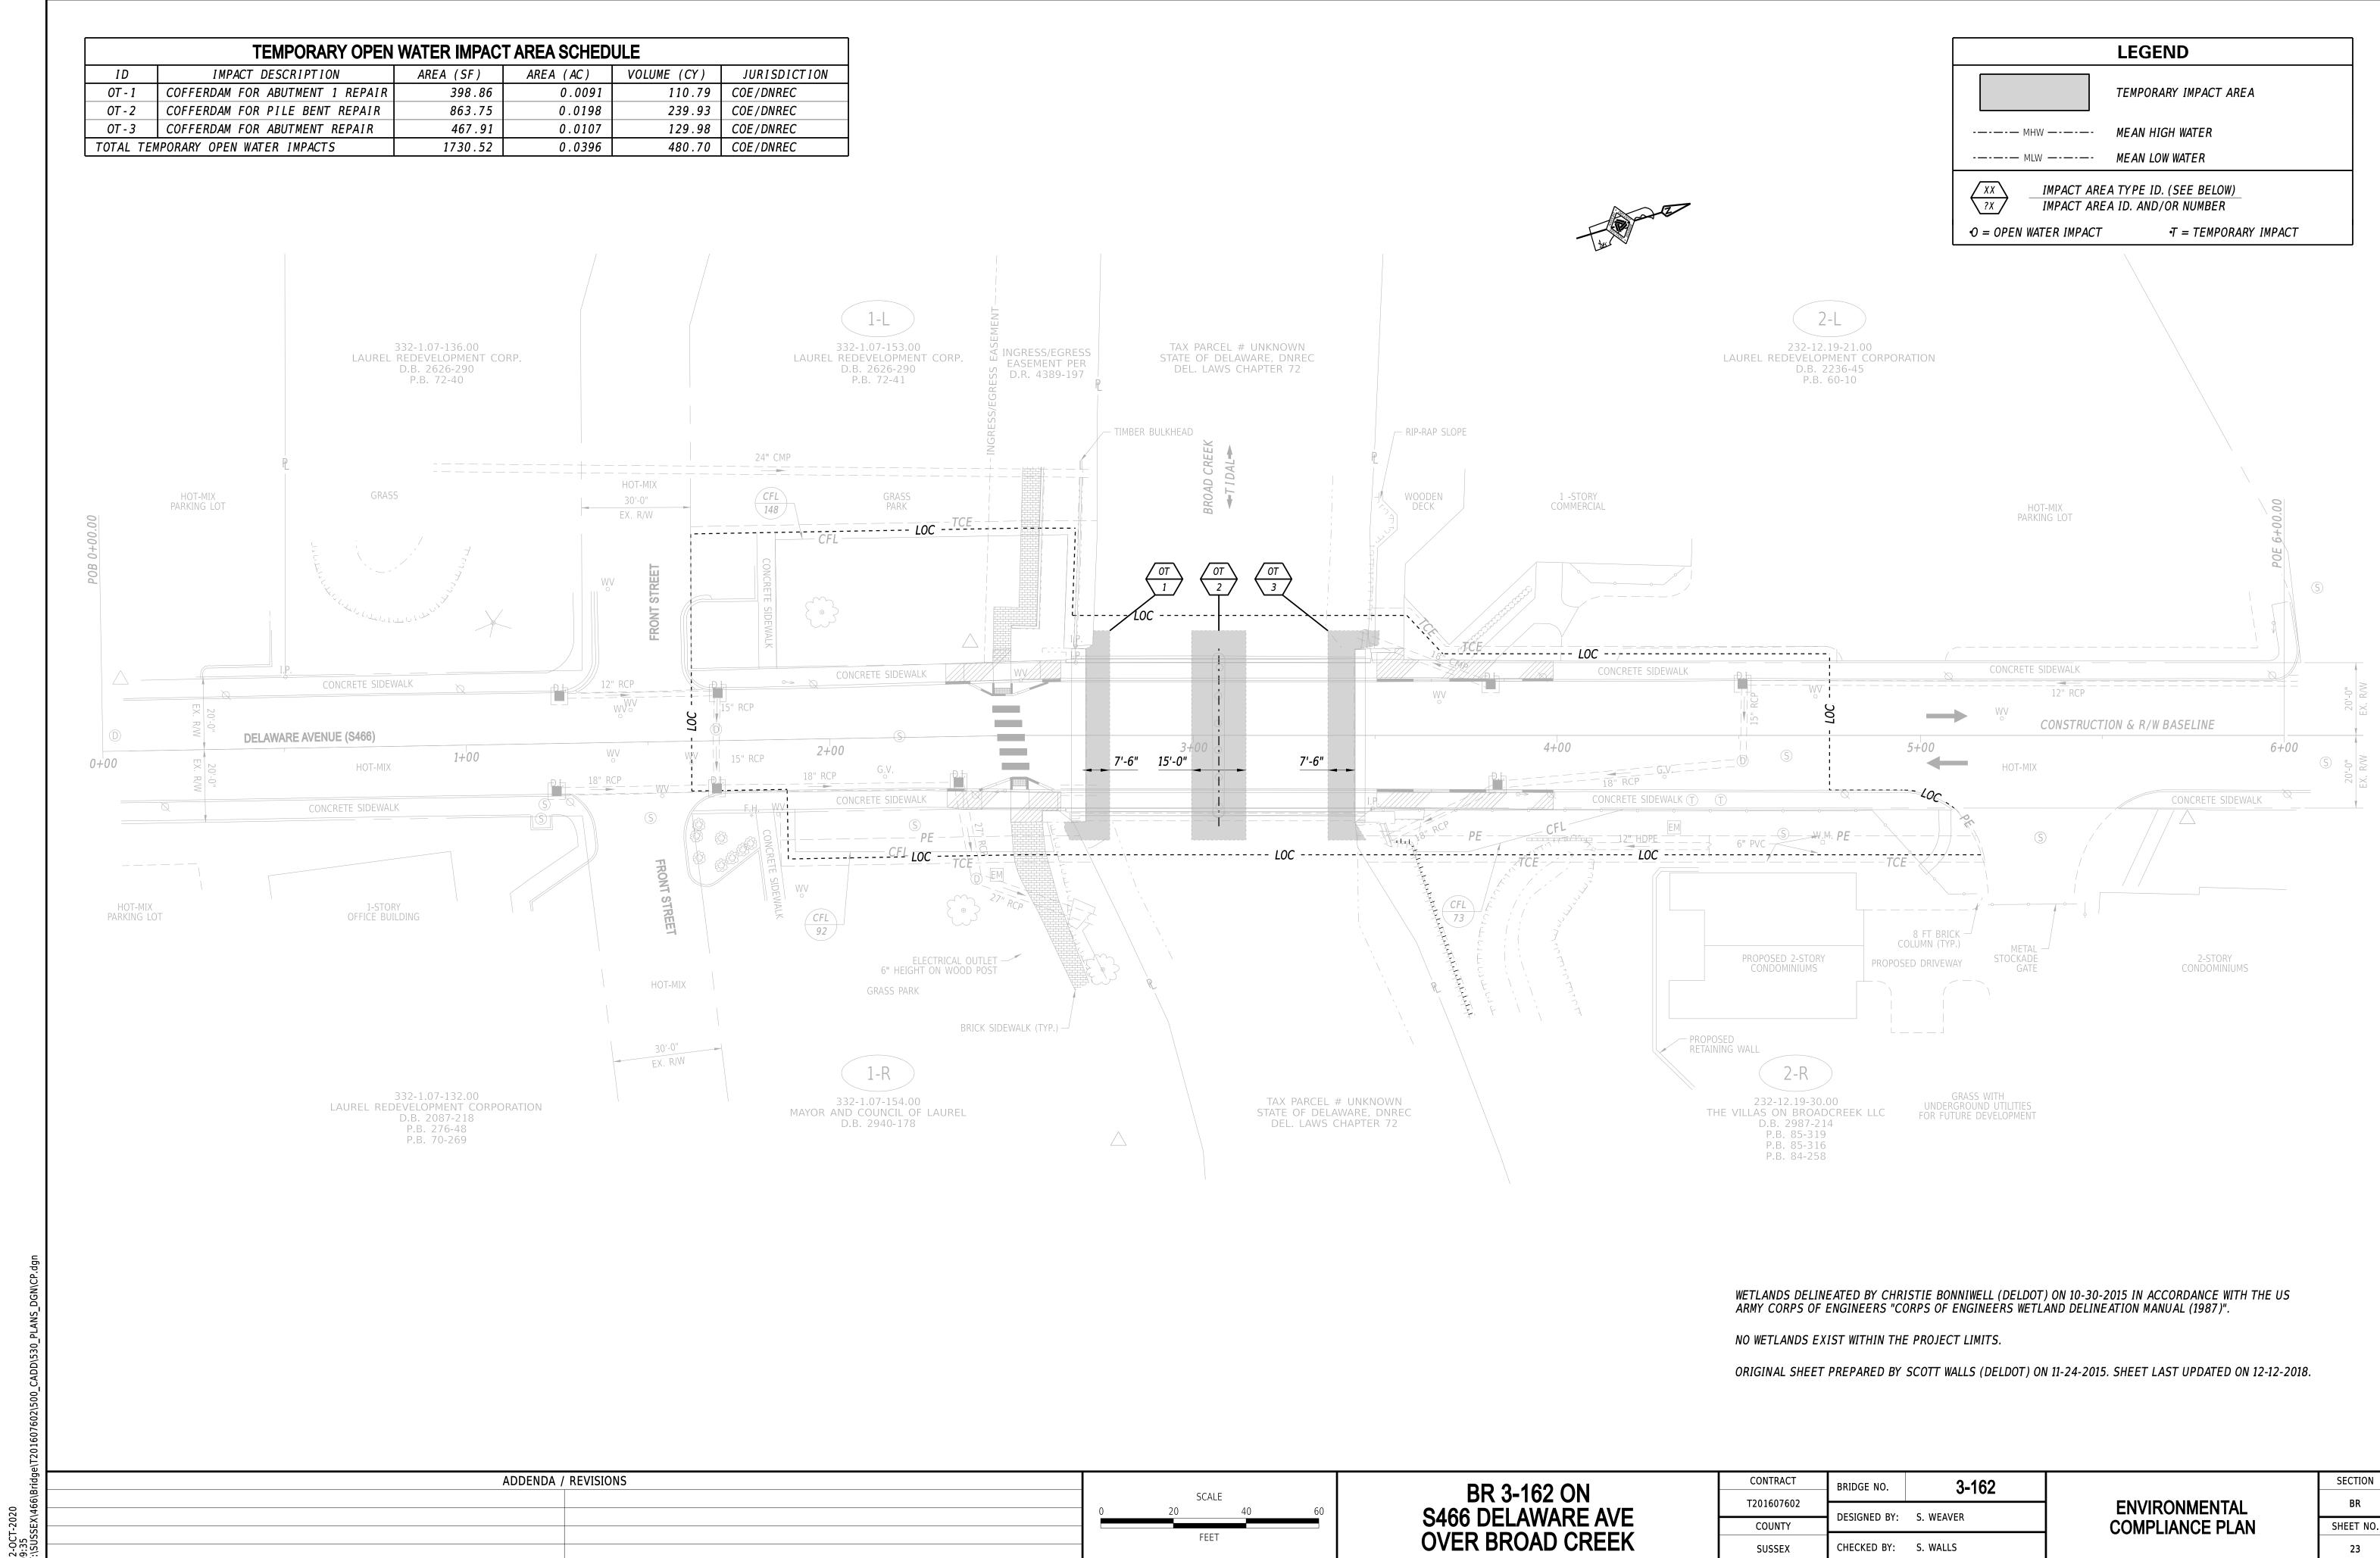

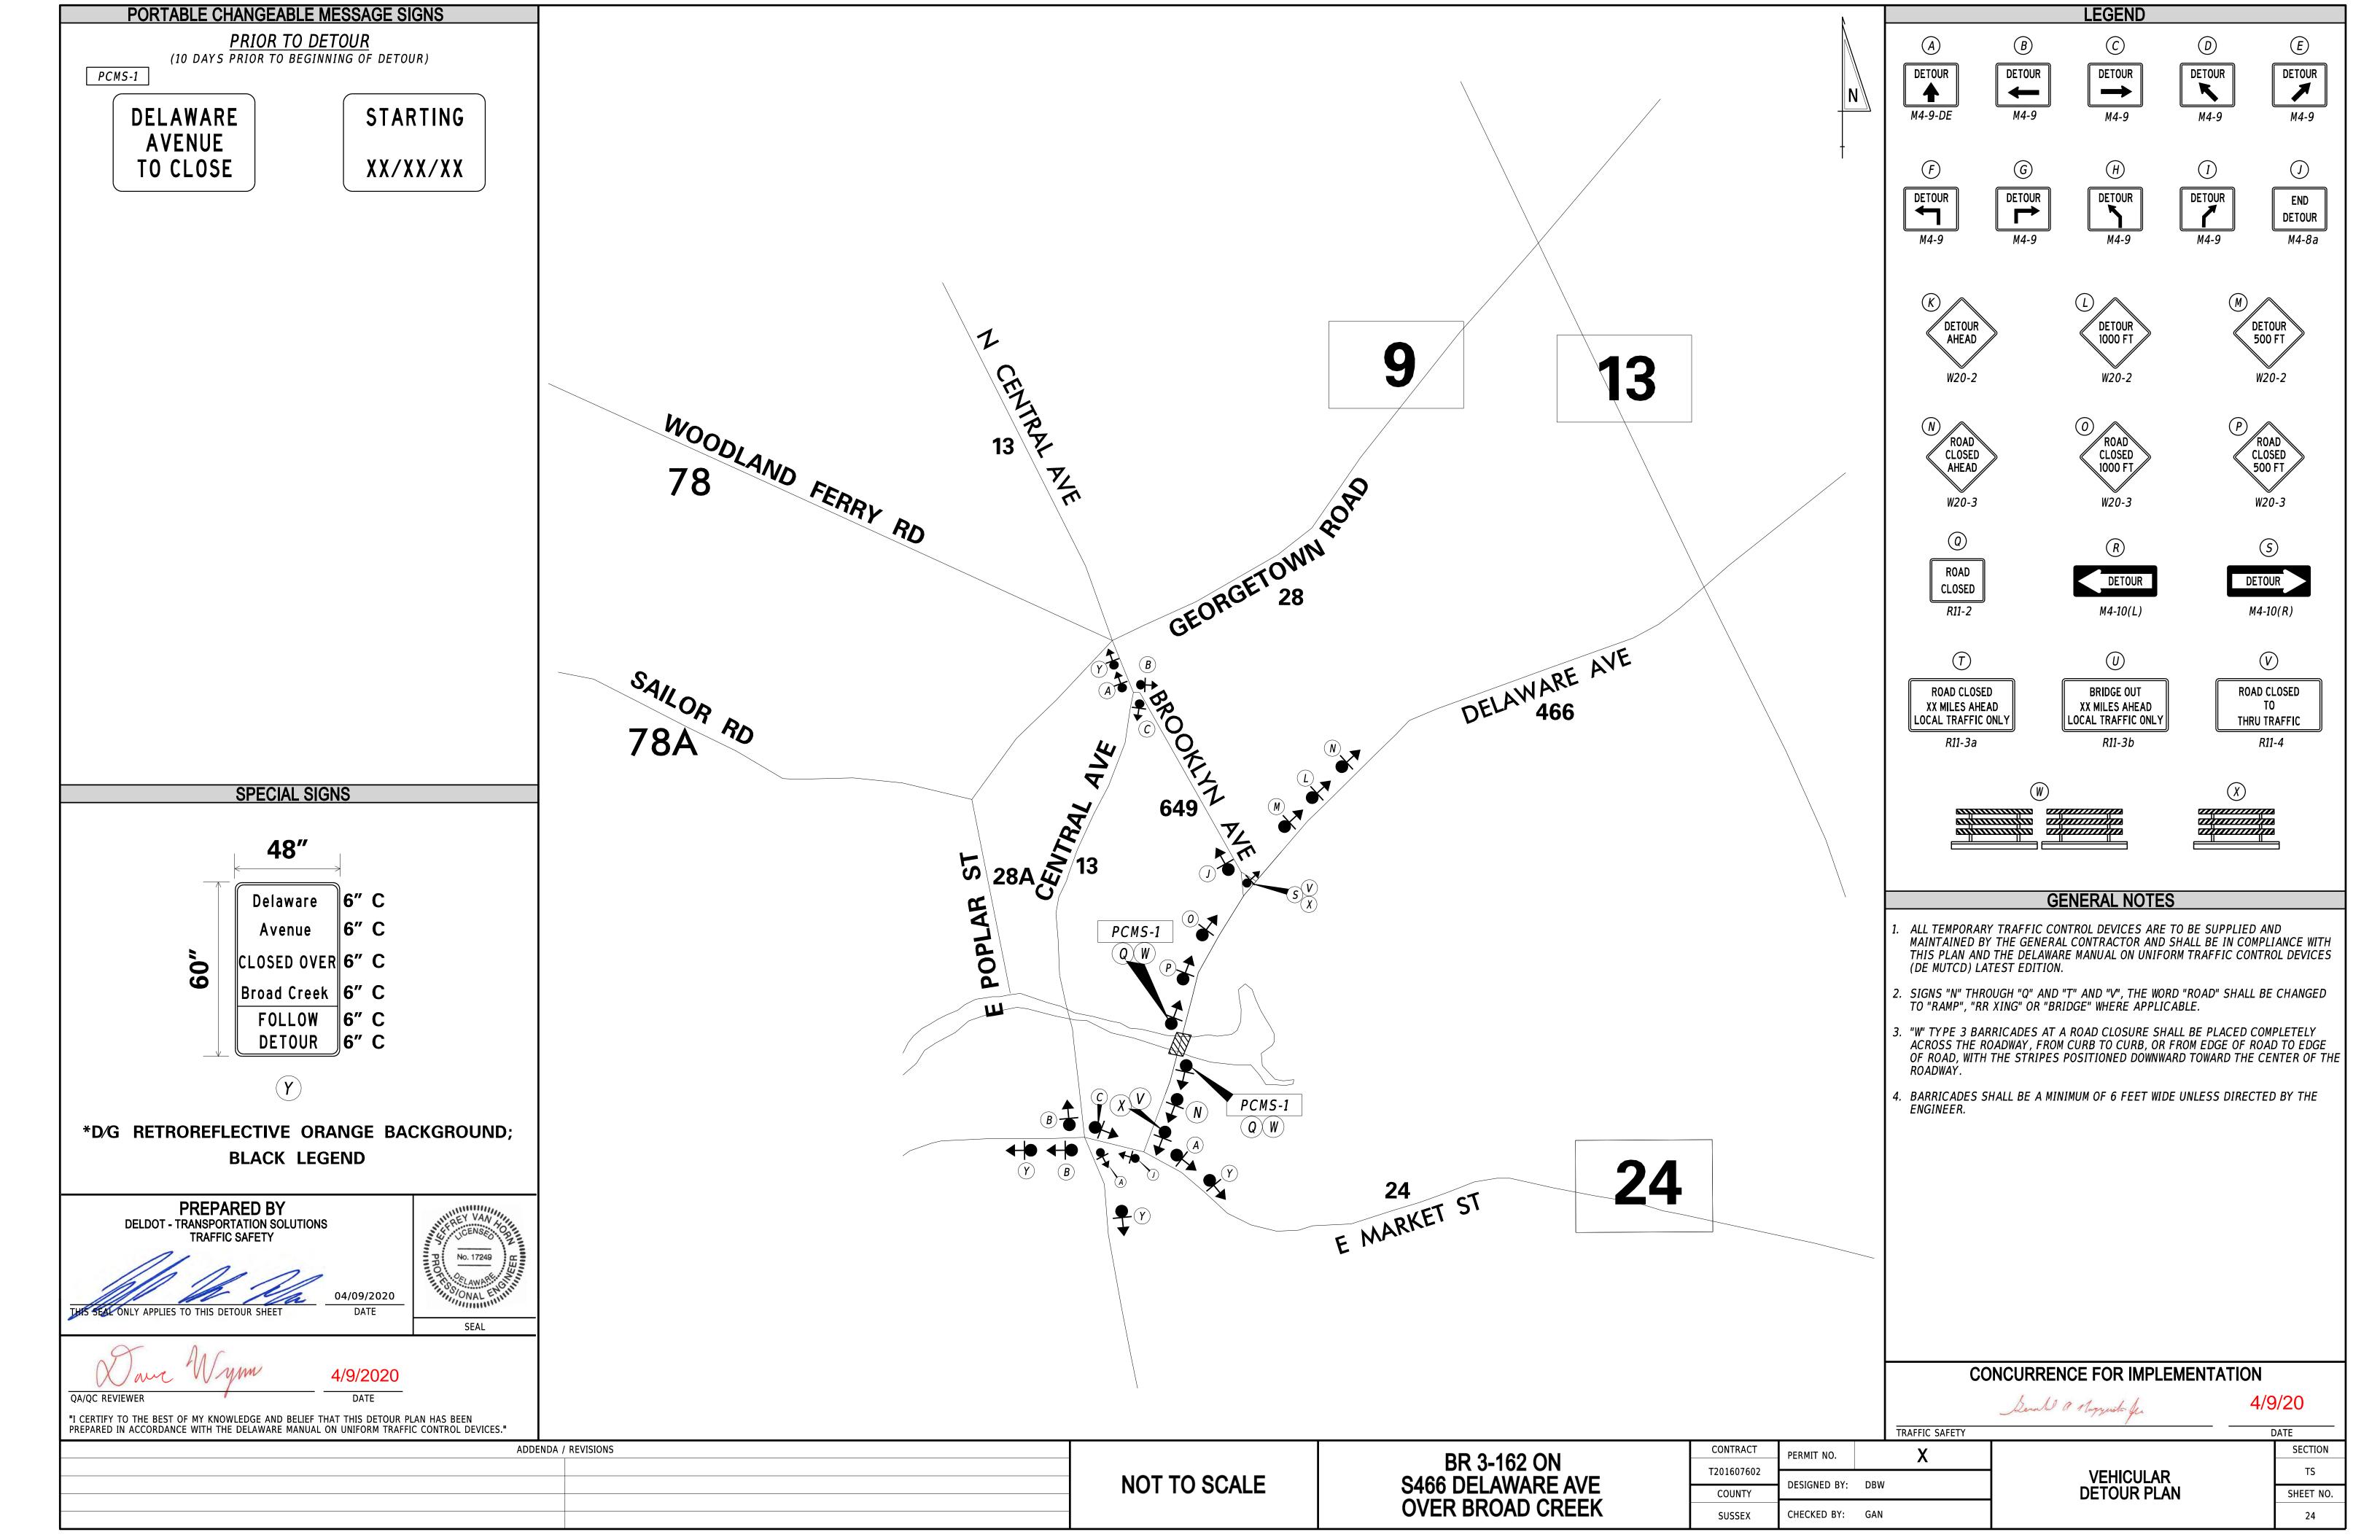

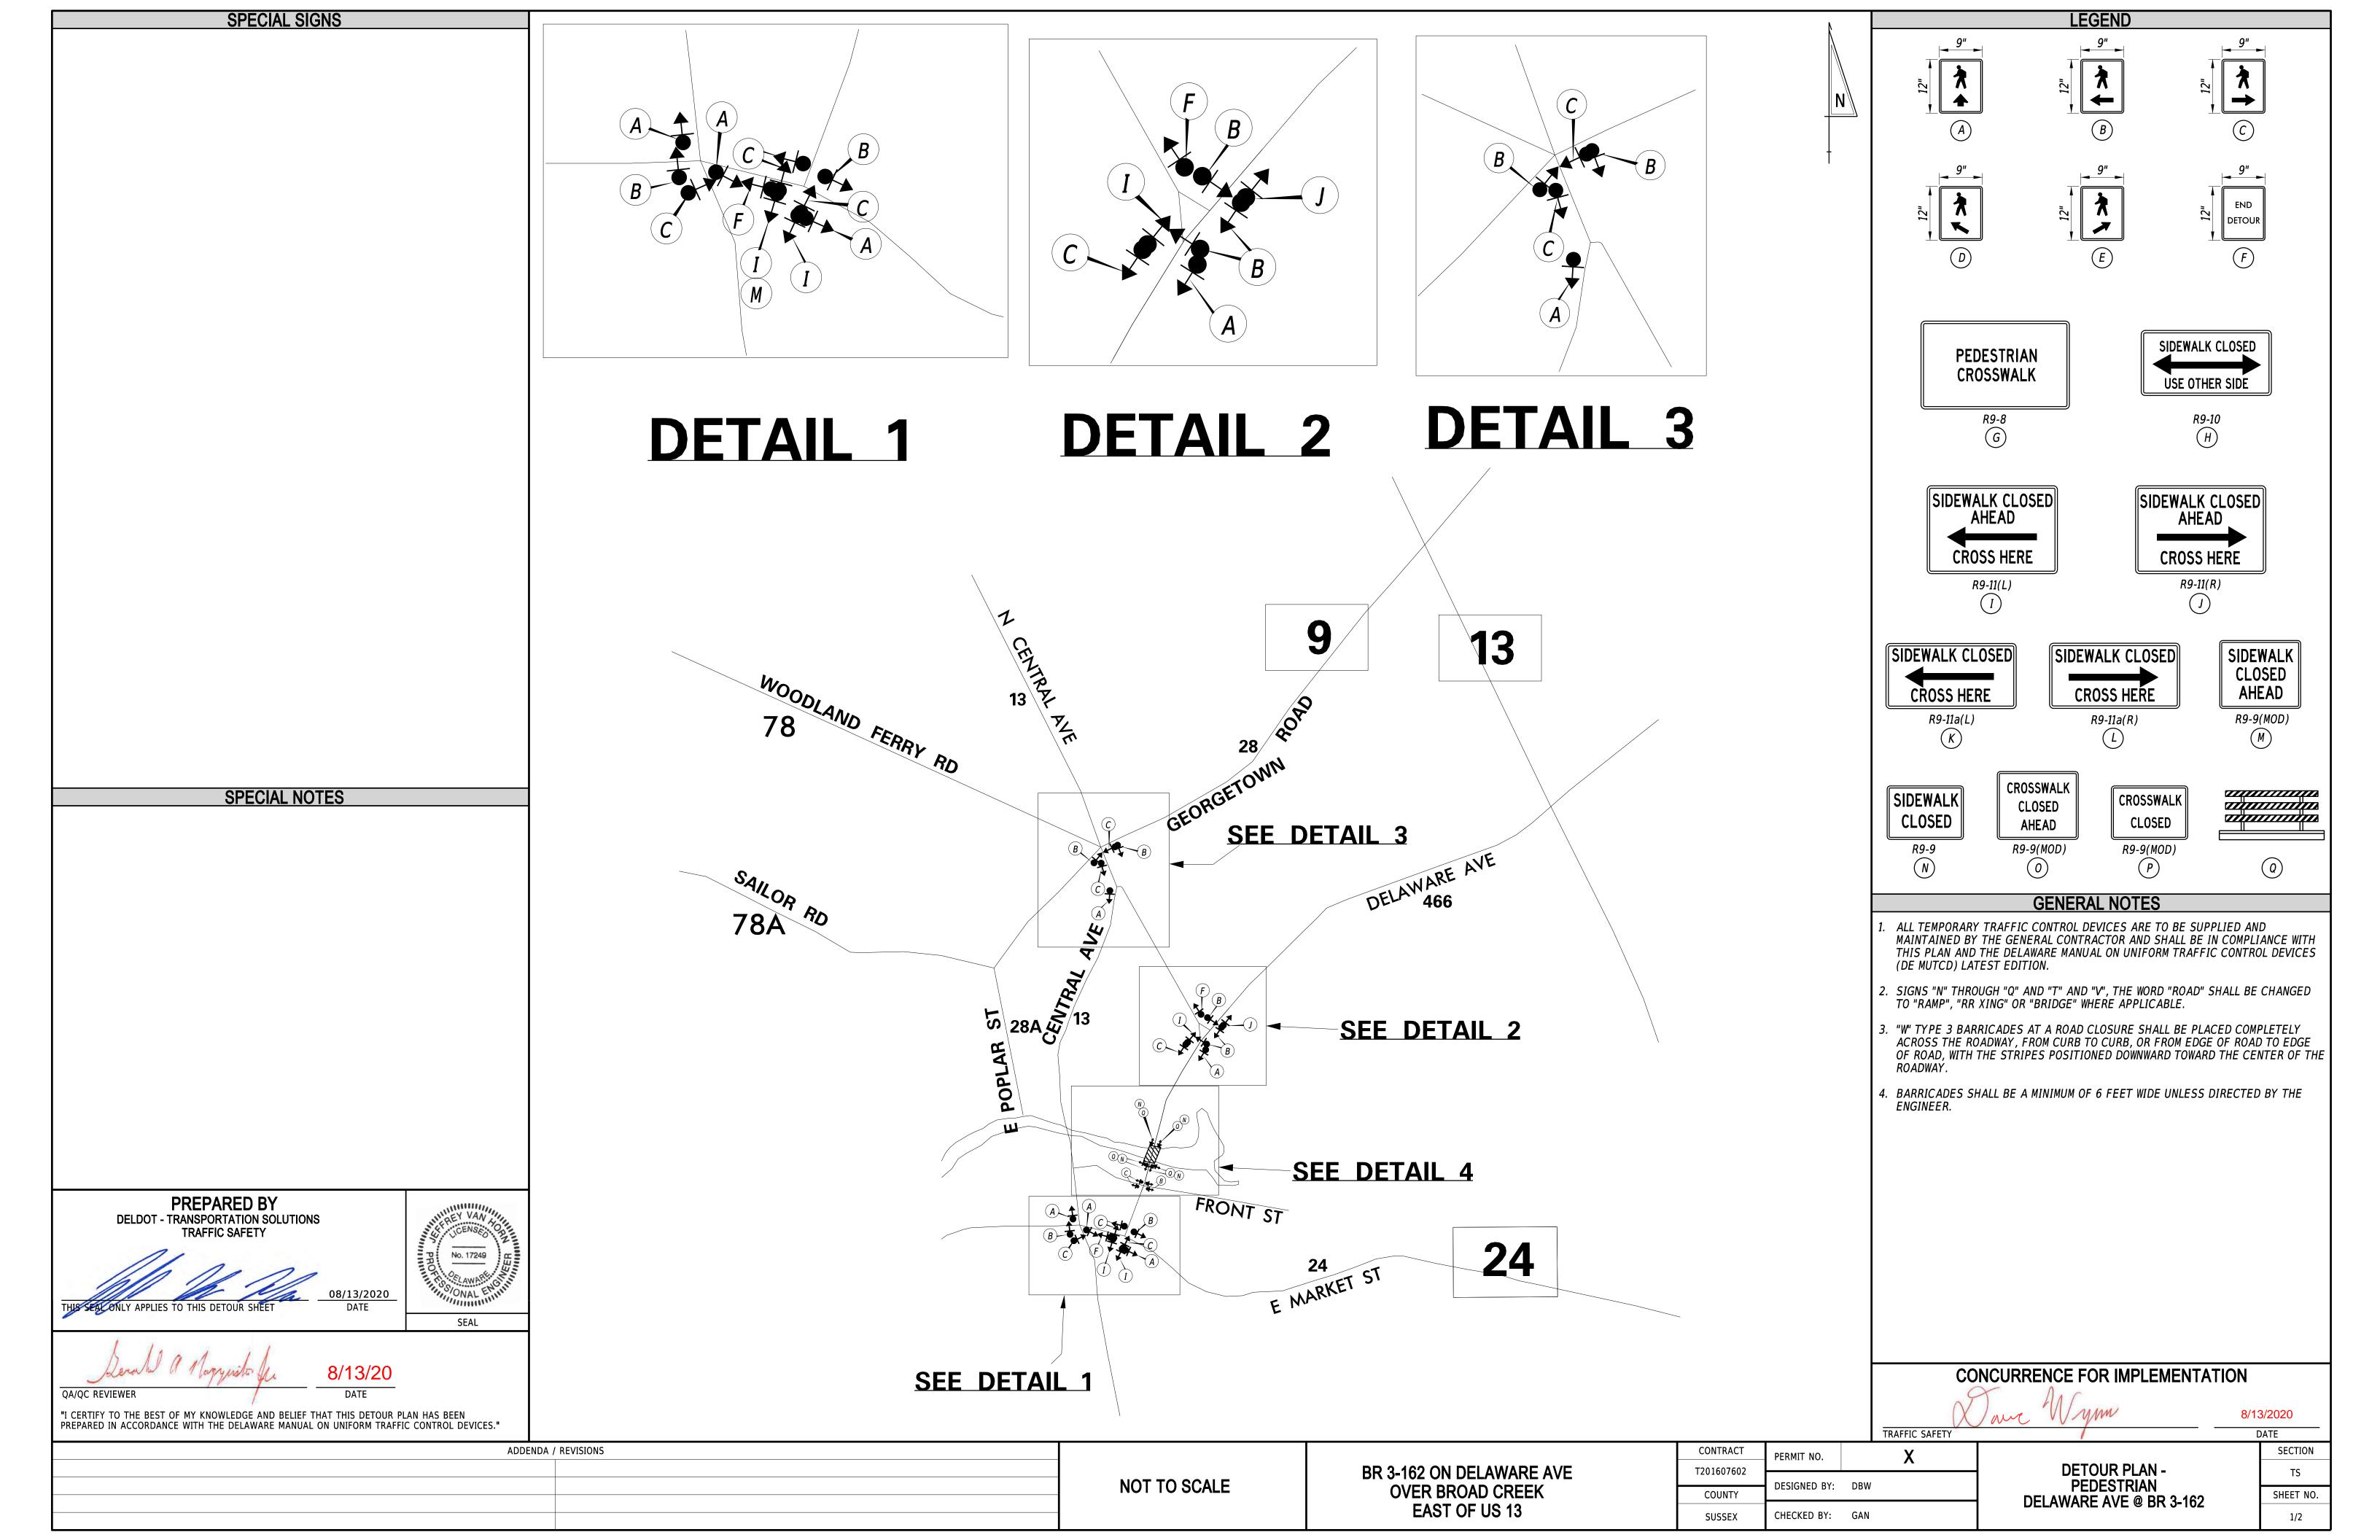

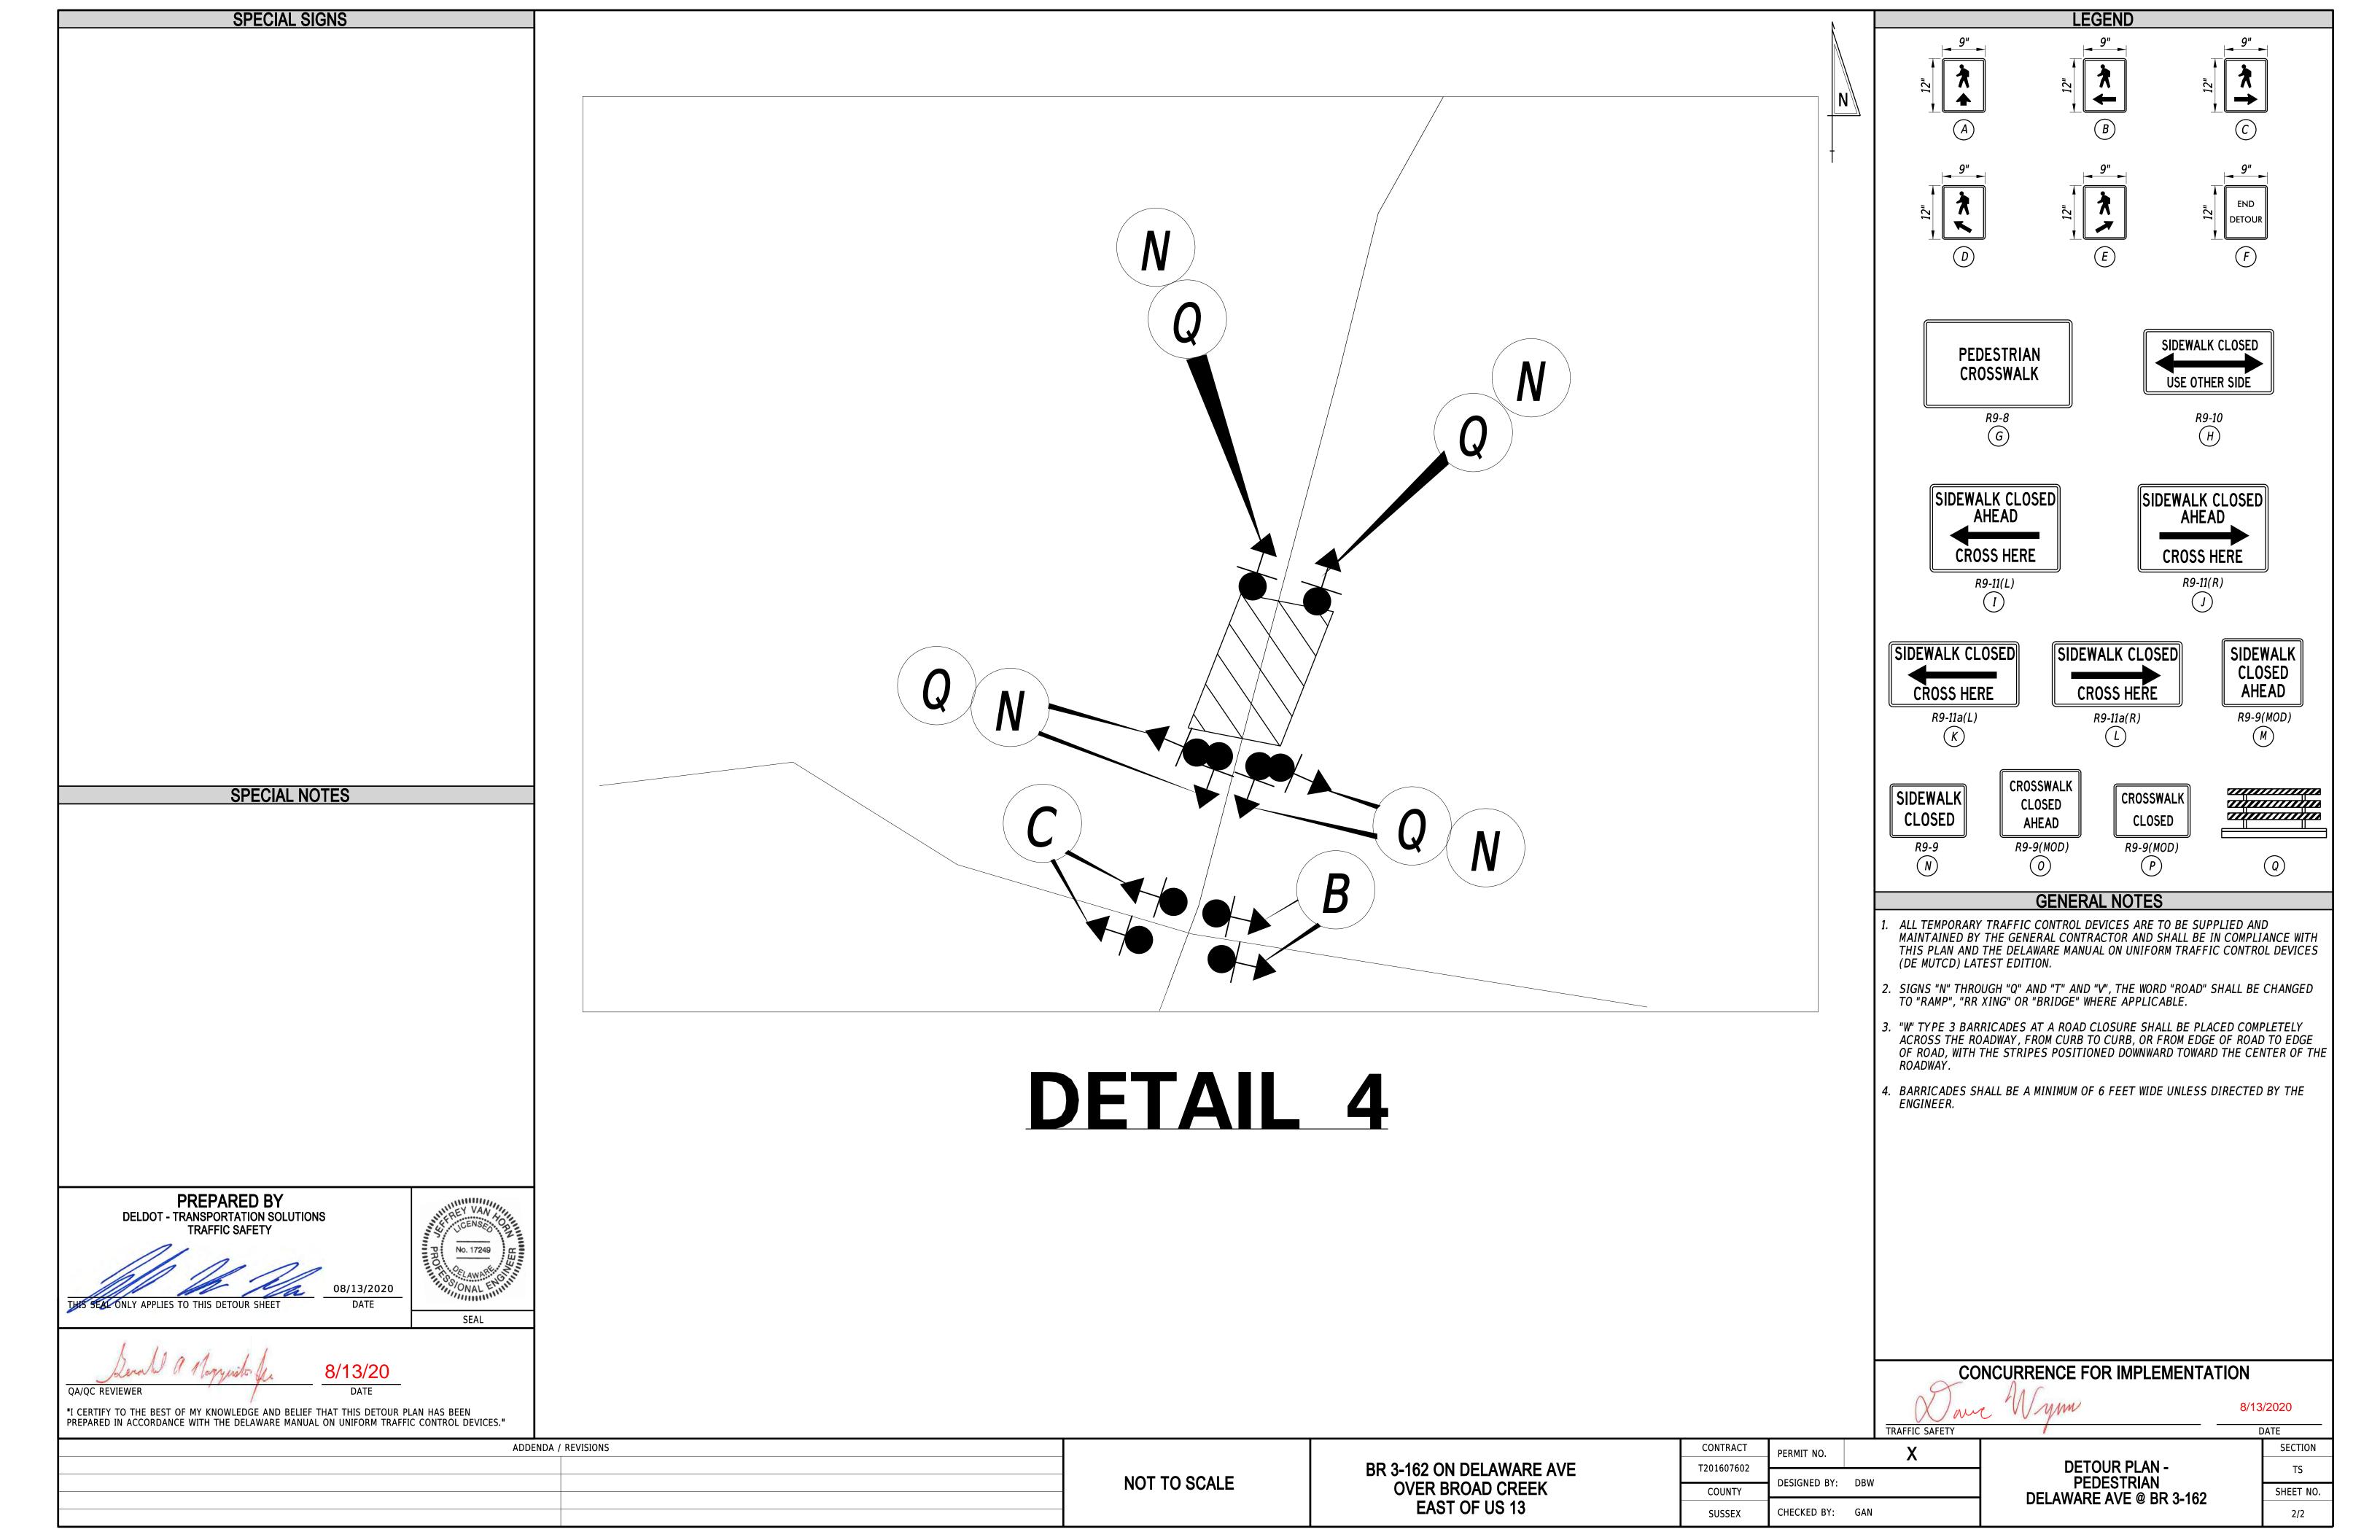


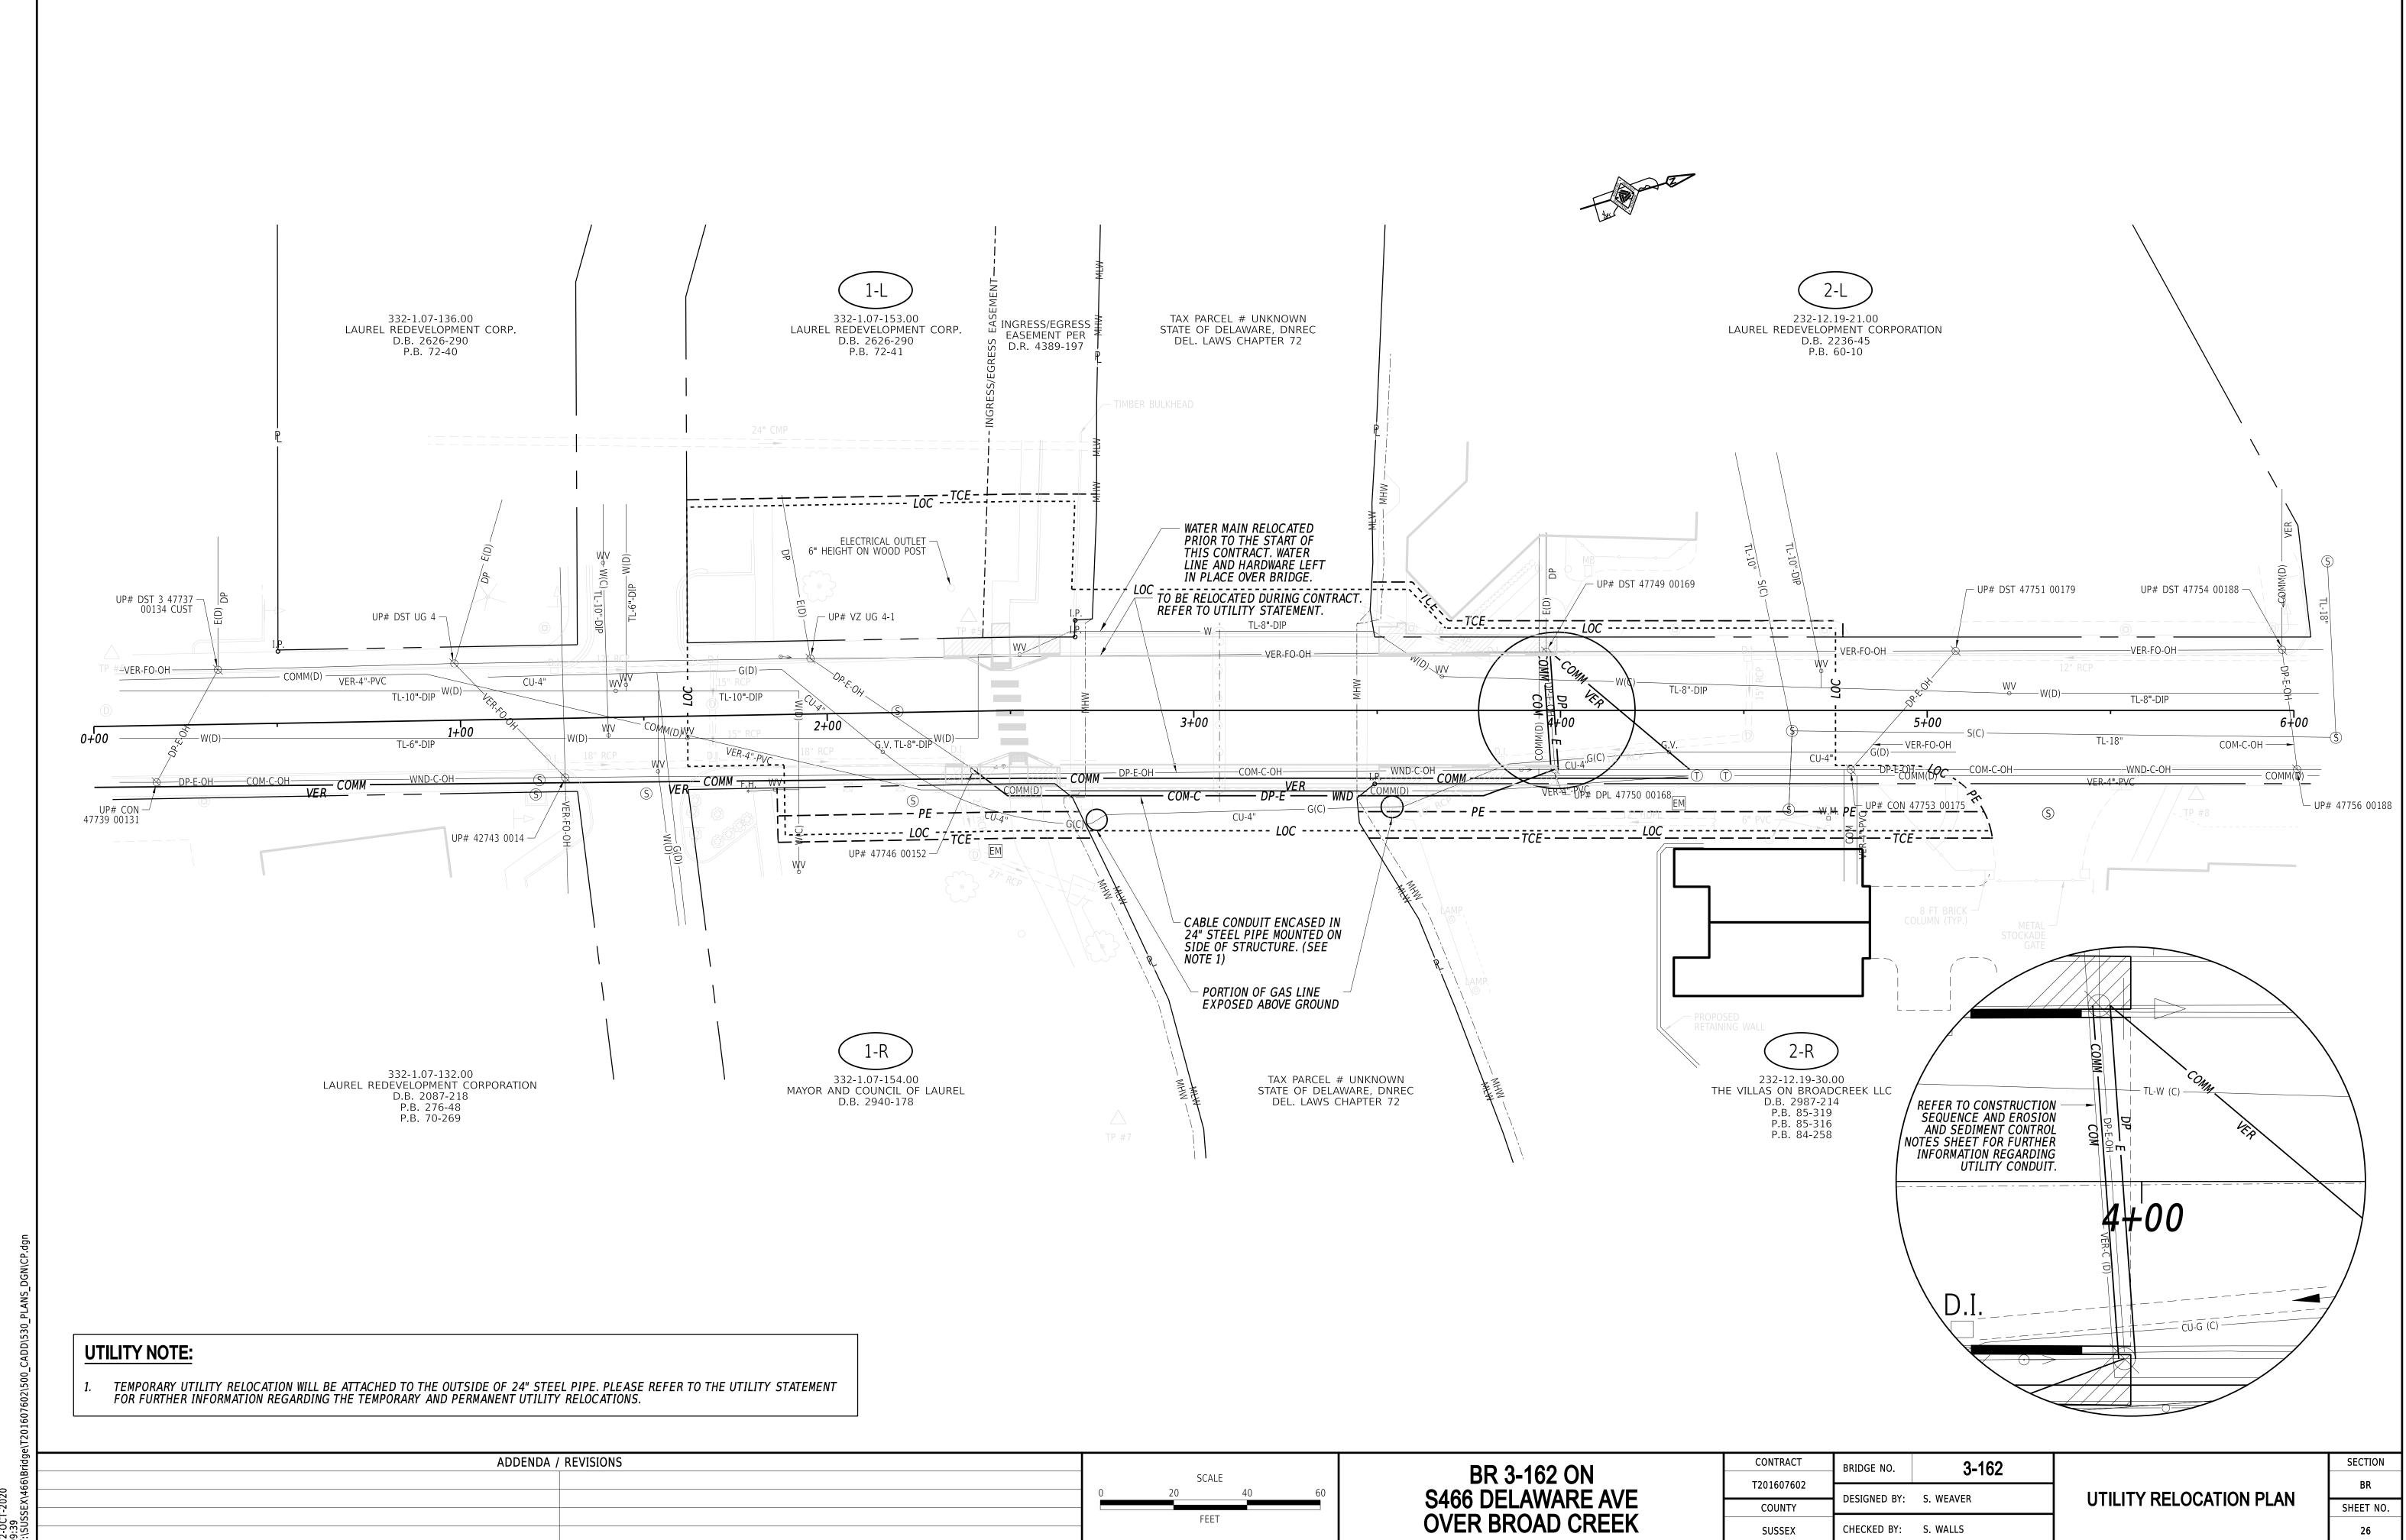

CHECKED BY: S. WALLS

SUSSEX

12-OCT-202 09:39 Y:\SUSSEX\

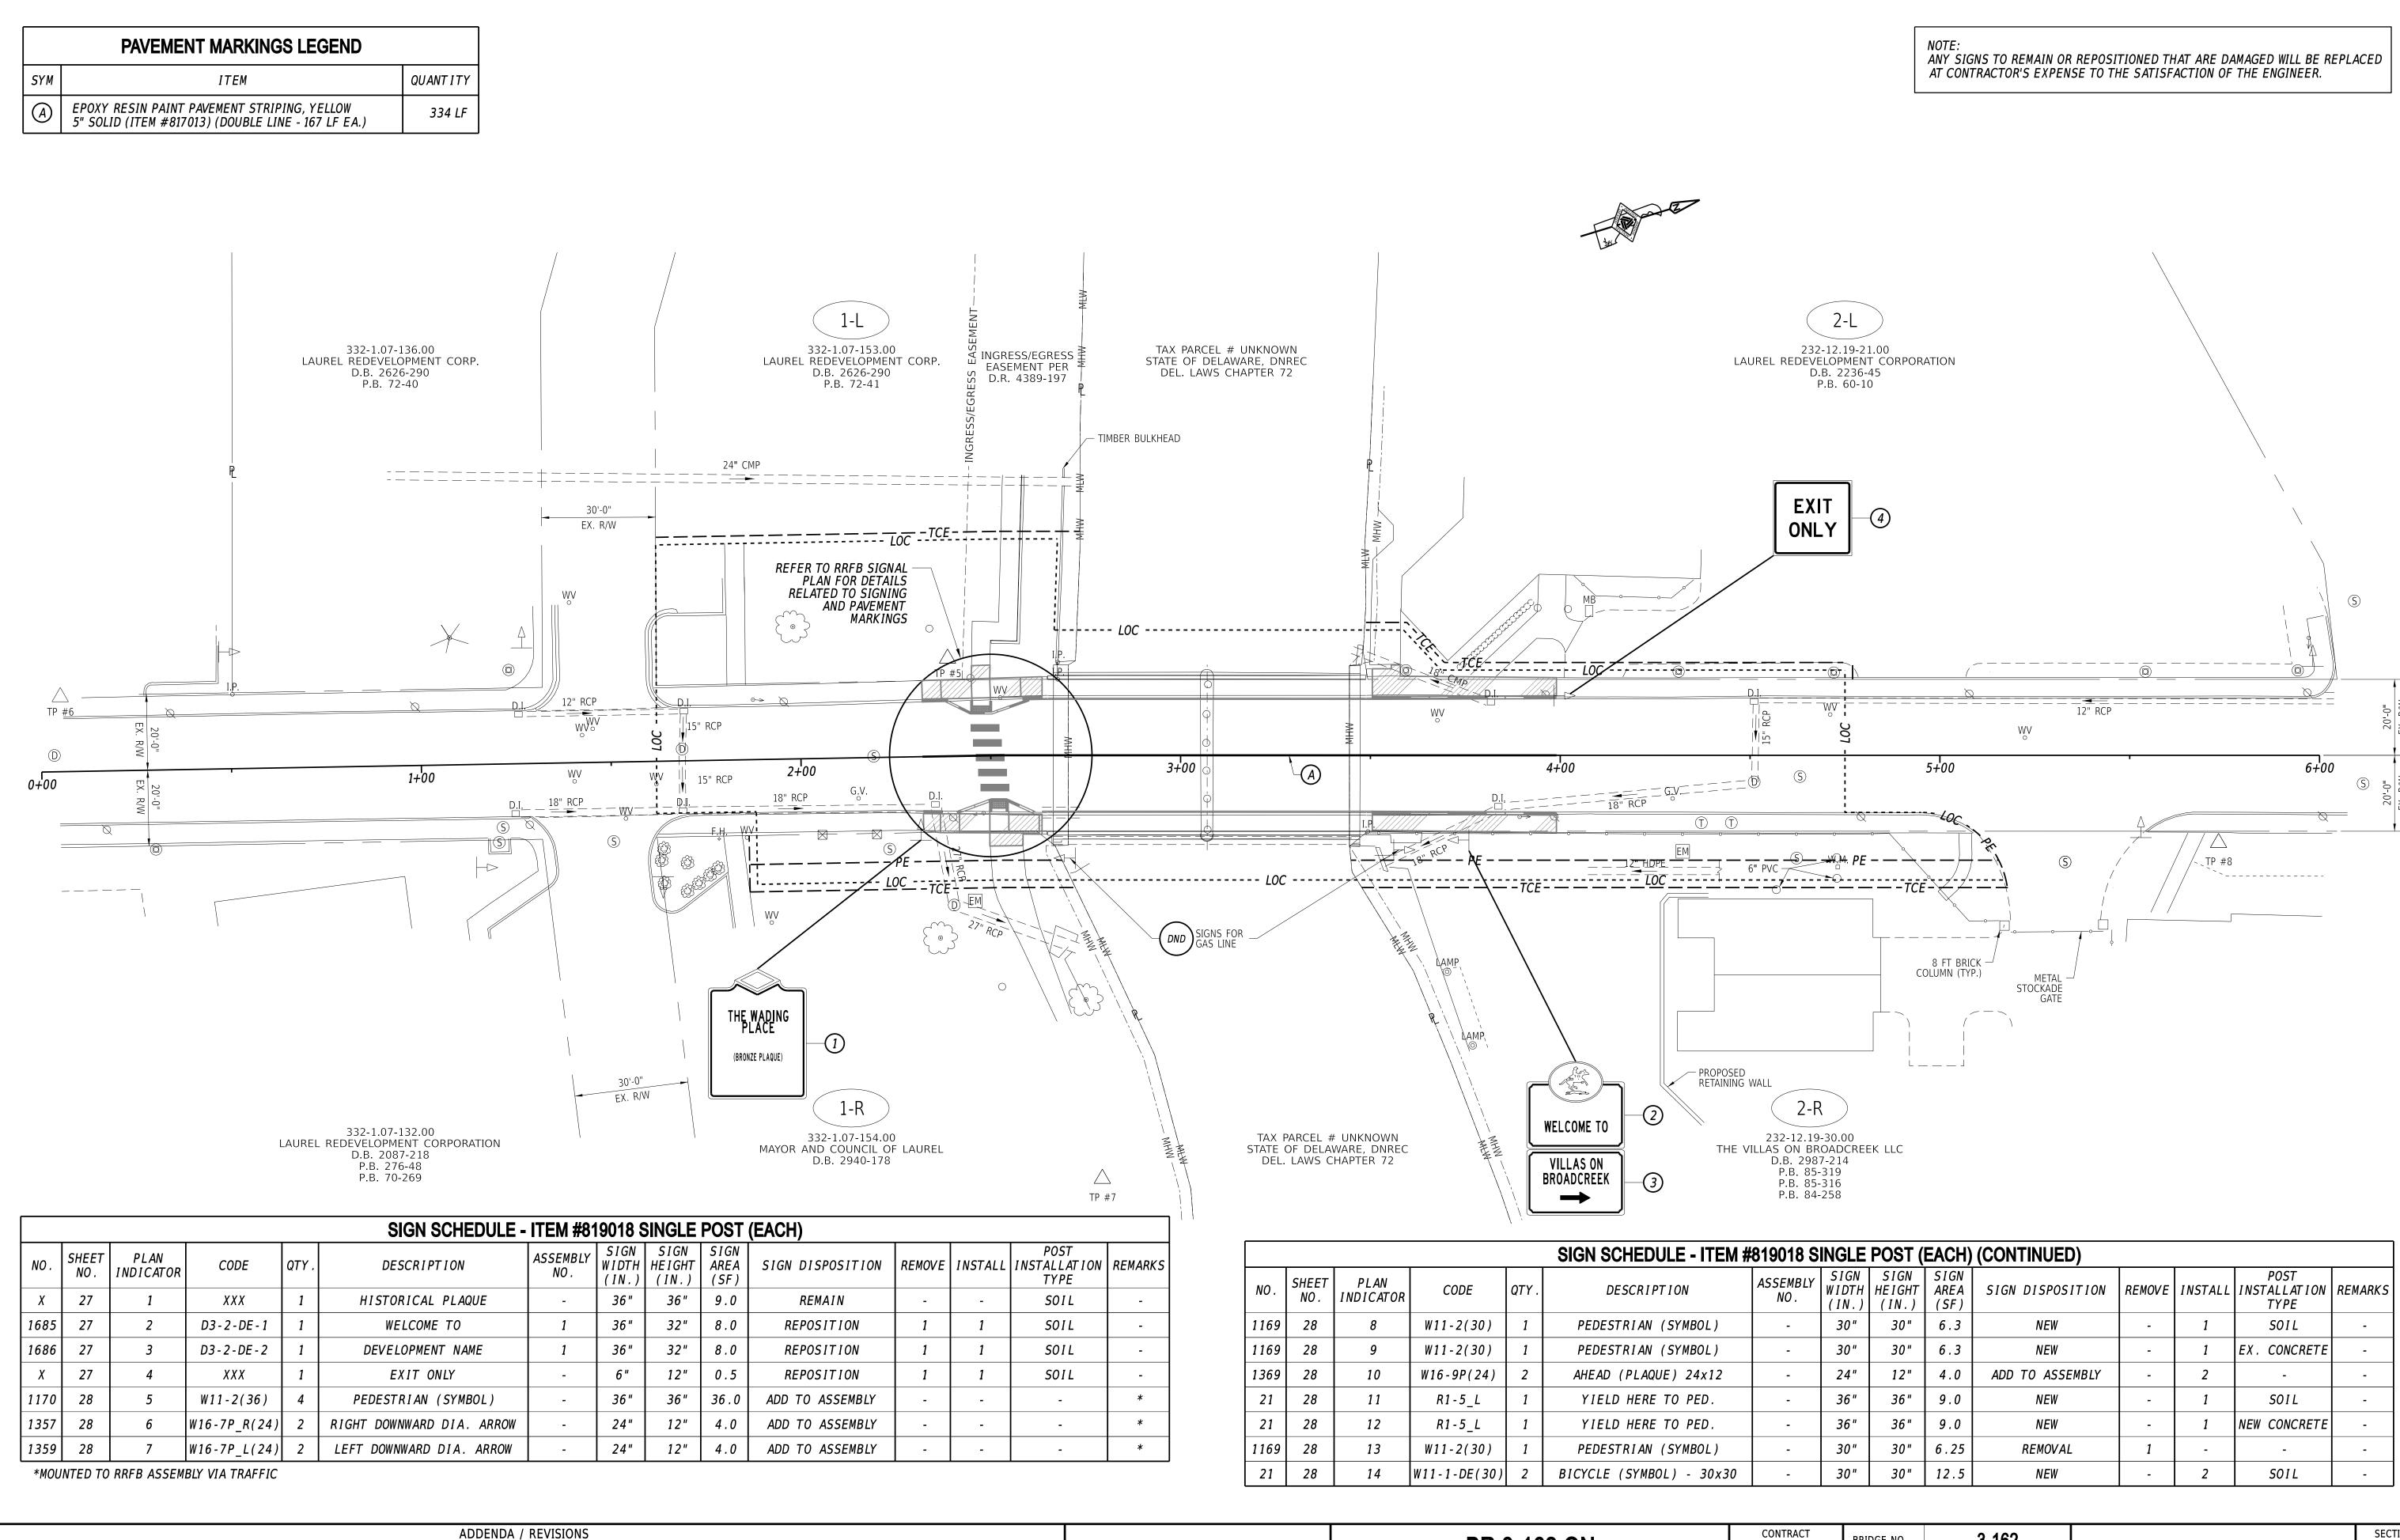

12-OCT-202 09:42 Y:\SUSSEX\

FEET


SCALE


BR 3-162 ON S466 DELAWARE AVE OVER BROAD CREEK

3-162 BRIDGE NO. T201607602 DESIGNED BY: S. WEAVER COUNTY CHECKED BY: S. WALLS SUSSEX

SIGNING AND STRIPING PLAN

BR SHEET NO. 27

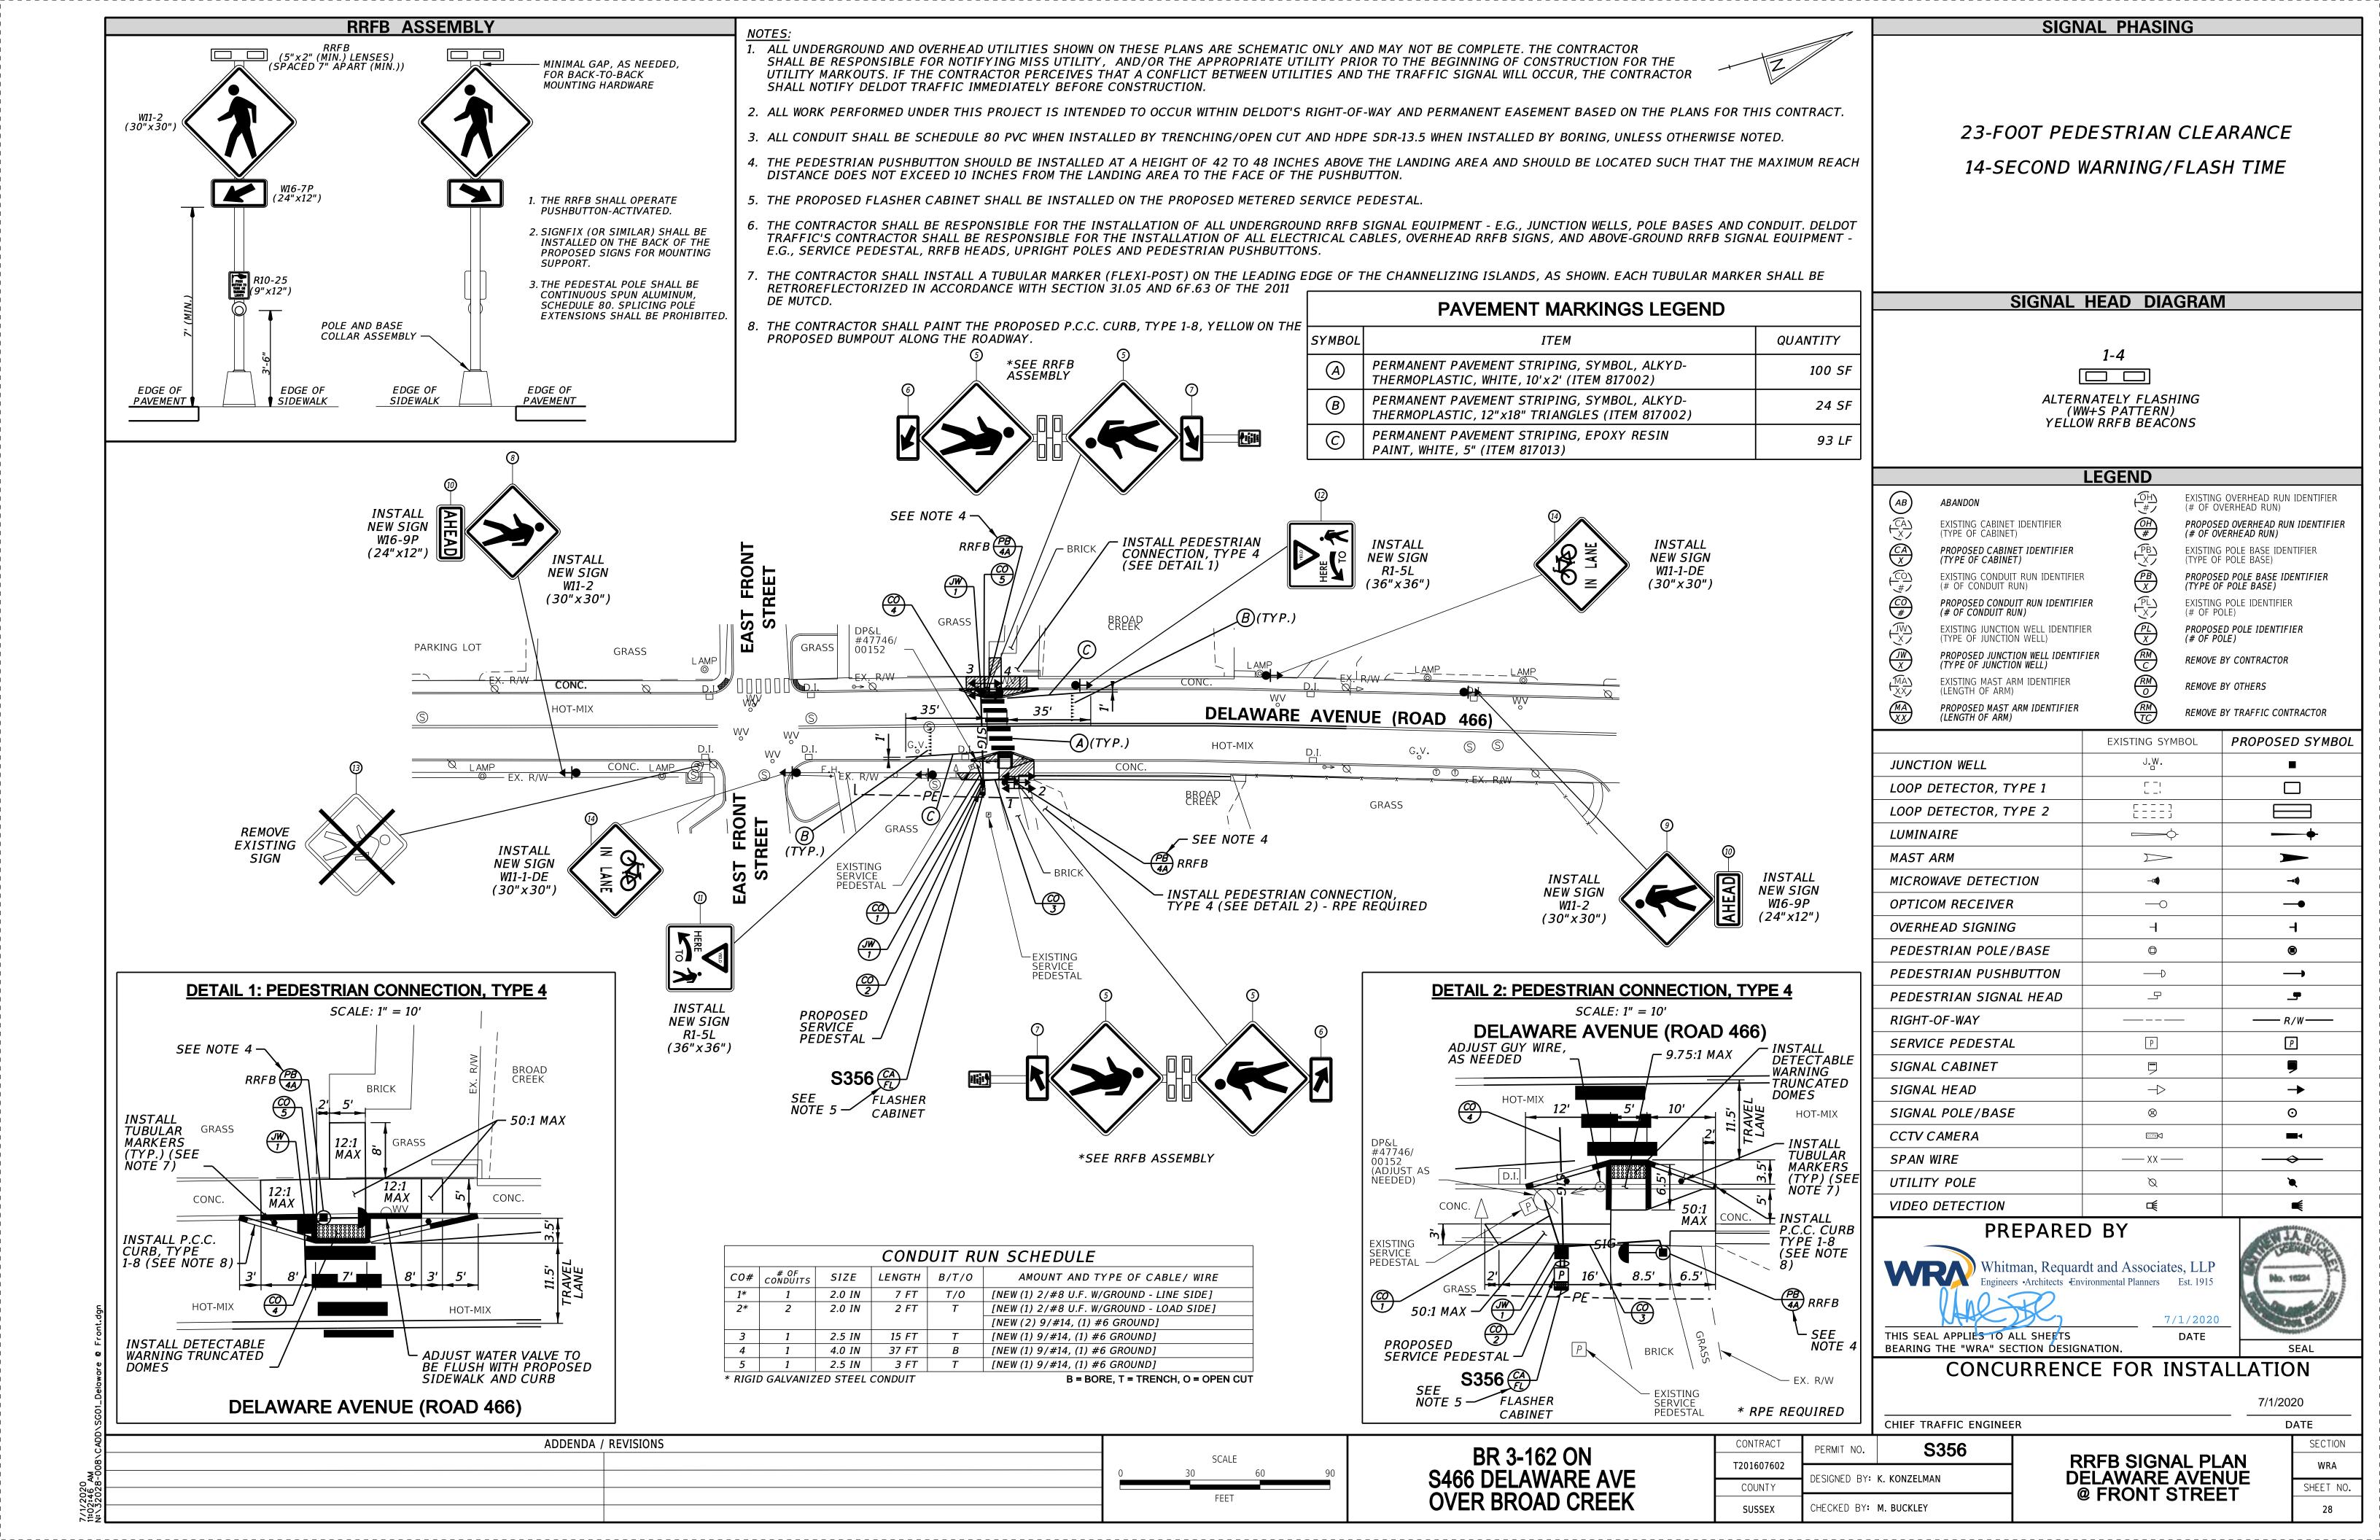

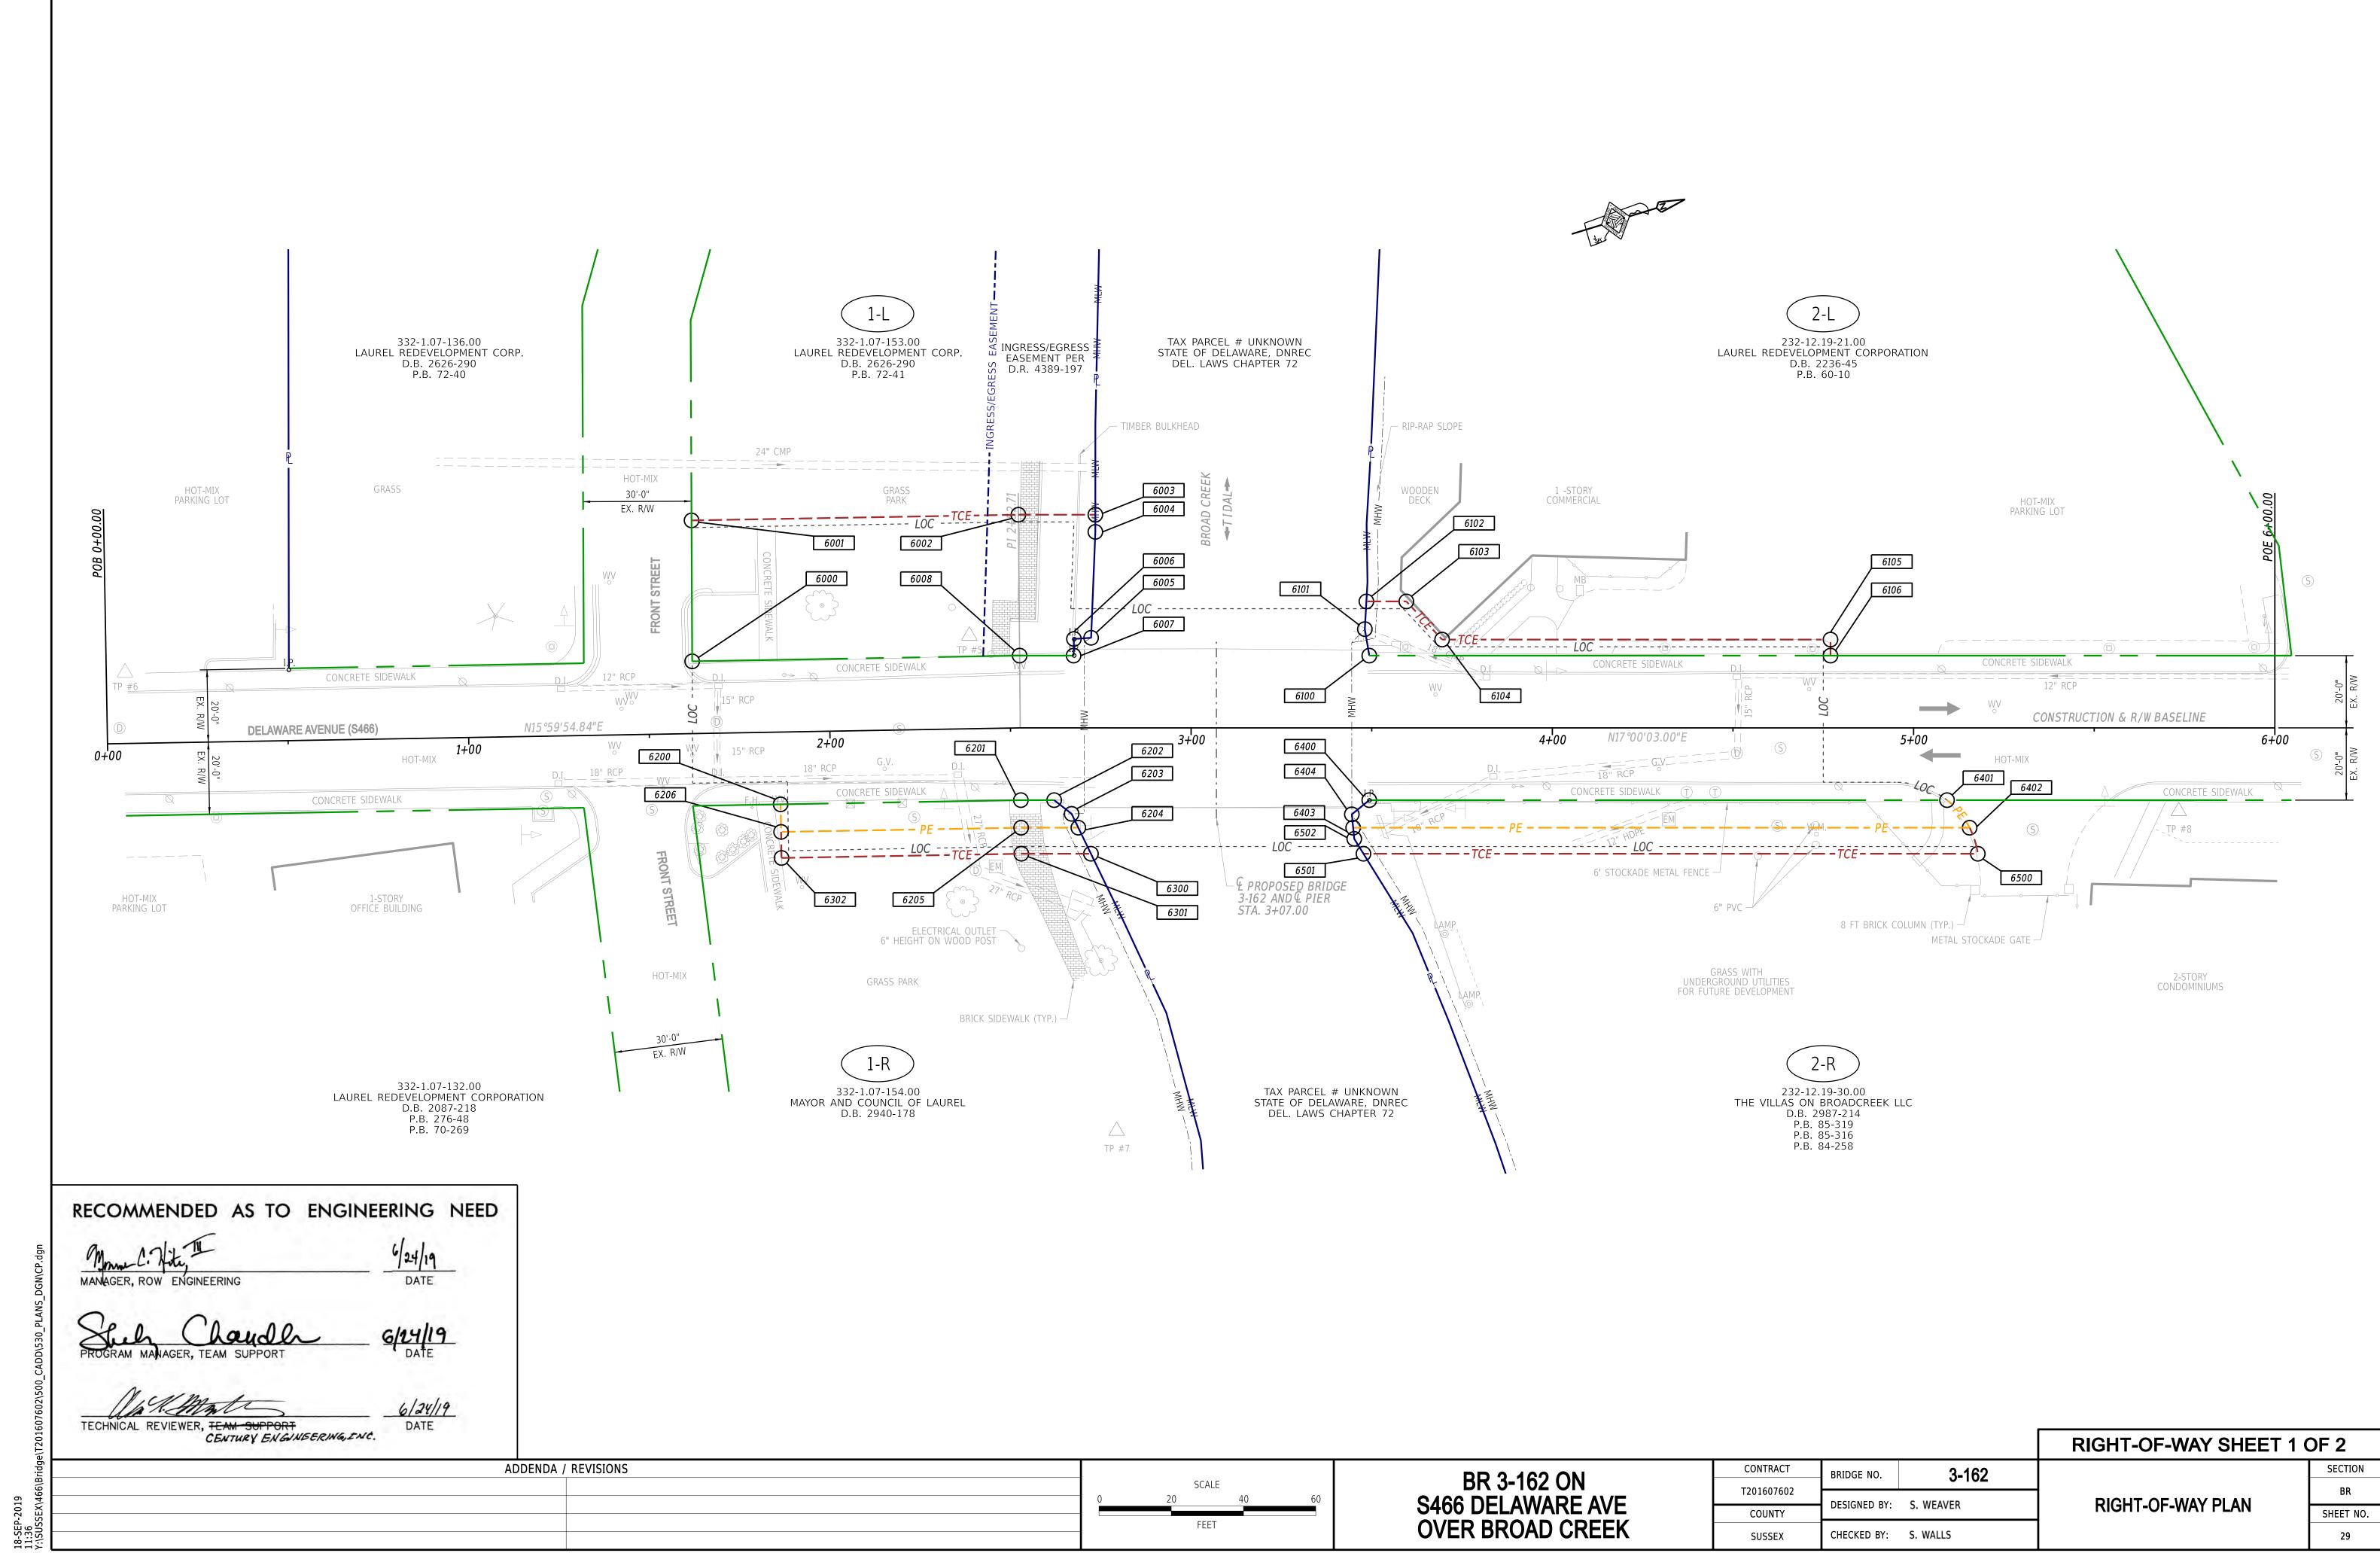

ASSESS	MENT NUMBER			OWNERSHI	P OF RECORD		TYPE OF A	ACQUISITION		TITLE SOURCE	PA	PARCEL AREA (ACRES)	
332	1.07-153.00	(1-L) LAUF	REL REDEVELOPMENT	CORP.				TCE		2626 - 290			1.148
ALIGN	MENT NUMBER & [DESCRIPTION:	10000 - DELAW	ARE AVE.									
PT. NO.	ALIGN. NO.	STATION	OFFSET *	NORTH	EAST	BEARING	DISTANCE	CHORD BEAF	RING	CHORD LENGTH	ARC LEN	IGTH	RADIUS **
6000	10000	1+62.22	- 20 . 00	203210.5225	612358.2559	N 73°15'32.73" W	39.00						
6001	10000	1+62.73	- 59 . 00	203221.7572	612320.9057	N 15°59'54.84" E	90.50						
6002	10000	2+52.71	-59.00	203308.7473	612345.8474	N 17°00'03.00" E	21.30						
6003	10000	2+73.49	- 59 . 00	203329.1169	612352.0753	S 72°58'18.26" E	4.75						
6004	10000	2+73.49	-54.25	203327.7251	612356.6197	S 70°42'57.61" E	29.34						
6005	10000	2+72.32	-24.93	203318.0368	612384.3100	S 13°07'25.98" W	4.77						
6006	10000	2+67.56	-24.61	203313.3941	612383.2275	S 71°43'49.80" E	4.61						
6007	10000	2+67 . 46	-20.00	203311.9479	612387.6081	S 17°00'03.00" W	14.93						
6008	10000	2+52.71	-20.00	203297.6704	612383.2428	S 15°59'54.84" W	90.66						
6000	10000	1+62.22	-20.00	203210.5225	612358.2559								
F	IGURE P_TCE_1L A	REA = 4310.65	88 SQ. FT. (0.09	990 ACRES)	•								
ASSESS	MENT NUMBER			OWNERSHI	P OF RECORD		TYPE OF	ACQUISITION		TITLE SOURCE	PA	RCEL A	REA (ACRES)
232	12.19-21.00	(2-L) LAUI	REL REDEVELOPMENT			TCE		2236 - 45			1.183		
ALIGN	MENT NUMBER & [DESCRIPTION:	10000 - DELAW	ARE AVE.									
T. NO.	ALIGN. NO.	STATION	OFFSET *	NORTH	EAST	BEARING	DISTANCE	CHORD BEAF	RING	CHORD LENGTH	ARC LEN	IGTH	RADIUS **
6100	10000	3+49.32	-20.00	203390.2325	612411.5416	N 82°33′40.21″ W	7.44						
6101	10000	3+48.09	- 27 . 33	203391.1952	612404.1686	N 69°45′12.84″ W	7.68						
6102	10000	3+48.52	- 35 . 00	203393.8522	612396.9649	N 17°00'03.00" E	11.07						
6103	10000	3+59.59	- 35 . 00	203404.4360	612400.2007	N 63°51'22.87" E	14.47						
6104	10000	3+69.48	-24.44	203410.8107	612413.1881	N 17°00'03.00" E	107.52						
6105	10000	4+77.00	-24.44	203513.6287	612444.6243	S 73°00'00.00" E	4.44						
6106	10000	4+77.00	-20.00	203512.3299	612448.8724	S 17°00'03.00" W	127.68						
6100	10000	3+49.32	-20.00	203390.2325	612411.5416								
F	IGURE P_TCE_2L A	REA = 740.095	3 SQ. FT. (0.017	O ACRES)	•								
ASSESS	MENT NUMBER			OWNERSHI	P OF RECORD		TYPE OF	ACQUISITION		TITLE SOURCE	PA	RCEL A	REA (ACRES)
332	1.07-154.00	(1-R) MAYO	R AND COUNCIL OF	LAUREL				P/E		2940 - 178			0.127
ALIGN	MENT NUMBER & [DESCRIPTION:	10000 - DELAW	ARE AVE.									
PT. NO.	ALIGN. NO.	STATION	OFFSET *	NORTH	EAST	BEARING	DISTANCE	CHORD BEAF	RING	CHORD LENGTH	ARC LEN	IGTH	RADIUS **
6200	10000	1+86.00	20.00	203222.3570	612403.2608	N 15°59'54.84" E	66.53						
6201	10000	2+52.88	20.00	203286.3096	612421.5972	N 17°00'03.00" E	9.21						
6202	10000	2+62.09	20.00	203295.1175	612424.2901	N 55°04'07.70" E	6.14						
6203	10000	2+66.92	23.78	203298.6322	612429.3226	N 81°10'20.08" E	4.27						
6204	10000	2+68.79	27.63	203299.2881	612433.5457	S 17°00'03.00" W	15.84						
6205	10000	2+52.95	27.63	203284.1420	612428.9149	S 15°59'54.84" W	66.46						
6206	10000	1+86.00	27.63	203220.2534	612410.5968	N 74°00'00.00" W	7.63						
6200	10000	1+86.00	20.00	203222.3570	612403.2608								
	TOURE D. DE 1D. AD	DEA - 600 0200	SQ. FT. (0.014)) ACRES)						<u> </u>			

ASSESS	MENT NUMBER			OWNERSH	IP OF RECORD			TYPE OF	ACQUISITION	•	TITLE SOURCE	PARCEL /	PARCEL AREA (ACRES)	
332-	1.07-154.00	(1-R) MAYO	R AND COUNCIL OF	LAUREL					TCE		2940 - 178		0.127	
ALIGN	MENT NUMBER &	DESCRIPTION:	10000 - DELAW	ARE AVE.										
PT. NO.	ALIGN. NO.	STATION	OFFSET *	NORTH	EAST	BEARING	DIS	TANCE	CHORD BEAR	ING	CHORD LENGTH	ARC LENGTH	RADIUS **	
6300	10000	2+72.28	34.84	203300.5173	612441.4604	S 17°00'03.00" W		19.26						
6301	10000	2+53.01	34.84	203282.0944	612435.8277	S 15°59'54.84" W		66.40						
6302	10000	1+86.00	34.84	203218.2662	612417.5270	N 74°00'00.00" W		7.21						
6206	10000	1+86.00	27 . 63	203220.2534	612410.5968	N 15°59'54.84" E		66.46						
6205	10000	2+52.95	27 . 63	203284.1420	612428.9149	N 17°00'03.00" E		15.84						
6204	10000	2+68.79	27 . 63	203299.2881	612433.5457	N 81°10′20.08″ E		8.01						
6301	10000	2+72.28	34.84	203300.5173	612441.4604									
F	IGURE P_TCE_1R /	AREA = 605.4687	7 SQ. FT. (0.01.	39 ACRES)										
ASSESS	ASSESSMENT NUMBER OWNERSHIP OF RECORD							TYPE OF	ACQUISITION	•	TITLE SOURCE	PARCEL AREA (ACRES)		
232-	12.19-30.00	(2-R) THE	VILLAS ON BROADO	CREEK LLC					P/E		2987 - 214		2.821	
ALIGN	MENT NUMBER &	DESCRIPTION:	10000 - DELAW	ARE AVE.										
PT. NO.	ALIGN. NO.	STATION	OFFSET *	NORTH	EAST	BEARING	DIS	TANCE	CHORD BEAR	ING	CHORD LENGTH	ARC LENGTH	RADIUS **	
6400	10000	3+49.32	20.00	203378.5371	612449.7954	N 17°00'03.00" E		159.93						
6401	10000	5+09.25	20.00	203531.4777	612496.5565				N 67°40'37	.43" E	9.87	9.94	23.0	
6402	10000	5+15.50	27 . 63	203535.2249	612505.6826	S 17°00'03.00" W		170.65						
6403	10000	3+44.86	27 . 63	203372.0337	612455.7874	N 78°38′42.34″ W		3.72						
6404	10000	3+44.49	23.93	203372.7659	612452.1412	N 22°07′13.25″ W		6.23						
6400	10000	3+49.32	20.00	203378.5371	612449.7954									
F	IGURE P_PE_2R AI	REA = 1274.6254	4 SQ. FT. (0.02	93 ACRES)										
ASSESS	MENT NUMBER			OWNERSH	IP OF RECORD			TYPE OF	ACQUISITION	•	TITLE SOURCE	PARCEL /	AREA (ACRES)	
232-	12.19-30.00	(2-R) THE	VILLAS ON BROADO	CREEK LLC					TCE		2987 - 214		2.821	
ALIGN	MENT NUMBER &	DESCRIPTION:	10000 - DELAW	ARE AVE.										
PT. NO.	ALIGN. NO.	STATION	OFFSET *	NORTH	EAST	BEARING	DIS	TANCE	CHORD BEAR	ING	CHORD LENGTH	ARC LENGTH	RADIUS **	
6500	10000	5+17.78	34.84	203535.2885	612513.2398	S 17°00'03.00" W		170.06						
6501	10000	3+47.72	34.84	203372.6615	612463.5171	S 75°14'08.74" W		4.86						
6502	10000	3+45.16	30.71	203371.4242	612458.8223	N 78°38′42.34″ W		3.10						
6403	10000	3+44.86	27 . 63	203372.0337	612455.7874	N 17°00'03.00" E		170.65						
6402	10000	5+15.50	27 . 63	203535.2249	612505.6826				N 89°31'02	2.69" E	7.56	7.59	23.0	
6500	10000	5+17.78	34.84	203535.2885	612513.2398									

				PROPERTY AREA BEFORE ACQUISITION			AREA TO BE	ACQUIRED						
COLINITY A COFCOMENT	PLAN			BEFORE ACQUISITION (ACRE)	ACQUISITION CODE			EASE	EASEMENT		DEED RECORD			
COUNTY ASSESSMENT PARCEL NUMBER	PLAN SHEET NUMBER	OWNERSHIP OF RECORD	TITLE SOURCE	D=DEED C=CALCULATED A=ASSESMENT	FEE, R/W, P/E, TCE	ACQUIRITION	AREA OCCUPIED BY EXISTING RIGHT OF WAY (SQ. FEET/ACRES)	PERMANENT (SQ. FEET/ACRES)	TEMPORARY (SQ. FEET/ACRES)	PROPERTY AREA REMAINING (SQ. FEET/ACRES)	OF ACQUISTITION	REMARKS		
322-1.07-153.00	7	(1-L) LAUREL REDEVELOPMENT CORP.	2626 - 290	D - 1.15	TCE				4310.6588 / 0.10	50002.524 / 1.15		TCE - 1146.63 SF INGRESS/EGRESS EASEMENT PER D.R. 4389-197		
232-12.19-21.00	7	(2-L) LAUREL REDEVELOPMENT CORPORATION	2236 - 45	D - 1.18	TCE				740.0953 / 0.02	51522.768 / 1.18				
332-1.07-154.00	7	(1-R) MAYOR AND COUNCIL OF LAUREL	2940 - 178	D - 0.13	P/E			608.8308 / 0.01						
					TCE				605.4687 / 0.01	5530.00 / 0.13				
232-12.19-30.00	7	(2-R) THE VILLAS ON BROADCREEK LLC	2987 - 214	D - 2.82	P/E			1274.6254 / 0.03						
					TCE				1232.8482 / 0.03	122882.76 / 2.82				
				<u> </u>		<u> </u>								

FEE AREA OF ACQUISITION
R/W AREA OCCUPIED BY EXISTING R/W
P/E PERMANENT EASEMENT
TCE TEMPORARY CONSTRUCTION EASEMENT

* "-" OFFSET IS LEFT OF BASELINE
** "-" CURVE TURNS TO THE LEFT

ACQUISITION CODES

FEE - ACQUISITION R/W - AREA OCCUPIED BY EXISTING R/W

P/E - PERMANENT EASEMENT TCE - TEMPORARY EASEMENT

ADDENDA / REVISIONS

BR 3-162 ON S466 DELAWARE AVE OVER BROAD CREEK NOT TO SCALE

FIGURE P_TCE_2R AREA = 1232.8482 SQ. FT. (0.0283 ACRES)

3-162 BRIDGE NO. T201607602 DESIGNED BY: S. WEAVER COUNTY CHECKED BY: S. WALLS SUSSEX

RIGHT-OF-WAY DATA AND TABULATION SHEET

RIGHT-OF-WAY SHEET 2 OF 2 SHEET NO.

ATTACHMENT F

State and Federal Agency Letters



DEPARTMENT OF NATURAL RESOURCES AND ENVIRONMENTAL CONTROL

DIRECTOR'S OFFICE

DIVISION OF FISH & WILDLIFE RICHARDSON & ROBBINS BUILDING 89 KINGS HIGHWAY DOVER, DELAWARE 19901

PHONE (302) 739-9910

May 5, 2022

Kieran Burns Envirotech Environmental Consulting, Inc. 17605 Nassau Commons Boulevard Unit D Lewes, DE 19958

Re: ETECH 2022 Chesapeake Utilities Gas Main Replacement

Dear Kieran:

Thank you for contacting the Species Conservation and Research Program (SCRP) about information on rare, threatened and endangered species, unique natural communities, and other significant natural resources as they relate to the above referenced project.

State Natural Heritage Site

A review of our database indicates that the following state rare or federally listed plants, animals or natural communities occur at or adjacent to the project site:

Scientific Name	Common Name	Taxon			SGCN Tier	Federal Status
Acipenser oxyrhynchus	Atlantic Sturgeon	Fish	S2	Е	Tier 1	Е
Elliptio fisheriana	Northern Lance	Invertebrate	S2	NL	Tier 2	NL

State Rank: S1 – Extremely rare within the state (typically 5 or fewer occurrences); S2 – Very rare within the state (6 to 20 occurrences); S3 – Rare to uncommon in Delaware; S4 – Apparently secure, at fairly low risk of extinction or extirpation due to an extensive range and/or many populations or occurrences, but with possible cause for some concern as a result of local recent declines, threats, or other factors; S5 – Demonstrably secure, at very low risk of extinction or extirpation due to a very extensive range, abundant populations or occurrences, or little to no concern from declines or threats; SX – Extirpated or presumed extirpated from the state. All historical locations and/or potential habitat have been surveyed; SH – Historically known, but not verified for an extended period (usually 15+ years); there are expectations that the species may be rediscovered; SE – Non-native in the state (introduced through human influence); not a part of the native flora or fauna; SNR – Not yet ranked in Delaware; SN – Occurrences in DE of limited conservation value, **of concern due to a restricted range; SU – Status uncertain within the state. Usually, an uncommon species which is believed to be of conservation concern, but there is inadequate data to determine the degree of rarity; B – Breeding; M – Migratory; N – Nonbreeding.

State Status: E – Endangered, i.e., designated by the Delaware Division of Fish and Wildlife as seriously threatened with extinction in the state pursuant to State of Delaware Code (7 Del. §601 et seq.) and implementing regulation (Title 7, 3900, 16.0 Endangered Species); NA – Plants are not included in Title 7; NL – Not listed.

SGCN Tiers: Tier 1 – Species of Greatest Conservation Need (SGCN) that are most in need of conservation action in order to sustain or restore their populations. They are the focus of the Delaware Wildlife Action Plan (DEWAP), which is based on analyzing threats to their populations and habitats, and on developing conservation actions to eliminate, minimize, or compensate for these threats; Tier 2 – SGCN that are also in need of conservation action, although not with the urgency of Tier 1 species. Their distribution across the landscape will help determine where

DEWAP conservation actions will be implemented on the ground; **Tier 3** – These species are for the most part still relatively common in Delaware, but are listed as SGCN for various reasons, including documented population declines, high responsibility of the Northeast region for the global population, or continued need for monitoring and/or management. This tier also includes non-breeding species that are uncommon in Delaware. **NA** – Plants are not addressed in DEWAP.

Federal Status: E – Endangered, i.e., designated by the U.S. Fish and Wildlife Service as being in danger of extinction throughout its range; T – Threatened, i.e., designated by USFWS as being likely to become endangered in the foreseeable future throughout all or a significant portion of its range; C – Candidate, i.e., taxa for which the U.S. Fish and Wildlife Service has on file enough substantial information on biological vulnerability and threat(s) to support proposals to list them as endangered or threatened species. NOAA Managed Candidate: SC – Species of Concern, i.e., species about which NOAA's National Marine Fisheries Service (NMFS) has some concerns regarding status and threats, but for which insufficient information is available to indicate a need to list the species under the ESA; NL – Not listed.

While one or more state-rare species were identified near the project location, at present, this project does <u>not</u> lie within a State Natural Heritage Site, <u>nor</u> does it lie within a Delaware National Estuarine Research Reserve, which are two criteria used to identify "Designated Critical Resource Waters" in the Army Corps of Engineers (ACOE) Nationwide Permit General Condition No. 22. A copy of this letter shall be included in any permit application or preconstruction notification submitted to the Army Corps of Engineers for activities on this property.

Freshwater Mussels

Northern lance is a freshwater mussel that is a species of conservation concern in Delaware. The Nanticoke River watershed has the most diverse population of freshwater mussels in the state. Because freshwater mussels are filter feeders, and have a long lifespan and complex life cycle, they often serve as excellent indicators of water quality. Impacts to this population of freshwater mussels can be minimized by taking measures to decrease downstream sedimentation during construction activities.

Fisheries

Atlantic Sturgeon

The occurrence of Atlantic Sturgeon (*Acipenser oxyrhynchus*) in the Nanticoke River watershed has been confirmed. More specifically, Atlantic sturgeon have been detected just 1.6 miles downstream from the project site using telemetry equipment and captured just 3 miles downstream. This species is listed as endangered under the U.S. Endangered Species Act. Data collected through sampling efforts and acoustic telemetry suggest this species is likely inhabiting the river system from approximately **August 15th through October 15th**. A time of year restriction on all project activities during this time is recommended to avoid impacts to this species. Note that these data are based on a project in the first few years of study and recommendations may change in the future. Also note that a Section 7 consultation may be required.

Other Anadromous Species

Broad Creek is utilized during upstream migration by several fish species of concern. American shad (*Alosa sapidissima*), blueback herring (*Alosa aestivalis*), and alewife (*Alosa pseudoharengus*), collectively known as alosines, utilize the river during spawning between late March and mid-May and then as a nursery habitat for young-of-the-year. Alewife and blueback herring are listed by the National Marine Fisheries Service as a Species of Concern. In addition, these species are important to both commercial and recreational fisheries and form an important forage base for other fish and animal species.

Records Pond, just upstream of the project site, forms an impediment to upstream migration, and as a result there is great potential for these species to be concentrated in the study area during the

spring spawning run. No in-water work or work that produces noise in the water column should take place from March 15th to June 1st to avoid affecting these species.

Also, alosines are very sensitive to changes in their natural environment and if in-water or shoreline work is proposed, efforts should be made to: 1) minimize noise transmitted into the water column (i.e. driving piles) as not to interrupt their migration upstream, 2) minimize sedimentation, 3) maintain adequate shoreline buffers to protect water quality and 4) minimize the replacement of natural shoreline with hard materials (i.e. rip-rap, bulkheads, etc.) when feasible.

Largemouth Bass

In addition, there is a viable resident Largemouth Bass population in Broad Creek that supports the state's most popular freshwater fishery. Bass are a nest building species, and in tidal rivers they spawn in shallow areas out of the current in coves, marina basins, and backwaters found near spillpools, such as that by Records Pond. An acoustically tagged bass was detected on a receiver installed near the Records spillway in the spring of 2019, which coincides with the spawning season. The movement of bass through the project area to the spillway for spawning likely overlaps with anadromous fish species, so the time of year restriction requested above should also minimize impacts to Largemouth Bass.

Delaware Ecological Network

Habitat at this project site has been identified as ecologically important by the Delaware Ecological Network (DEN). The DEN, although non-regulatory, is a statewide conservation network developed using GIS and field collected datasets that help to identify and prioritize ecologically important areas for natural resource protection. The DEN includes ecologically important areas such as forests, wetlands, streams, habitat that supports rare species and areas of especially high quality. The DEN includes the following key elements: 1) core areas-contain relatively intact natural ecosystems, and provide high-quality habitat for native plants and animals, 2) <a href="https://doi.org/10.1001/journal.org

Drilling

Although the use of a directional drill has less of an impact than other methods, such as trenching, there is still a potential for frac-outs to occur which could impact wetlands and water bodies within the project area. Therefore, we highly recommend that a frac-out contingency plan be in place prior to the start of project activities. The contingency plan should include the following:

- 1. A provision to contain materials released,
- 2. A clean-up protocol, and
- 3. Arrangements for an experienced representative (drilling crew or consultant) to watch the site at all times so that the operation can be shut down immediately in the event a frac-out occurs.

In addition, on-site staff should have access to the DNREC 24-hour hotline phone number (1-800-662-8802) to report any environmental release or fish kill. Immediate notification of any

environmental release is imperative. Please also contact Bruce Cole, Fisheries Biologist, at Bruce.Cole@delaware.gov or 302-735-2961.

We are continually updating our records on Delaware's rare, threatened and endangered species, unique natural communities and other significant natural resources. If the start of the project is delayed more than a year past the date of this letter, please contact us again for the latest information.

Please feel free to contact me with any questions or if you require additional information.

Sincerely,

Danielle Ellis

Environmental Review Coordinator

anielle Elis

Phone: (302) 223-2446

6180 Hay Point Landing Road

Smyrna, DE 19977

(See invoice on next page)

INVOICE - PAYMENT DUE

It is our policy to charge a fee for this environmental review service. This letter constitutes an invoice for \$70.00 (\$35.00/hour for a minimum of one hour). Please make your check payable to "Delaware Division of Fish and Wildlife" and submit to:

DE Division of Fish and Wildlife 97 Commerce Way Suite 106 Dover, DE 19901 ATTN: DFW Fiscal

In order for us to properly process your payment, you must reference "ETECH 2022 Chesapeake Utilities Gas Main Replace" on your check.

cc: Division of Fish and Wildlife Fiscal (dnrec dfw payroll@delaware.gov); Code to 72900



United States Department of the Interior

U.S. Fish & Wildlife Service Chesapeake Bay Field Office 177 Admiral Cochrane Drive Annapolis, MD 21401 410/573 4575



Online Certification Letter

Today's date:	4/12/2022
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Project: Chesapeake Utilities-Broad Creek Main Replacement

Dear Applicant for online certification:

Thank you for using the U.S. Fish and Wildlife Service (Service) Chesapeake Bay Field Office online project review process. By printing this letter in conjunction with your project review package, you are certifying that you have completed the online project review process for the referenced project in accordance with all instructions provided, using the best available information to reach your conclusions. This letter, and the enclosed project review package, completes the review of your project in accordance with the Endangered Species Act of 1973 (16 U.S.C. 1531-1544, 87 Stat. 884), as amended (ESA). This letter also provides information for your project review under the National Environmental Policy Act of 1969 (P.L. 91-190, 42 U.S.C. 4321-4347, 83 Stat. 852), as amended. A copy of this letter and the project review package must be submitted to this office for this certification to be valid. This letter and the project review package will be maintained in our records.

Based on this information and in accordance with section 7 of the Endangered Species Act (87 Stat. 884, as amended; 16 U.S.C. 1531 et seq.), we certify that except for occasional transient individuals, no federally listed endangered or threatened species are known to exist within the project area. Therefore, no Biological Assessment or further section 7 consultation with the U.S. Fish and Wildlife Service is required. Should project plans change, or if additional information on the distribution of listed or proposed species becomes available, this determination may be reconsidered.

This response relates only to federally protected threatened or endangered species under our jurisdiction. For additional information on threatened or endangered species in Maryland, you should contact the Maryland Wildlife and Heritage Division at (410) 260-8573. For information in Delaware you should contact the Delaware Division of Fish and Wildlife, Wildlife Species Conservation and Research Program at (302) 735-8658. For information in the District of Columbia, you should contact the National Park Service at (202) 339-8309.

The U.S. Fish and Wildlife Service also works with other Federal agencies and states to minimize loss of wetlands, reduce impacts to fish and migratory birds, including bald eagles, and restore habitat for wildlife. Information on these conservation issues and how development projects can avoid affecting these resources can be found on our website (www.fws.gov/chesapeakebay)

We appreciate the opportunity to provide information relative to fish and wildlife issues, and thank you for your interest in these resources. If you have any questions or need further assistance, please contact Chesapeake Bay Field Office Threatened and Endangered Species program at (410) 573-4527.

Sincerely,

Genevieve LaRouche Field Supervisor



United States Department of the Interior



FISH AND WILDLIFE SERVICE

Chesapeake Bay Ecological Services Field Office 177 Admiral Cochrane Drive Annapolis, MD 21401-7307 Phone: (410) 573-4599 Fax: (410) 266-9127

http://www.fws.gov/chesapeakebay/

http://www.fws.gov/chesapeakebay/endsppweb/ProjectReview/Index.html

In Reply Refer To: April 12, 2022

Project Code: 2022-0030936

Project Name: Chesapeake Utilities - Garth Jones

Subject: List of threatened and endangered species that may occur in your proposed project

location or may be affected by your proposed project

To Whom It May Concern:

The enclosed species list identifies threatened, endangered, proposed and candidate species, as well as proposed and final designated critical habitat, that may occur within the boundary of your proposed project and/or may be affected by your proposed project. The species list fulfills the requirements of the U.S. Fish and Wildlife Service (Service) under section 7(c) of the Endangered Species Act (Act) of 1973, as amended (16 U.S.C. 1531 *et seq.*).

New information based on updated surveys, changes in the abundance and distribution of species, changed habitat conditions, or other factors could change this list. Please feel free to contact us if you need more current information or assistance regarding the potential impacts to federally proposed, listed, and candidate species and federally designated and proposed critical habitat. Please note that under 50 CFR 402.12(e) of the regulations implementing section 7 of the Act, the accuracy of this species list should be verified after 90 days. This verification can be completed formally or informally as desired. The Service recommends that verification be completed by visiting the ECOS-IPaC website at regular intervals during project planning and implementation for updates to species lists and information. An updated list may be requested through the ECOS-IPaC system by completing the same process used to receive the enclosed list.

The purpose of the Act is to provide a means whereby threatened and endangered species and the ecosystems upon which they depend may be conserved. Under sections 7(a)(1) and 7(a)(2) of the Act and its implementing regulations (50 CFR 402 *et seq.*), Federal agencies are required to utilize their authorities to carry out programs for the conservation of threatened and endangered species and to determine whether projects may affect threatened and endangered species and/or designated critical habitat.

A Biological Assessment is required for construction projects (or other undertakings having similar physical impacts) that are major Federal actions significantly affecting the quality of the human environment as defined in the National Environmental Policy Act (42 U.S.C. 4332(2) (c)). For projects other than major construction activities, the Service suggests that a biological evaluation similar to a Biological Assessment be prepared to determine whether the project may affect listed or proposed species and/or designated or proposed critical habitat. Recommended contents of a Biological Assessment are described at 50 CFR 402.12.

If a Federal agency determines, based on the Biological Assessment or biological evaluation, that listed species and/or designated critical habitat may be affected by the proposed project, the agency is required to consult with the Service pursuant to 50 CFR 402. In addition, the Service recommends that candidate species, proposed species and proposed critical habitat be addressed within the consultation. More information on the regulations and procedures for section 7 consultation, including the role of permit or license applicants, can be found in the "Endangered Species Consultation Handbook" at:

http://www.fws.gov/endangered/esa-library/pdf/TOC-GLOS.PDF

Migratory Birds: In addition to responsibilities to protect threatened and endangered species under the Endangered Species Act (ESA), there are additional responsibilities under the Migratory Bird Treaty Act (MBTA) and the Bald and Golden Eagle Protection Act (BGEPA) to protect native birds from project-related impacts. Any activity, intentional or unintentional, resulting in take of migratory birds, including eagles, is prohibited unless otherwise permitted by the U.S. Fish and Wildlife Service (50 C.F.R. Sec. 10.12 and 16 U.S.C. Sec. 668(a)). For more information regarding these Acts see https://www.fws.gov/birds/policies-and-regulations.php.

The MBTA has no provision for allowing take of migratory birds that may be unintentionally killed or injured by otherwise lawful activities. It is the responsibility of the project proponent to comply with these Acts by identifying potential impacts to migratory birds and eagles within applicable NEPA documents (when there is a federal nexus) or a Bird/Eagle Conservation Plan (when there is no federal nexus). Proponents should implement conservation measures to avoid or minimize the production of project-related stressors or minimize the exposure of birds and their resources to the project-related stressors. For more information on avian stressors and recommended conservation measures see https://www.fws.gov/birds/bird-enthusiasts/threats-to-birds.php.

In addition to MBTA and BGEPA, Executive Order 13186: *Responsibilities of Federal Agencies to Protect Migratory Birds*, obligates all Federal agencies that engage in or authorize activities that might affect migratory birds, to minimize those effects and encourage conservation measures that will improve bird populations. Executive Order 13186 provides for the protection of both migratory birds and migratory bird habitat. For information regarding the implementation of Executive Order 13186, please visit https://www.fws.gov/birds/policies-and-regulations/executive-orders/e0-13186.php.

We appreciate your concern for threatened and endangered species. The Service encourages Federal agencies to include conservation of threatened and endangered species into their project planning to further the purposes of the Act. Please include the Consultation Code in the header of

this letter with any request for consultation or correspondence about your project that you submit to our office.

Attachment(s):

- Official Species List
- USFWS National Wildlife Refuges and Fish Hatcheries
- Wetlands

Official Species List

This list is provided pursuant to Section 7 of the Endangered Species Act, and fulfills the requirement for Federal agencies to "request of the Secretary of the Interior information whether any species which is listed or proposed to be listed may be present in the area of a proposed action".

This species list is provided by:

Chesapeake Bay Ecological Services Field Office 177 Admiral Cochrane Drive Annapolis, MD 21401-7307 (410) 573-4599

Project Summary

Project Code: 2022-0030936

Event Code: None

Project Name: Chesapeake Utilities - Garth Jones

Project Type: Pipeline - Offshore - Maintenance / Modification

Project Description: 4 inch - Pipe Replacement

Project Location:

Approximate location of the project can be viewed in Google Maps: https://www.google.com/maps/@38.558243149999996,-75.56961606593225,14z



Counties: Sussex County, Delaware

Endangered Species Act Species

There is a total of 1 threatened, endangered, or candidate species on this species list.

Species on this list should be considered in an effects analysis for your project and could include species that exist in another geographic area. For example, certain fish may appear on the species list because a project could affect downstream species. Note that 1 of these species should be considered only under certain conditions.

IPaC does not display listed species or critical habitats under the sole jurisdiction of NOAA Fisheries¹, as USFWS does not have the authority to speak on behalf of NOAA and the Department of Commerce.

See the "Critical habitats" section below for those critical habitats that lie wholly or partially within your project area under this office's jurisdiction. Please contact the designated FWS office if you have questions.

NOAA Fisheries, also known as the National Marine Fisheries Service (NMFS), is an
office of the National Oceanic and Atmospheric Administration within the Department of
Commerce.

Insects

NAME STATUS

Monarch Butterfly Danaus plexippus

Candidate

No critical habitat has been designated for this species.

This species only needs to be considered under the following conditions:

• The monarch is a candidate species and not yet listed or proposed for listing. There are generally no section 7 requirements for candidate species (FAQ found here: https://www.fws.gov/savethemonarch/FAQ-Section7.html).

Species profile: https://ecos.fws.gov/ecp/species/9743

Critical habitats

THERE ARE NO CRITICAL HABITATS WITHIN YOUR PROJECT AREA UNDER THIS OFFICE'S JURISDICTION.

USFWS National Wildlife Refuge Lands And Fish Hatcheries

Any activity proposed on lands managed by the <u>National Wildlife Refuge</u> system must undergo a 'Compatibility Determination' conducted by the Refuge. Please contact the individual Refuges to discuss any questions or concerns.

THERE ARE NO REFUGE LANDS OR FISH HATCHERIES WITHIN YOUR PROJECT AREA.

04/12/2022

Wetlands

Impacts to <u>NWI wetlands</u> and other aquatic habitats may be subject to regulation under Section 404 of the Clean Water Act, or other State/Federal statutes.

For more information please contact the Regulatory Program of the local <u>U.S. Army Corps of Engineers District</u>.

Please note that the NWI data being shown may be out of date. We are currently working to update our NWI data set. We recommend you verify these results with a site visit to determine the actual extent of wetlands on site.

RIVERINE

■ <u>R1UBV</u>

04/12/2022

IPaC User Contact Information

Agency: Envirotech Environmental Consulting, Inc.

Name: Kieran Burns

Address: 17605 Nassau Commons Blvd

Address Line 2: Unit D City: Lewes State: DE Zip: 19958

Email kieran@envirotechecinc.com

Phone: 3026845201



Delaware Division of Historical & Cultural Affairs

29 N. State St., Dover, Delaware 19901 Tel. (302) 736-7400 | Fax. (302) 739-5660 history.delaware.gov

May 17, 2022

Kieran Burns Envirotech Environmental Consulting, Inc. 17605 Nassau Commons Boulevard, Unit D Lewes, DE 19958

Subject: Chesapeake Utilities Gas Main Replacement

SHPO Project No. 2022.04.14.04

Dear Mr. Burns:

We understand from your letter that the applicant is seeking a permit from the US Army Corps of Engineers (USACOE) for the replacement of a 4-inch steel gas main located on Broad Creek, E Front Street, and Delaware Avenue in Laurel. The 4-inch steel gas main is entirely within DelDOT Right-of-Way (ROW) and will be replaced with a 4-inch high-density polyethylene (HDPE) pipe. Because of the need for authorization from the USACOE, the project is subject to compliance with Section 106 of the National Historic Preservation Act of 1966 (as amended).

The Area of Potential Effect (APE) is within the Laurel Historic District (S07656), which is listed on the National Register of Historic Places (NRHP). However, there are no contributing buildings within or abutting the APE. State Bridge 162 (S13262) is within the APE but has previously been determined not eligible for listing in the NRHP. The APE is within DelDOT ROW and will be following previous utility disturbance. As such, there is low potential for any intact archaeological resources. We find the proposed undertaking to have No Adverse Effect on the Laurel Historic District provided that construction plans caution contractors to avoid historic buildings. Should plans change, additional consultation may be necessary. If damage occurs to historic structures during replacement, please contact this Office immediately so appropriate mitigation can take place.

Please feel free to contact me if you have any questions at (302) 736-7431 or sarah.carr@delaware.gov.

Sincerely,

Sarah Carr

Cultural Preservation Specialist

cc: Gwen Davis, Deputy SHPO John Martin, DelDOT

