

State of Delaware Department of Natural Resources and Environmental Control Delaware Division of Parks and Recreation 89 Kings Highway Dover, Delaware 19901

Auburn Heights Preserve (AHP) Farm Lane and Paper Mill Bridges Design Narrative

Introduction

DNREC's Division of Parks and Recreation is planning to redevelop the Auburn Mill Historic District as part of the Auburn Valley Master Plan. The planned improvements in this area will provide safe pedestrian travel routes between the proposed parking areas and nearby historic landmarks and complete a critical link to the existing recently completed trail networks, which are key components to the Master Plan vision.

Existing Conditions

The Auburn Mill Historic District is bounded by Creek Road (Route 82) to the North and Red Clay Creek and Mill Race to the West, East and South. Existing Farm Lane is a gravel road, leading to an existing bridge over Red Clay Creek and a number of existing residences. Mill Race runs adjacent to Farm Lane, supplying water for the existing paper mill. East of the existing entrance to Farm Lane off of Benge Road is an existing concrete settling tank.

Proposed Conditions

The proposed redevelopment includes the following improvements that are set to occur in two phases:

Phase I – Construction In Fall 2017

- Paper Mill Bridge which includes (2) proposed abutments and wing walls
- Paper Mill Deck over structure at Mill Race
- Farm Lane Asphalt parking lot, and parking lot along Benge Road
- Paper Mill asphalt parking lot on top of existing settling tank
- Marshall Steam Museum access road, sidewalk and asphalt parking lot


Phase II – Construction To Be Completed In The Near Future


- Farm Lane Bridge Replacement which includes two (2) proposed abutments and wing walls
- Farm Lane Culvert over Mill Race

The above improvements will provide expanded access to and additional parking for the Marshall Steam Museum, nearby residences, and the existing trail system as part of the Auburn Valley Master Plan. See the attached plans for your use.

F:\odd\ODD PROJECT FILES\NVF\NVF-4 Auburn Hts & Marshall Site & Entrance(RK&K_JT_HAR)\5 Permits\DFM\160407 60% Sub



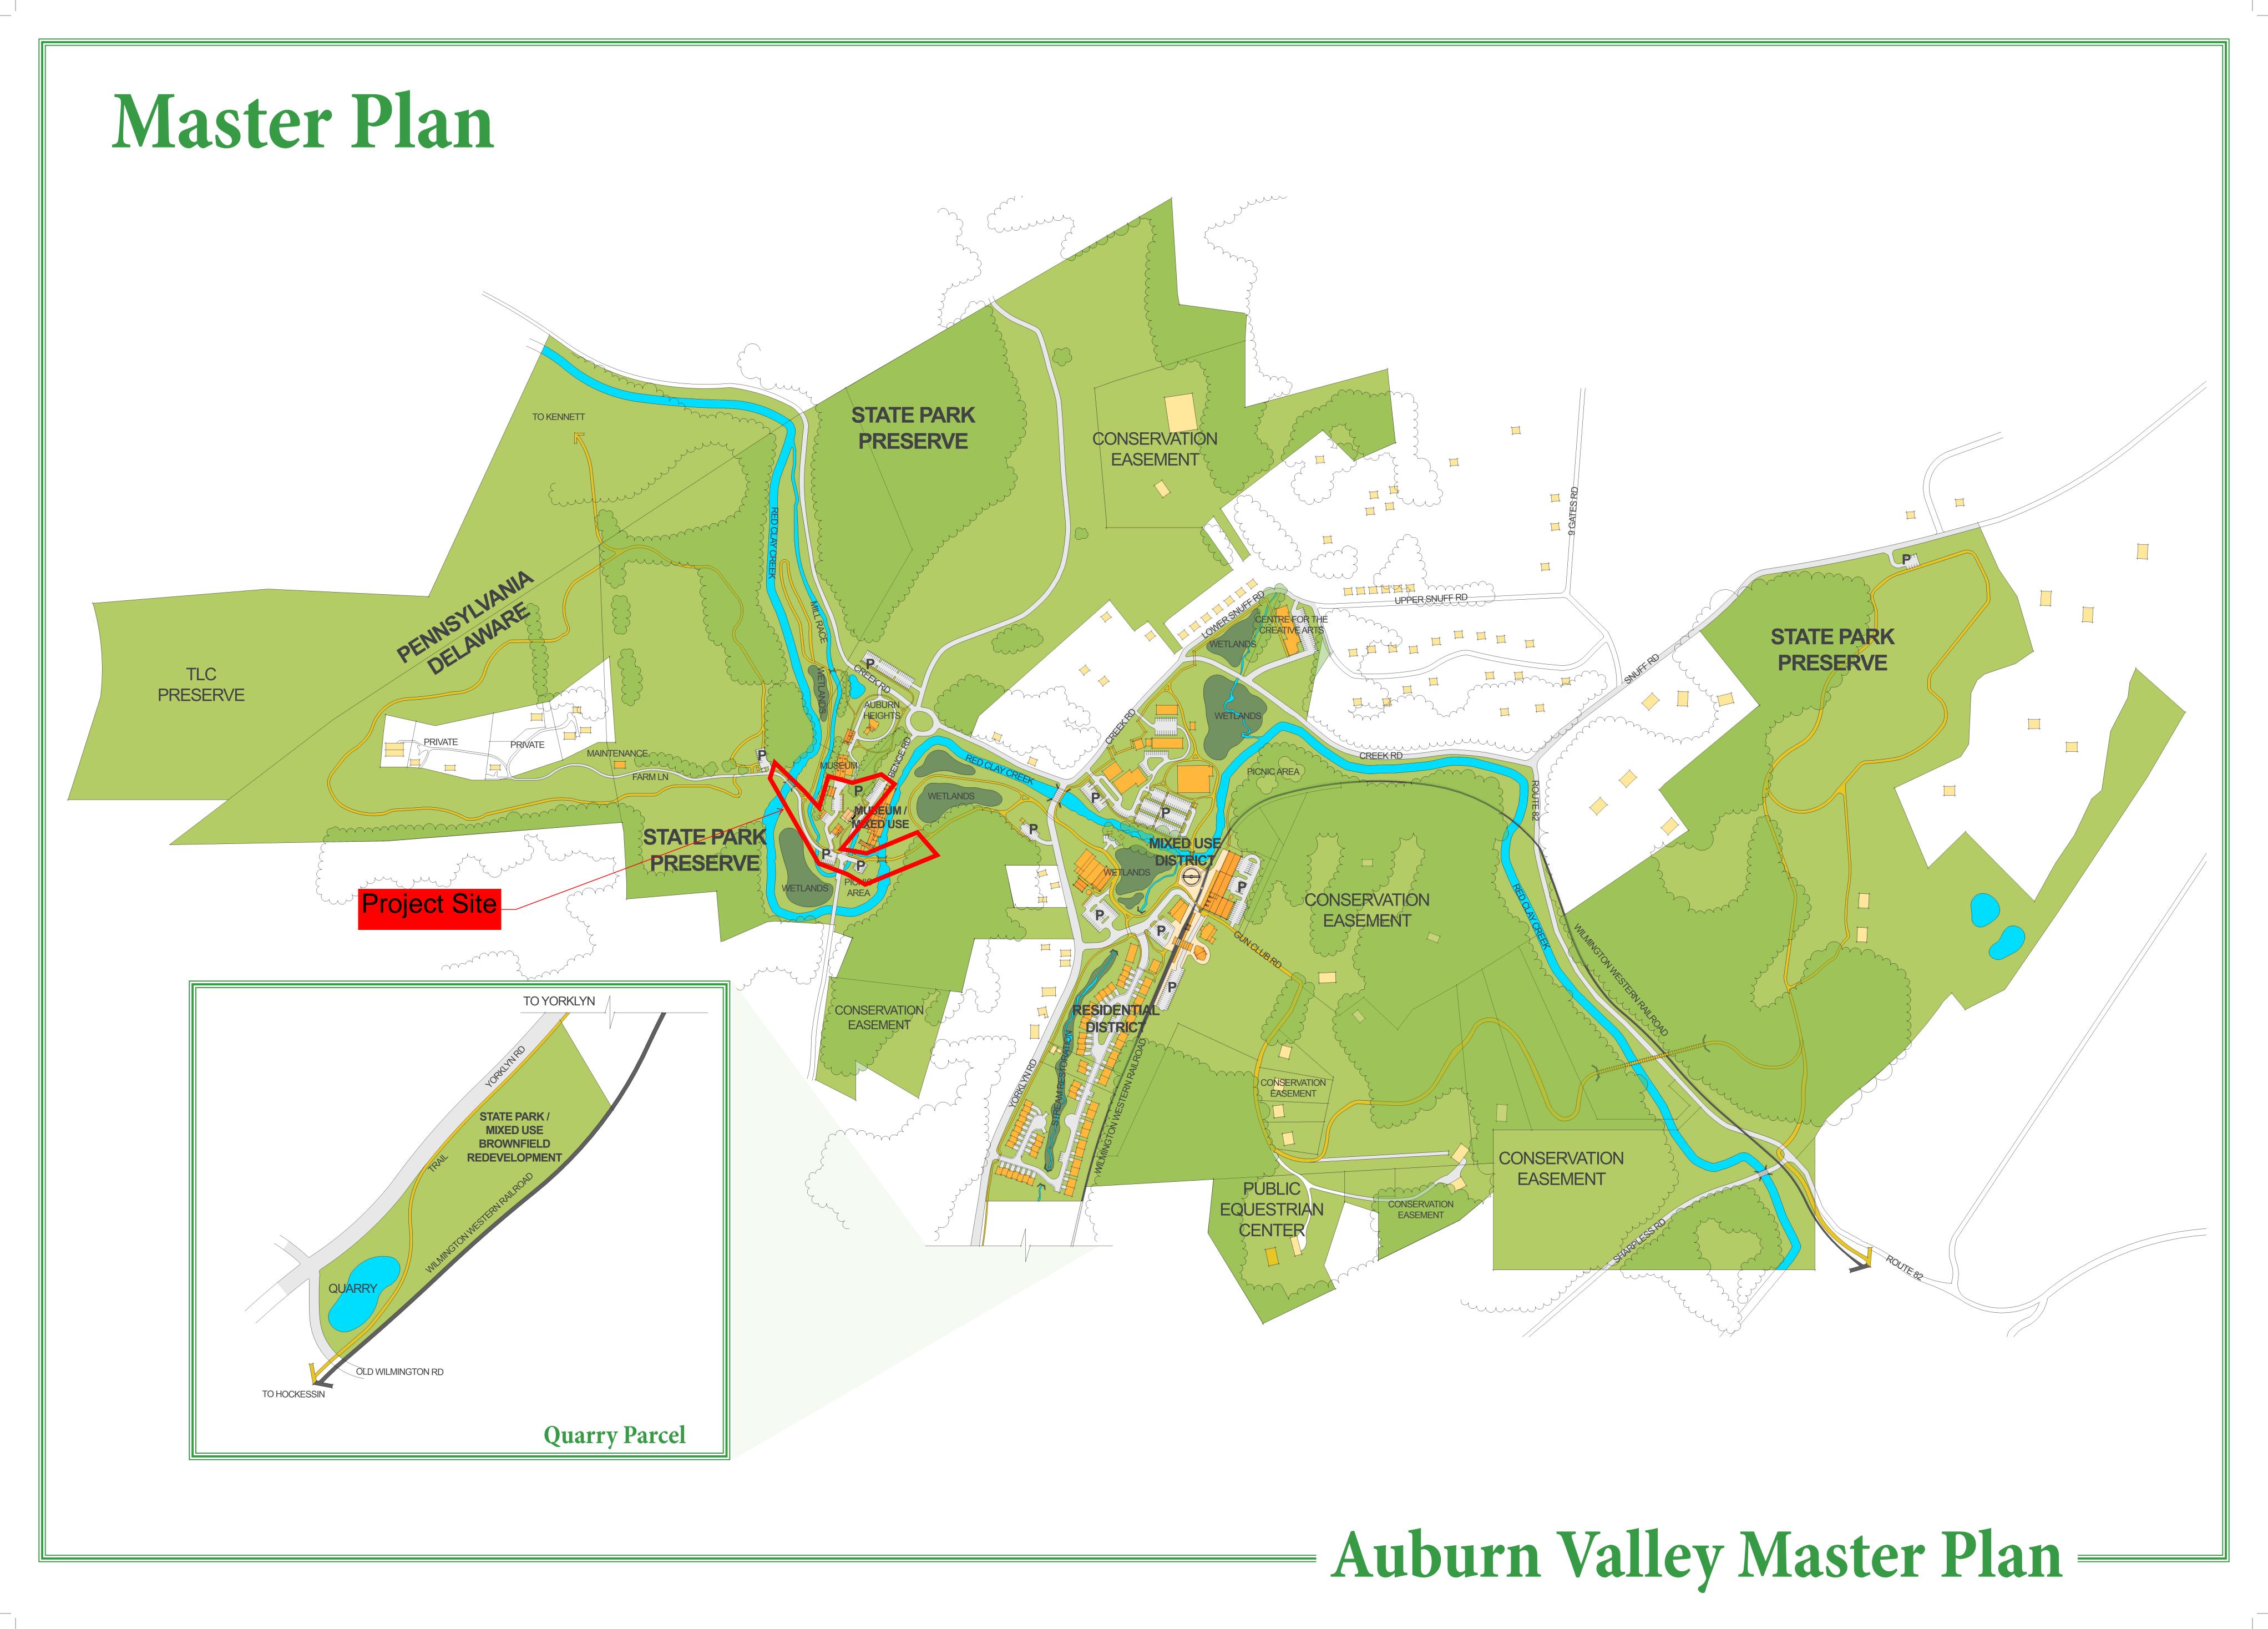


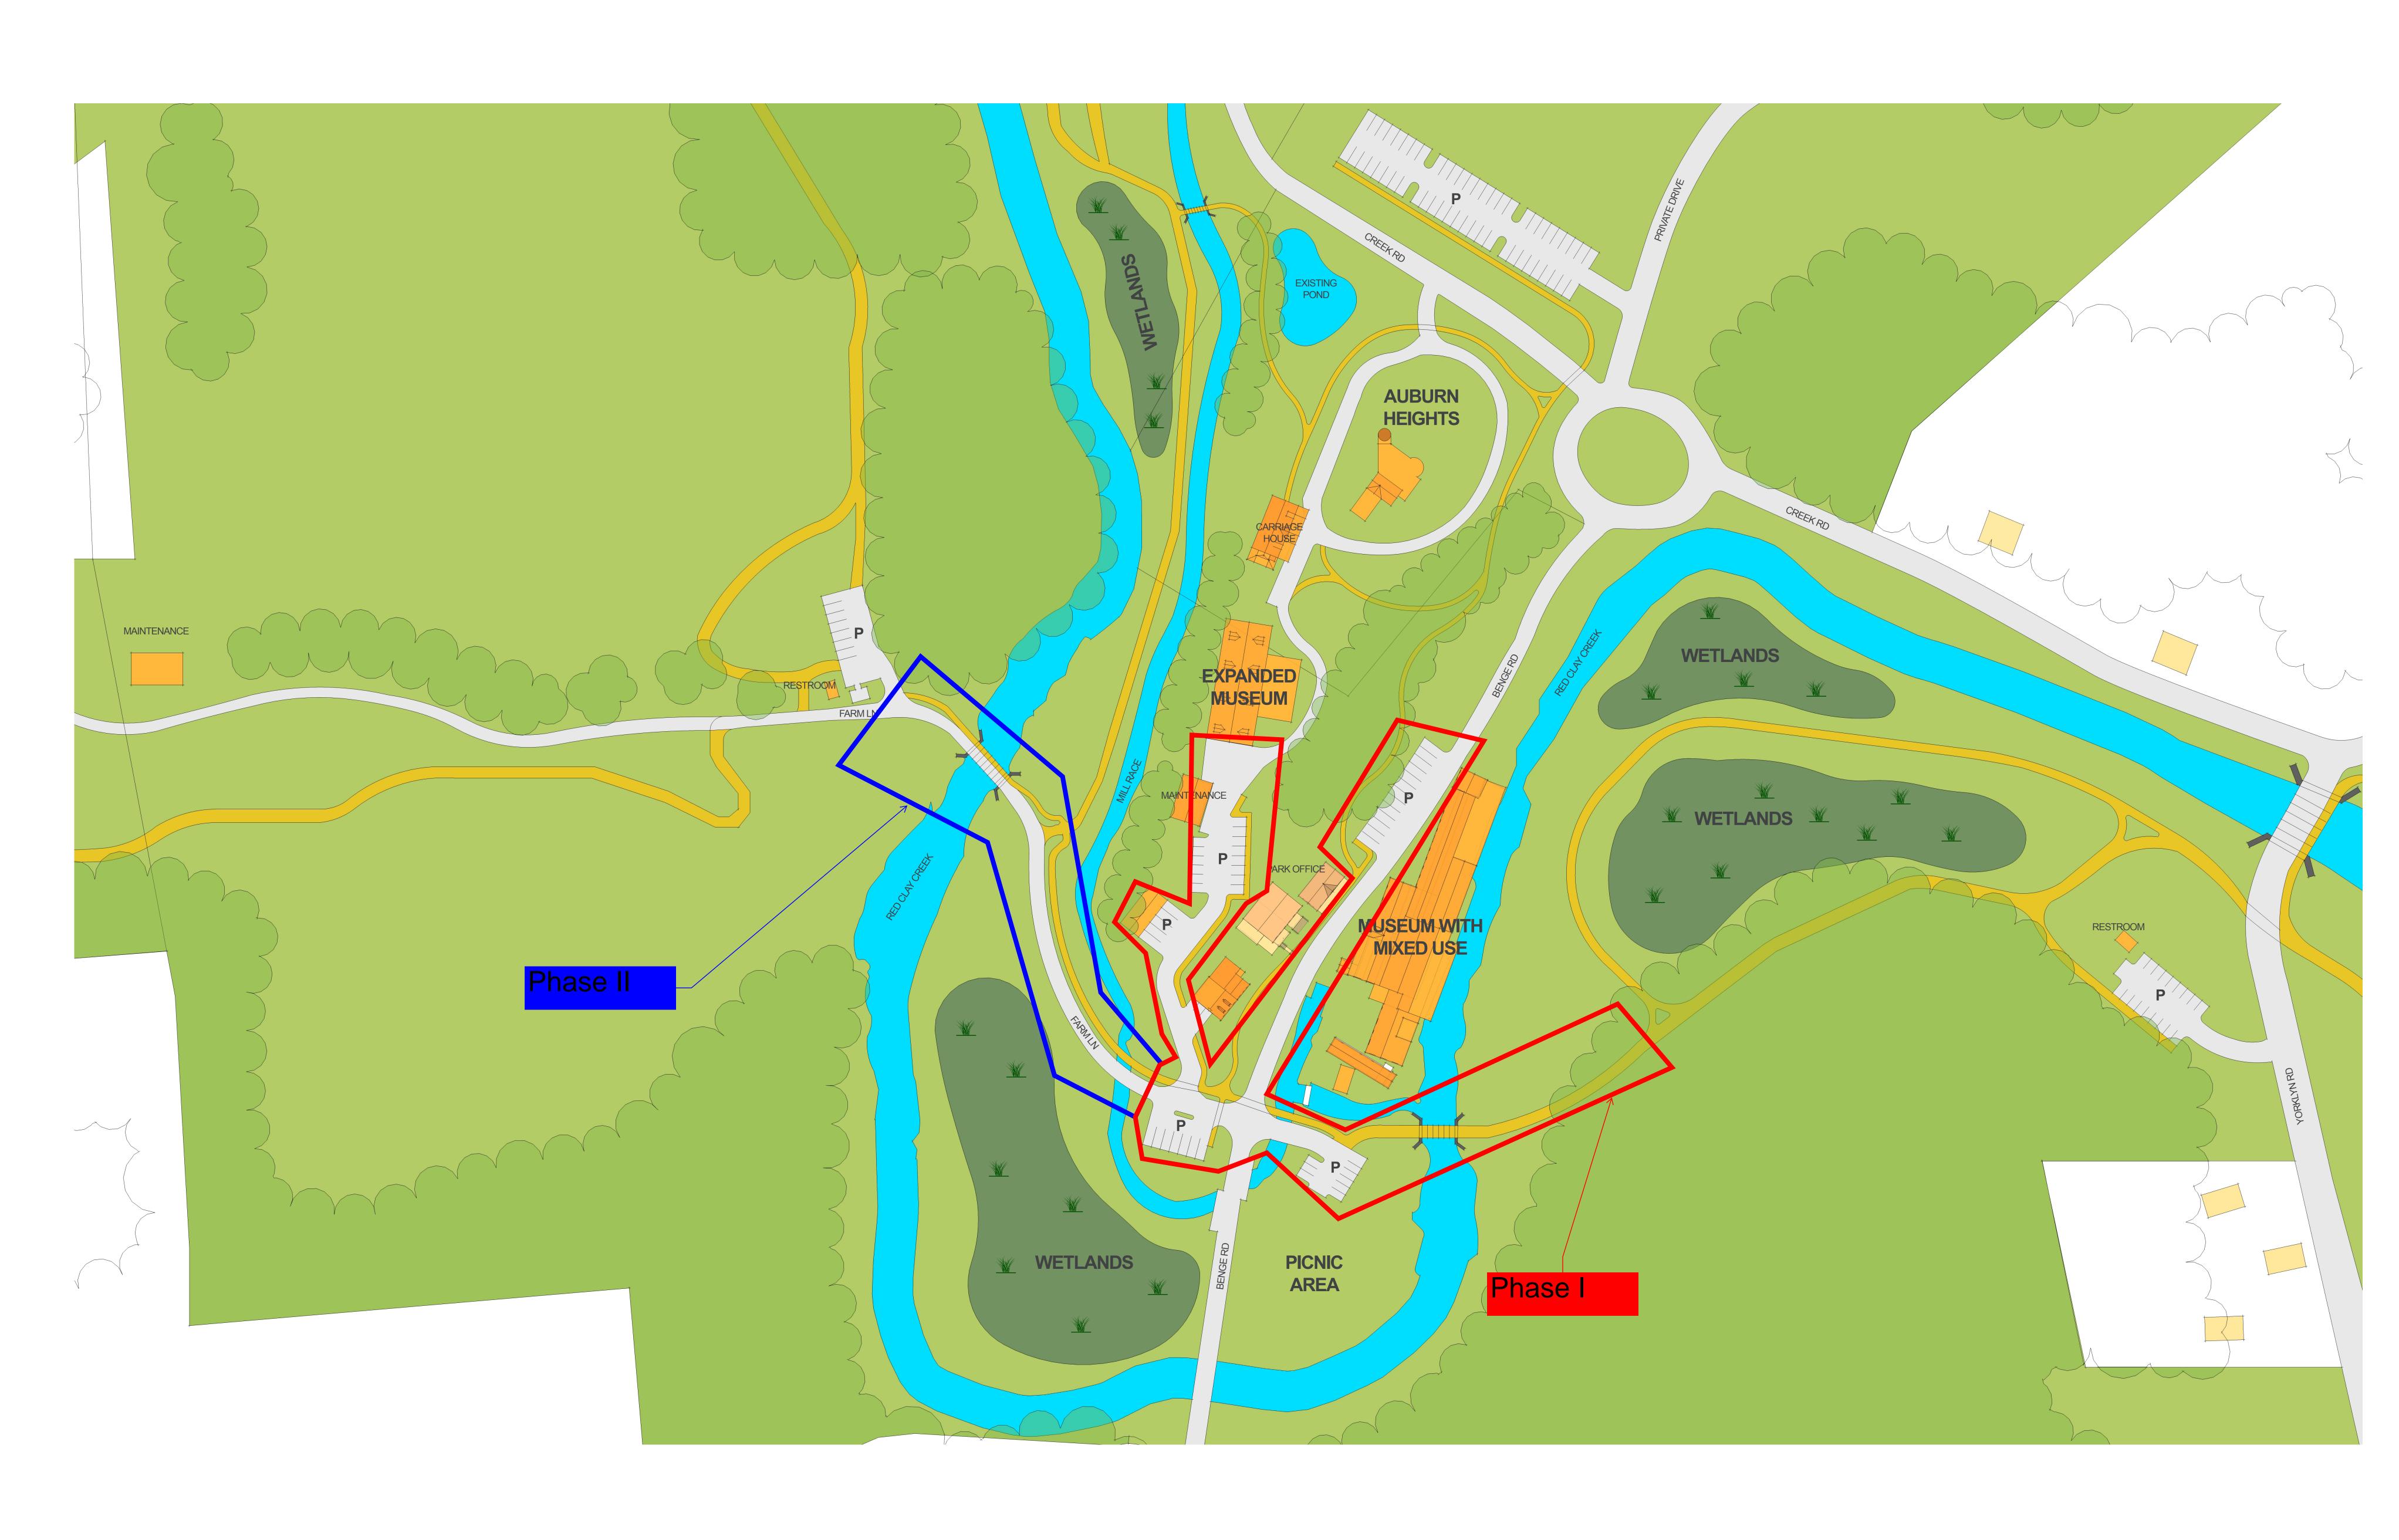


STATE OF DELAWARE DEPARTMENT OF NATURAL RESOURCES AND ENVIRONMENTAL CONTROL DIVISION OF PARKS & RECREATION

AUBURN HEIGHTS PRESERVE PAPER MILL BRIDGE


JUNE 30, 2017

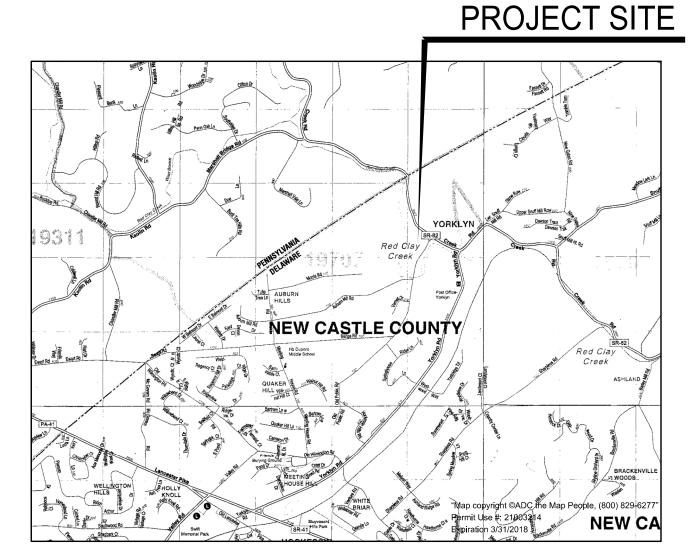


SITE MAP

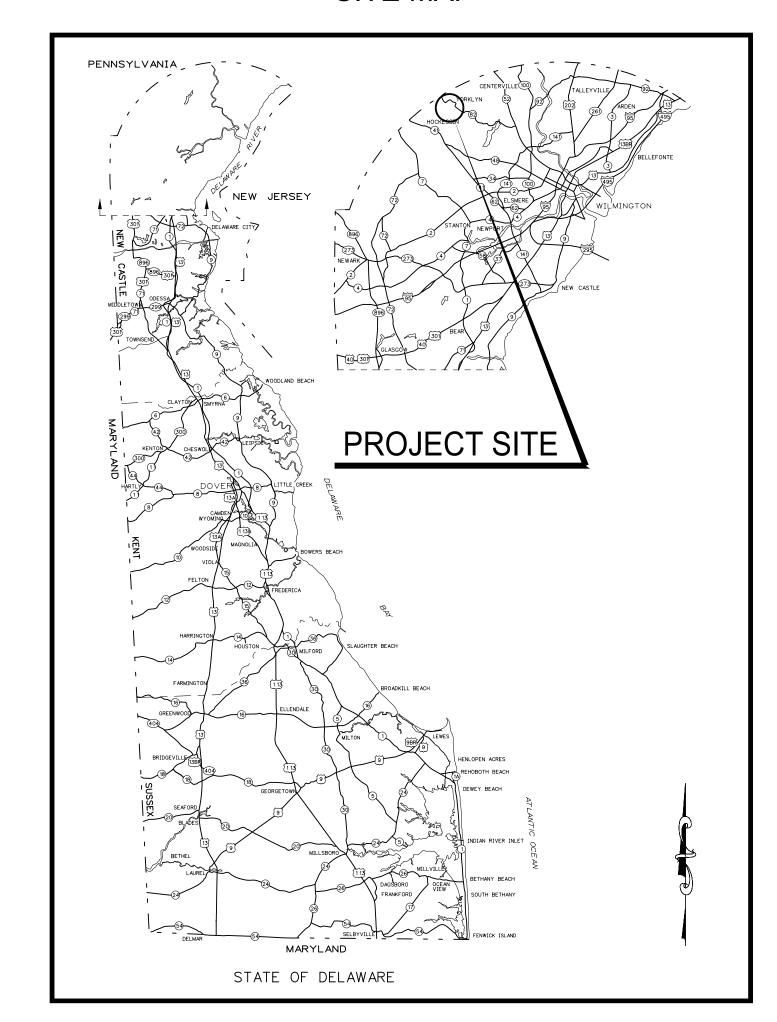

LOCATION MAP

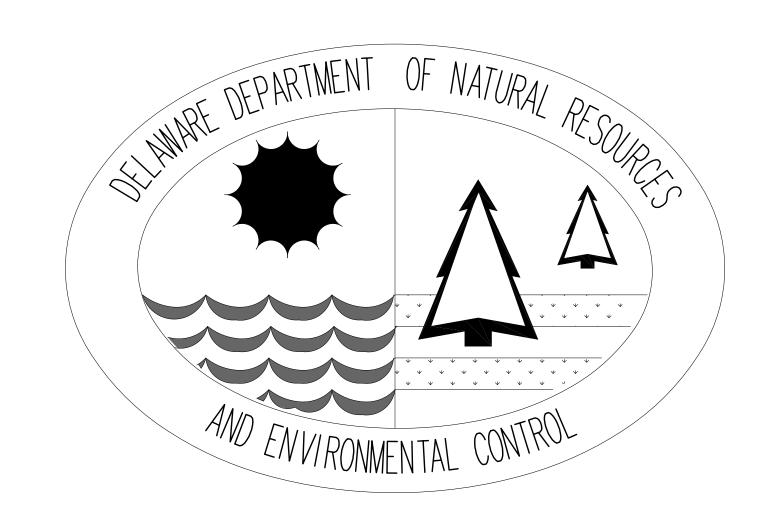

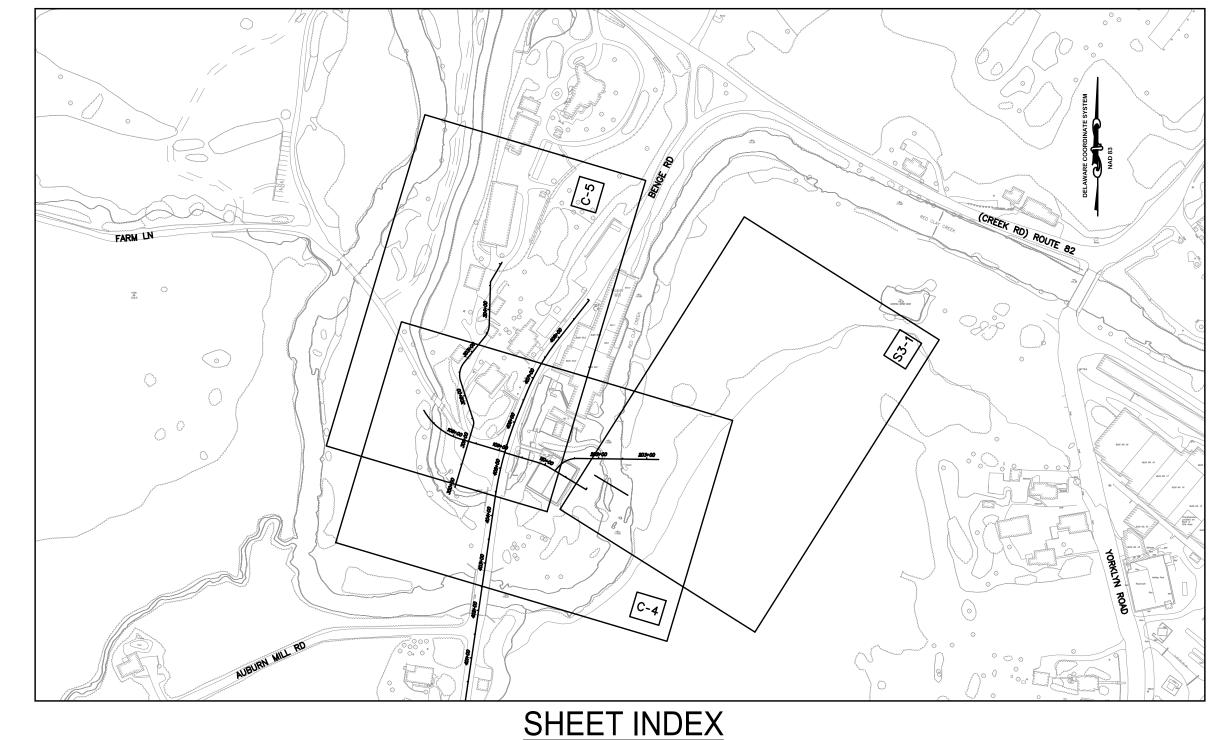

SCALE: 1"=200'

INDEX OF SHEETS		
SHEET NO.:	TITLE	
C-1	GENERAL NOTES & LEGEND	
C-2	HORIZONTAL AND VERTICAL CONTROL PLAN	
C-3	TYPICAL SECTIONS	
C-4 TO C-5	CONSTRUCTION PLANS	
C-6 TO C-8	PROFILES	
C-9	FARM LANE & PAPER MILL PARKING LOTS LAYOUT PLAN	
C-10	MUSEUM DRIVE PARKING LOT LAYOUT PLAN	
C-11	DEMOLITION PLAN	
C-12	SETTLING TANK DETAIL	
C-13 TO C-15	CONSTRUCTION DETAILS	
C-16 TO C-17	SIGNING AND STRIPING PLANS	
C-18 TO C-19	ENTRANCE PLANS	
C-20	OVERALL SITE PLAN	
ES-1	CONSTRUCTION SEQUENCING & EROSION AND SEDIMENT CONTROL NOTES	
ES-2 TO ES-3	CONSTRUCTION SEQUENCING & EROSION AND SEDIMENT CONTROL PLANS	
ES-4 TO ES-7	CONSTRUCTION SEQUENCING & EROSION AND SEDIMENT CONTROL DETAILS	
SN-1	STRUCTURAL GENERAL NOTES	
S1-1 TO S1-5	PAPER MILL BRIDGE PLANS	
S2-1 TO S2-2	MILL RACE DECKOVER STRUCTURE PLANS	
SD-1 TO SD-4	STRUCTURAL DETAILS	
SHEE	TS PREPARED BY CENTURY ENGINEERING INC.	
SHEET NO.:	TITLE	
S3-1	CONNECTOR BOARDWALK PLAN, ELEVATION, SECTION	
S3-2	CONNECTOR BOARDWALK ALIGNMENT, PROFILE, SCHEDULES	
S3-3	CONNECTOR BOARDWALK DETAILS: OVERLOOK, RAILING, SECTIONS	
SHEETS PREPARED BY OWNER		
SHEET NO.:	TITLE	
P-1	BENGE ROAD PARKING LOT EXISTING CONDITIONS	
P-2	BENGE ROAD PARKING LOT PROPOSED CONDITIONS	
P-3	BENGE ROAD PARKING LOT STRIPING PLAN	
R-1	RAILING DETAILS	

FOR INFORMATION ONLY
SHEET NO.: TITLE
THE MCINTYRE IRON BRIDGE (PAPER MILL ROAD BRIDGE)

LEGEND

CONSTRUCTION PLAN



PREPARED FOR:
OFFICE OF DESIGN & DEVELOPMENT
DELAWARE DIVISION OF PARKS & RECREATION
89 KINGS HIGHWAY
DOVER, DELAWARE 19901
PHONE: 302-739-9231
FAX: (302) 739-7026

DATE: JUNE 30, 2017

6/30/201/ 11:30:19 AM \\BALSRV01\V2014\2014\14078_DNREC\TASK 10 - MB_N

GENERAL NOTES

- BEFORE EXCAVATION IS STARTED IN AREAS OF UNDERGROUND UTILITIES, THE CONTRACTOR SHALL GIVE NOTIFICATION BY TELEPHONE, CALLING "MISS UTILITY", TEL. (800) 282-8555. THE CONTRACTOR IS ADVISED THAT MISS UTILITY HAS REFUSED TO LOCATE UTILITIES ON PARK PROPERTY IN SOME INSTANCES. THE CONTRACTOR SHALL VERIFY EXACT LOCATIONS OF ALL UTILITIES IN THE FIELD BY EMPLOYING A PROFESSIONAL UTILITY LOCATOR TO FIELD LOCATE EXISTING UTILITIES PRIOR TO ANY EXCAVATION. EXISTING UTILITIES ARE SHOWN ON THE DRAWINGS BASED ON THE BEST INFORMATION AVAILABLE, HOWEVER THIS INFORMATION HAS NOT BEEN FIELD VERIFIED AND IS NOT GUARANTEED. ALL EXISTING UTILITIES SHALL BE PROTECTED AND TEMPORARILY SUPPORTED OR RELOCATED AS NECESSARY TO COMPLETE THE WORK IN ACCORDANCE WITH THE PERTINENT UTILITY COMPANY REQUIREMENTS. ALL COSTS SHALL BE INCIDENTAL TO THE CONTRACT
- 2. THE CONTRACTOR SHALL DESIGNATE A PERSON WHO SHALL BE RESPONSIBLE FOR IMPLEMENTING AND MAINTAINING THE EROSION AND SEDIMENT CONTROL PLANS, AND A PERSON WHO SHALL BE RESPONSIBLE FOR WORK SAFETY. THE PERSON RESPONSIBLE FOR IMPLEMENTING AND MAINTÁINING THE EROSION AND SEDIMENT CONTROL PLANS SHALL BE CERTIFIED BY DNREC FOR EROSION AND SEDIMENT CONTROL RESPONSIBILITY (CERTIFIED CONSTRUCTION REVIEWER, CCR). THE CONTRACTOR SHALL PROVIDE CCR INSPECTION REPORTS CERTIFIED BY AN ENGINEER LICENSED IN THE STATE OF DELAWARE
- 3. THE CONTRACTOR IS RESPONSIBLE FOR SECURING THE AREA WITHIN THE LIMITS OF DISTURBANCE TO PROHIBIT GENERAL PUBLIC ACCESS UNTIL COMPLETION OF THE PROJECT. THE CONTRACTOR SHALL NOTE THAT ACCESS TO THE PRIVATE RESIDENCES SHALL BE MAINTAINED AT ALL TIMES THROUGHOUT THE DURATION OF THE PROJECT. THE CONTRACTOR'S PROCEDURE/METHOD FOR LIMITING ACCESS SHALL BE REVIEWED BY, AND COORDINATED WITH THE OWNER PRIOR TO THE START OF WORK. THE COST SHALL BE INCLUDED IN THE CONTRACT.
- 4. THE LIMIT OF DISTURBANCE SHALL BE AS SHOWN ON THE PLANS. THE CONTRACTOR SHALL NOT WORK OR TRESPASS OUTSIDE OF THE LIMIT OF DISTURBANCE AS SHOWN ON THE PLANS UNLESS OTHERWISE APPROVED BY THE OWNER. THE CONTRACTOR SHALL DELINEATE THE LIMIT OF DISTURBANCE BY PLACING FLAGS AT 25' ON CENTER THROUGHOUT LIMITS OF THE PROJECT.
- 5. APPROVED COVERS TO PREVENT MATERIAL FROM LEAVING THE TRUCKS MUST BE INSTALLED OVER ALL LOADED TRUCKS HAULING BORROW, EXCAVATED MATERIALS, AND/OR FINE AGGREGATES TO OR FROM THE PROJECT SITE OVER STATE MAINTAINED ROADS. THE TRÚCKS SHALL BE FULLY COVERED AND THE COVERS SHALL BE TIED ON THE REAR AND BOTH SIDES TO PREVENT MATERIAL FROM LEAVING THE TRUCK DURING HAULING.
- IN CASE OF CONFLICT BETWEEN THE "MANUFACTURER'S RECOMMENDATIONS" FOR AN APPROVED MATERIAL AND THE GOVERNING "CONTRACT SPECIFICATIONS" FOR THE MATERIAL, THE MORE RESTRICTIVE OF THE TWO SHALL PREVAIL UNLESS OTHERWISE DIRECTED BY THE OWNER.
- 7. THE CONTRACTOR SHALL BE RESPONSIBLE FOR ESTABLISHING, BY SURVEY, ALL POINTS AND LIMIT OF DISTURBANCE LINES NECESSARY FOR CONSTRUCTION OF THE PROJECT. THE CONTRACTOR SHALL ENGAGE A PROFESSIONAL LAND SURVEYOR, REGISTERED IN THE STATE OF DELAWARE, TO PERFORM REQUIRED SURVEYING SERVICES. ALL SURVEY STAKEOUT WORK SHALL BE INCLUDED IN THE CONTRACT.
- 8. THE CONTRACTOR MUST SUBMIT A STAGING PLAN TO THE OWNER FOR APPROVAL PRIOR TO CONSTRUCTION OF THE PROJECT. THE STAGING PLAN SHALL INCLUDE SITE LOCATION, EROSION AND SEDIMENT CONTROLS, AND ALL OTHER INCIDENTALS, AS DIRECTED BY THE OWNER. ALL COSTS ASSOCIATED WITH PREPARING AND IMPLEMENTING THE STAGING PLAN SHALL BE THE RESPONSIBILITY OF THE CONTRACTOR.
- ALL CONSTRUCTION ACCESS SHALL USE THE STABILIZED CONSTRUCTION ENTRANCE. CONSTRUCTION, MAINTENANCE, CLEANING, RE-COMPACTING, REMOVAL AND REPLACEMENT OF THE BASE COURSE MATERIALS FOR THE STABILIZED CONSTRUCTION ENTRANCE SHALL BE IN ACCORDANCE WITH THE APPROVED EROSION AND SEDIMENT CONTROL PLAN AS DIRECTED BY THE CERTIFIED CONSTRUCTION REVIEWER AND THE OWNER. THE CONTRACTOR IS RESPONSIBLE FOR CLEANING THE ROAD AT THE CONSTRUCTION ENTRANCE AT THE END OF EACH WORKING DAY.
- 10. THE CONTRACTOR SHALL PROVIDE NECESSARY RESTROOM FACILITIES FOR WORKERS DURING CONSTRUCTION.
- 11. ALL EXISTING DRAINAGE SYSTEMS SHOWN ARE TO REMAIN OPERATIONAL UNLESS DENOTED FOR ABANDONMENT
- 12. AT THE END OF THIS PROJECT'S CONSTRUCTION, ALL EXISTING DRAINAGE STRUCTURES AND PIPES WITHIN THE PROJECT LIMITS SHALL BE CLEANED OF ALL SEDIMENT AND DEBRÍS IN COMPLIANCE WITH DNREC GUIDELINES AS DIRECTED BY THE OWNER. COST TO BE INCLUDED IN THE BID.
- 13. ALL CONSTRUCTION IS TO BE IN ACCORDANCE WITH THE DELDOT STANDARDS SPECIFICATIONS AND DETAILS DATED 2011, UNLESS OTHERWISE NOTED ON THE PLANS OR IN THE SPECIFICATIONS FOR THIS PROJECT AND AS FOLLOWS. FOR THIS PROJECT DIVISION 100 GENERAL PROVISIONS IN THE DELDOT STANDARD SPECIFICATIONS DOES NOT APPLY. FOR GRADED AGGREGATE BASE COURSE, THE MATERIAL SHALL CONSIST OF CRUSHED STONE, CRUSHED SLAG FRAGMENTS OR PORTLAND CEMENT CONCRETE FRAGMENTS SHALL NOT BE USED AS GRADED AGGREGATE BASE COURSE. THERE WILL BE NO MEASUREMENT FOR PAYMENT EXCEPT WHERE SPECIFICALLY STATED IN THE PLANS AND SPECIFICATIONS FOR THIS PROJECT.
- 14. STAGING AREAS: PROPER EROSION AND SEDIMENT CONTROL MEASURES AS DETERMINED BY THE OWNER SHALL BE INSTALLED IN ALL STAGING AREAS. ALL AREAS USED BY THE CONTRACTOR AND "WORKIN BRIDGES" FOR STAGING OPERATIONS SHALL BE FULLY RESTORED BY THE CONTRACTOR UPON COMPLETION OF THE PROJECT. IF THE STAGING AREA IS PAVED, IT SHALL BE RESTORED TO ITS ORIGINAL CONDITION. IF THE STAGING AREA IS UNPAVED, IT SHALL BE RE-GRADED, TOPSOILED, SEEDED AND MULCHED IN ACCORDANCE WITH THE DELAWARE EROSION AND SEDIMENT CONTROL HANDBOOK, CURRENT VERSION (HEREAFTER KNOWN AS THE HANDBOOK), TO THE SATISFACTION OF THE OWNER. THE SEED SHALL ADHERE TO THE SPECIFICATIONS OF PERMANENT SEED MIX *5 AS NOTED IN THE HANDBOOK, ALL COSTS ASSOCIATED WITH RESTORATION OF THE STAGING AREA(S) SHALL BE AT THE CONTRACTOR'S EXPENSE. IF THE OWNER DETERMINES THAT A SATISFACTORY STAND OF GRASS DOES NOT EXIST AT THE TIME OF FINAL INSPECTION, ALL COSTS ASSOCIATED WITH RE-ESTABLISHING A SATISFACTORY STAND OF GRASS SHALL BE AT THE CONTRACTOR'S EXPENSE.
- 15. A UNIT COST FOR ROCK EXCAVATION (NON-STRUCTURAL) HAS BEEN INCLUDED IN THE PROJECT. THIS EXCAVATION IS FOR AREAS WHERE THE EXCAVATION OF ROCK IS ENCOUNTERED ON THE PROJECT IN AREAS OTHER THAN EXCAVATION FOR STRUCTURES.
- 16. EXCAVATED MATERIALS MEETING THE REQUIREMENTS OF THE DIFFERENT BORROW TYPES ARE INTENDED TO BE USED IN FILL AREAS OF THE PROJECT. THE CONTRACTOR SHALL BE REQUIRED TO HAVE THE MATERIAL TESTED. ALL UNUSED MATERIAL SHALL BE EMBANKED AT A LOCATION ON PARK OWNED PROPERTY AT THE DIRECTION OF THE OWNER. THE LOCATION SHALL BE WITHIN 5 MILES OF THE PROJECT. THE CONTRACTOR SHALL BE RESPONSIBLE FOR ALL EROSION AND SEDIMENT CONTROL, AND SEEDING AND MULCHING. ALL COST ASSOCIATED WITH PERFORMING THIS WORK SHALL BE INCLUDED IN THE LUMP SUM BID FOR THE

LEGEND

PROPOSED CONSTRUCTION



—— 185—— CONTOURS (FEET) <───X DITCH CENTERLINE \times 190.5 **SPOT ELEVATION**

-- LOD -- LIMIT OF DISTURBANCE

GAS

————— CONSTRUCTION BASELINE

C	CUT		(DND)	DO NOT DISTURB
F	FILL		$\frac{RM}{C}$	REMOVE BY CONTRACTOR
	CURB, TYPE I	A		
	CURB, TYPE 2		(C-12)-	SECTION LINE
	BARRIER		<u>C-16</u>	DETAIL REFERENCE
	GUARDRAIL			


EXISTING DETAIL

	SURVEY TRAVERSE POINT	©	SMALL BUSH OR ORNAMENTAL SHRUB	E	ELECTRIC TRANSFORMER
©	POINT OF INTERSECTION - TANGENTS	*	CONIFEROUS TREE 6" AND LARGER	<u>G</u>	GAS MANHOLE
0	POINT OF TANGENCY & CURVATURE		DECIDUOUS TREE 6" AND LARGER	MH	SANITARY SEWER MANHOLE
T.P. +	SURVEY TIE POINT LOCATION		HEDGEROW OR THICKET		TELEPHONE MANHOLE
	CATCH BASIN	u	WOODS LINE	E	ELECTRIC MANHOLE
	EXISTING DRAINAGE PIPE AND FLOW ARROW		SIGN	F.H.	FIRE HYDRANT
	TOP OF DITCH	××	STRAND OR WOVEN WIRE FENCE	B	TELEPHONE BOOTH
	BOTTOM OF DITCH		WOODEN FENCE	○->	UTILITY POLE GUY WIRE ANCHOR
	STREAM, DITCH OR POND BOUNDARY	ø	WOOD POLE	G.V.	GAS VALVE
OHW	ORDINARY HIGH WATER	A-4(4) A-2(4)	SOIL BORING LOG - PROFILE VIEW	W.∨.	WATER VALVE
165.5 _×	SPOT ELEVATION	•	SOIL BORING LOCATION - PLAN VIEW	WELL	MONITORING/OBSERVATION WELL
9 ——	CONTOUR LINE	GnB2 GnB3	SOIL TYPE AND BOUNDARY LINE		LUMINAIRE SUPPORT POLE AND/OR BASE
		0	WOODEN POST	—	POLE MOUNTED LUMINAIRE
				W.M.	WATER METER

ADA LANDING AREA

UTILITIES

	EXISTING			PROPOSI	ED
E-OH	ELECTRIC (OVERHEAD)	———Т	TELECOMMUNICATIONS (UNDERGROUND)	——— E ———	ELECTRIC
——— Е —	ELECTRIC (UNDERGROUND)		WATER	S	SANITARY
———— SAN	SANITARY SEWER	——————————————————————————————————————	SANITARY FORCE MAIN	———— W———	WATER

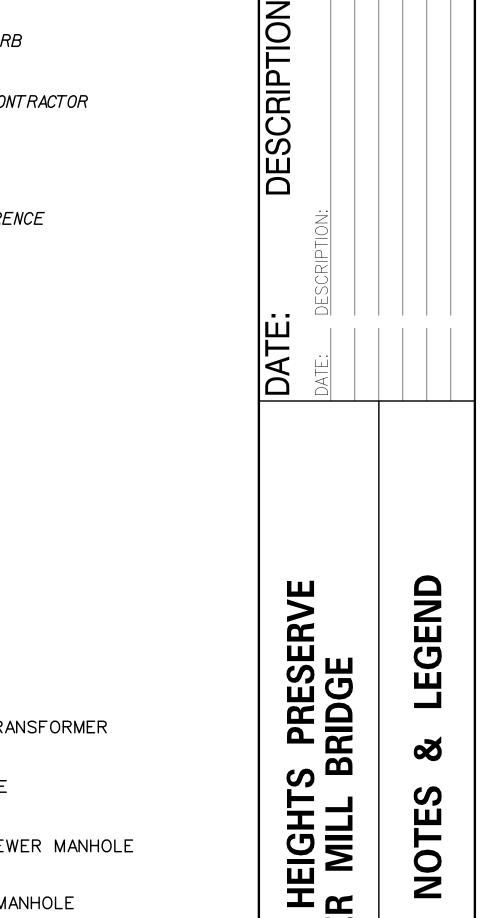

B

DESIGNED BY: RKK

0

Z

5

UBURN

RKK **BUILDING NO.:** N/A DATE:

DRAWN BY:

6/30/2017

NOT TO SCALE

SHEET NO.:

PARKS PROJECT #:

NVF-4CONTRACT #:

2015-NVF-100

CONTROL COORDINATES

DESCRIPTION	STATION	NORTHING	EASTING
FARM LANE B CONSTRUCTION			
PC	<i>107+16.55</i>	<i>658368. 2517</i>	<i>581960.7739</i>
PI	<i>107+67.39</i>	<i>658323.</i> 8619	<i>581985. 5445</i>
CC		<i>658429. 1630</i>	<i>582069. 9289</i>
PT	108+13.11	<i>658309. 3586</i>	<i>582034. 2652</i>
PC	109+80.47	658261.6088	<i>582194.6697</i>
PI	109+94.70	<i>658257. 5502</i>	<i>582208. 3036</i>
CC		<i>658154. 2641</i>	<i>582162.7149</i>
PT	110+08.77	<i>658250. 2122</i>	<i>582220.</i> 4900
P0E	111+00.00	<i>658203. 1514</i>	<i>582298. 6449</i>

CONTROL COORDINATES

DESCRIPTION	STATION	NORTHING	EASTING
	$P\Delta PFR$	MILL BRIDGE	F
		ISTRUCTION	_
POB	_	658242, 2391	500077 7711
PC		658252. 1240	
PI	201+35.61	<i>658268. 2246</i>	
CC		<i>658217. 9364</i>	
PT		<i>658267. 9320</i>	
P0E	<i>203+25.00</i>	<i>658265. 6784</i>	<i>582450. 0244</i>

CONTROL COORDINATES

DESCRIPTION	STATION	NORTHING	EASTING		
	MUSEUM DRIVE				
	₽ CONS	STRUCTION			
POB	300+00.00	<i>658207. 6110</i>	<i>582025</i> . <i>5676</i>		
PC	301+34.19	<i>658336. 2221</i>	<i>582063. 8530</i>		
PI	<i>301+40.39</i>	<i>658342. 1685</i>	<i>582065. 6231</i>		
CC		<i>658341.9284</i>	<i>582044. 6843</i>		
PT	301+46.22	<i>658348. 0727</i>	<i>582063. 7171</i>		
PC	<i>302+31.93</i>	<i>658429. 6345</i>	<i>582037. 3866</i>		
PI	<i>302+53.49</i>	<i>658450. 1590</i>	<i>582030. 7606</i>		
CC		<i>658441.9232</i>	<i>582075. 4521</i>		
PT	<i>302+71.49</i>	<i>658466. 9734</i>	<i>582044. 2675</i>		
PC	303+41.49	<i>658521.5468</i>	<i>582088. 1056</i>		
PI	<i>303+54.83</i>	<i>658531.9485</i>	<i>582096. 4611</i>		
CC		<i>658546. 5971</i>	<i>582056. 9209</i>		
PT	<i>303+67.24</i>	<i>658545. 2833</i>	<i>582096</i> . <i>8993</i>		
PI	<i>304+57.96</i>	<i>658635. 9519</i>	<i>582099.8787</i>		
POE	<i>305+05.00</i>	<i>658676. 5014</i>	<i>582123. 7196</i>		

CONTROL COORDINATES

DESCRIPTION	STATION	NORTHING	EASTING
	BEN	GE ROAD	
	B CON	ISTRUCTION	
POB	400+00.00	<i>657753</i> . <i>0773</i>	<i>582045. 8603</i>
PC	<i>404+38.75</i>	<i>658187. 1721</i>	<i>582109. 5839</i>
PI	<i>405+30.71</i>	<i>658278</i> . 1610	<i>582122. 9408</i>
CC		<i>658078. 9744</i>	582846.6426
PT	406+21.75	<i>658363. 1700</i>	<i>582158. 0244</i>
PC	406+68.54	<i>658406. 4255</i>	<i>582175.8761</i>
PI	<i>407+29.68</i>	<i>658462. 9381</i>	<i>582199. 1991</i>
CC		<i>658238.</i> 1122	<i>582583. 7064</i>
PT	407+90.04	<i>658510. 9795</i>	<i>582237.</i> 0100
P0E	409+00.00	<i>658597. 3850</i>	<i>582305. 0154</i>

I. TOPOGRAPHY SUPPLIED BY DNREC. TOPOGRAPHY WAS FLOWN BY AXIS GEOSPATIAL, LLC ON 03-13-2004.

FARM LANE CURVE DATA

	2
\triangle = 44°15′36.0138″ Left Dc = 45°50′11.8450″ R = 125.0000 T = 50.8335 L = 96.5603 E = 9.9409	\triangle = $14^{\circ}28'36.4534''$ Right Dc = $51^{\circ}09'25.0056''$ R = 112.0000 T = 14.2252 L = 28.2988 E = 0.8998

PAPER MILL CURVE DATA

<i>i</i> /\	LIV WILL CONVE DA
	3
	\triangle = 47°37′20.5117" Right Dc = 114°35′29.6125" R = 50.0000 T = 22.0643 L = 41.5584 E = 4.6519

MUSEUM DRIVE CURVE DATA

MOSLOW DITTLE CONVE DATA			
4	5	6	
\triangle = 34°28′08.3753" Left Dc = 286°28′44.0312" R = 20.0000 T = 6.2042 L = 12.0319 E = 0.9402	\triangle = 56°39′57.9/59″ Right Dc = 143°14′22.0/56″ R = 40.0000 T = 21.5675 L = 39.5604 E = 5.4440	\triangle = 36°53′32.5753" Left Dc = 143°14′22.0156" R = 40.0000 T = 13.3421 L = 25.7557 E = 2.1665	

BENGE ROAD CURVE DATA

7	8
\(\sigma = 14\cdot 04'29.8624'' \) Right \(\Oc = 7\cdot 41'28.1152''\) \(\R = 744.9579\) \(\I = 91.9640\) \(\L = 183.0022\) \(\I = 5.6550\)	\triangle = 15°46′42.0819" Right Dc = 12°59′11.1682" R = 441.1971 T = 61.1362 L = 121.4987 E = 4.2157

12141

DESCRIPTION:

DATE:


AUBURN HEIGHTS PRESERVE PAPER MILL BRIDGE


VERTICAL PLAN


HORIZONTAL & CONTROL

SURVEY CONTROL POINTS


POINT NO.	NORTHING	EASTING	ELEVATION
1006	658607 . 9360	<i>581356.9390</i>	235.0
1007	<i>659264.6300</i>	580122.9570	<i>354.</i> 7
1009	660312.0600	581459,1300	236.6
21 4 6	<i>657181.3710</i>	583200.6330	<i>187,1</i>
12141	<i>659233,II50</i>	<i>583933.</i> 9330	171.9

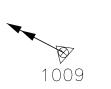


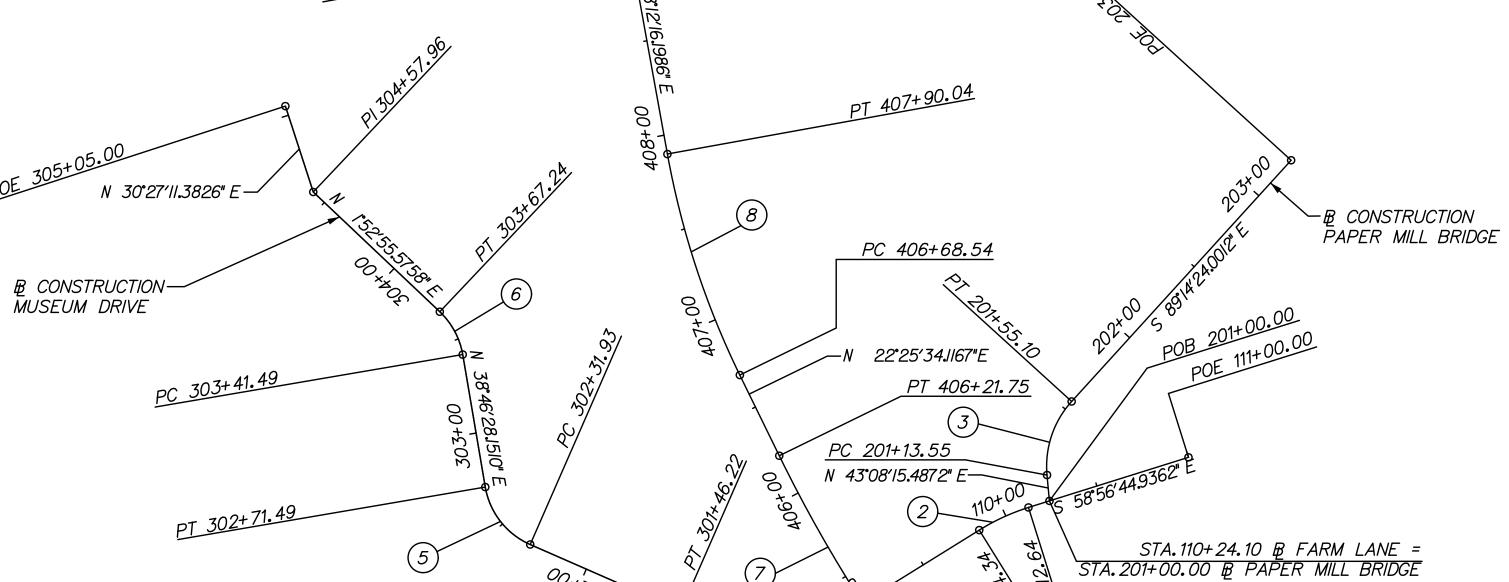

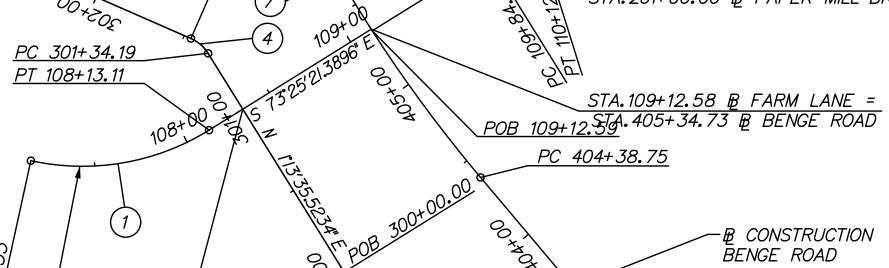

₽ CONSTRUCTION — FARM LANE

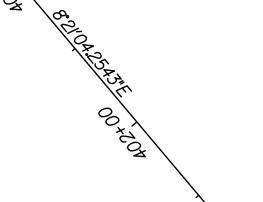

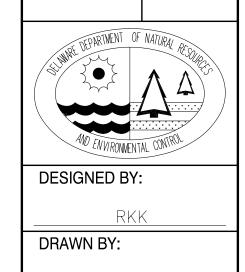

BUILDING NO.:

DATE:


6/30/2017 SCALE: 1" = 50'


SHEET NO.:


PARKS PROJECT #: NVF-4


CONTRACT #: 2015-NVF-100

1006

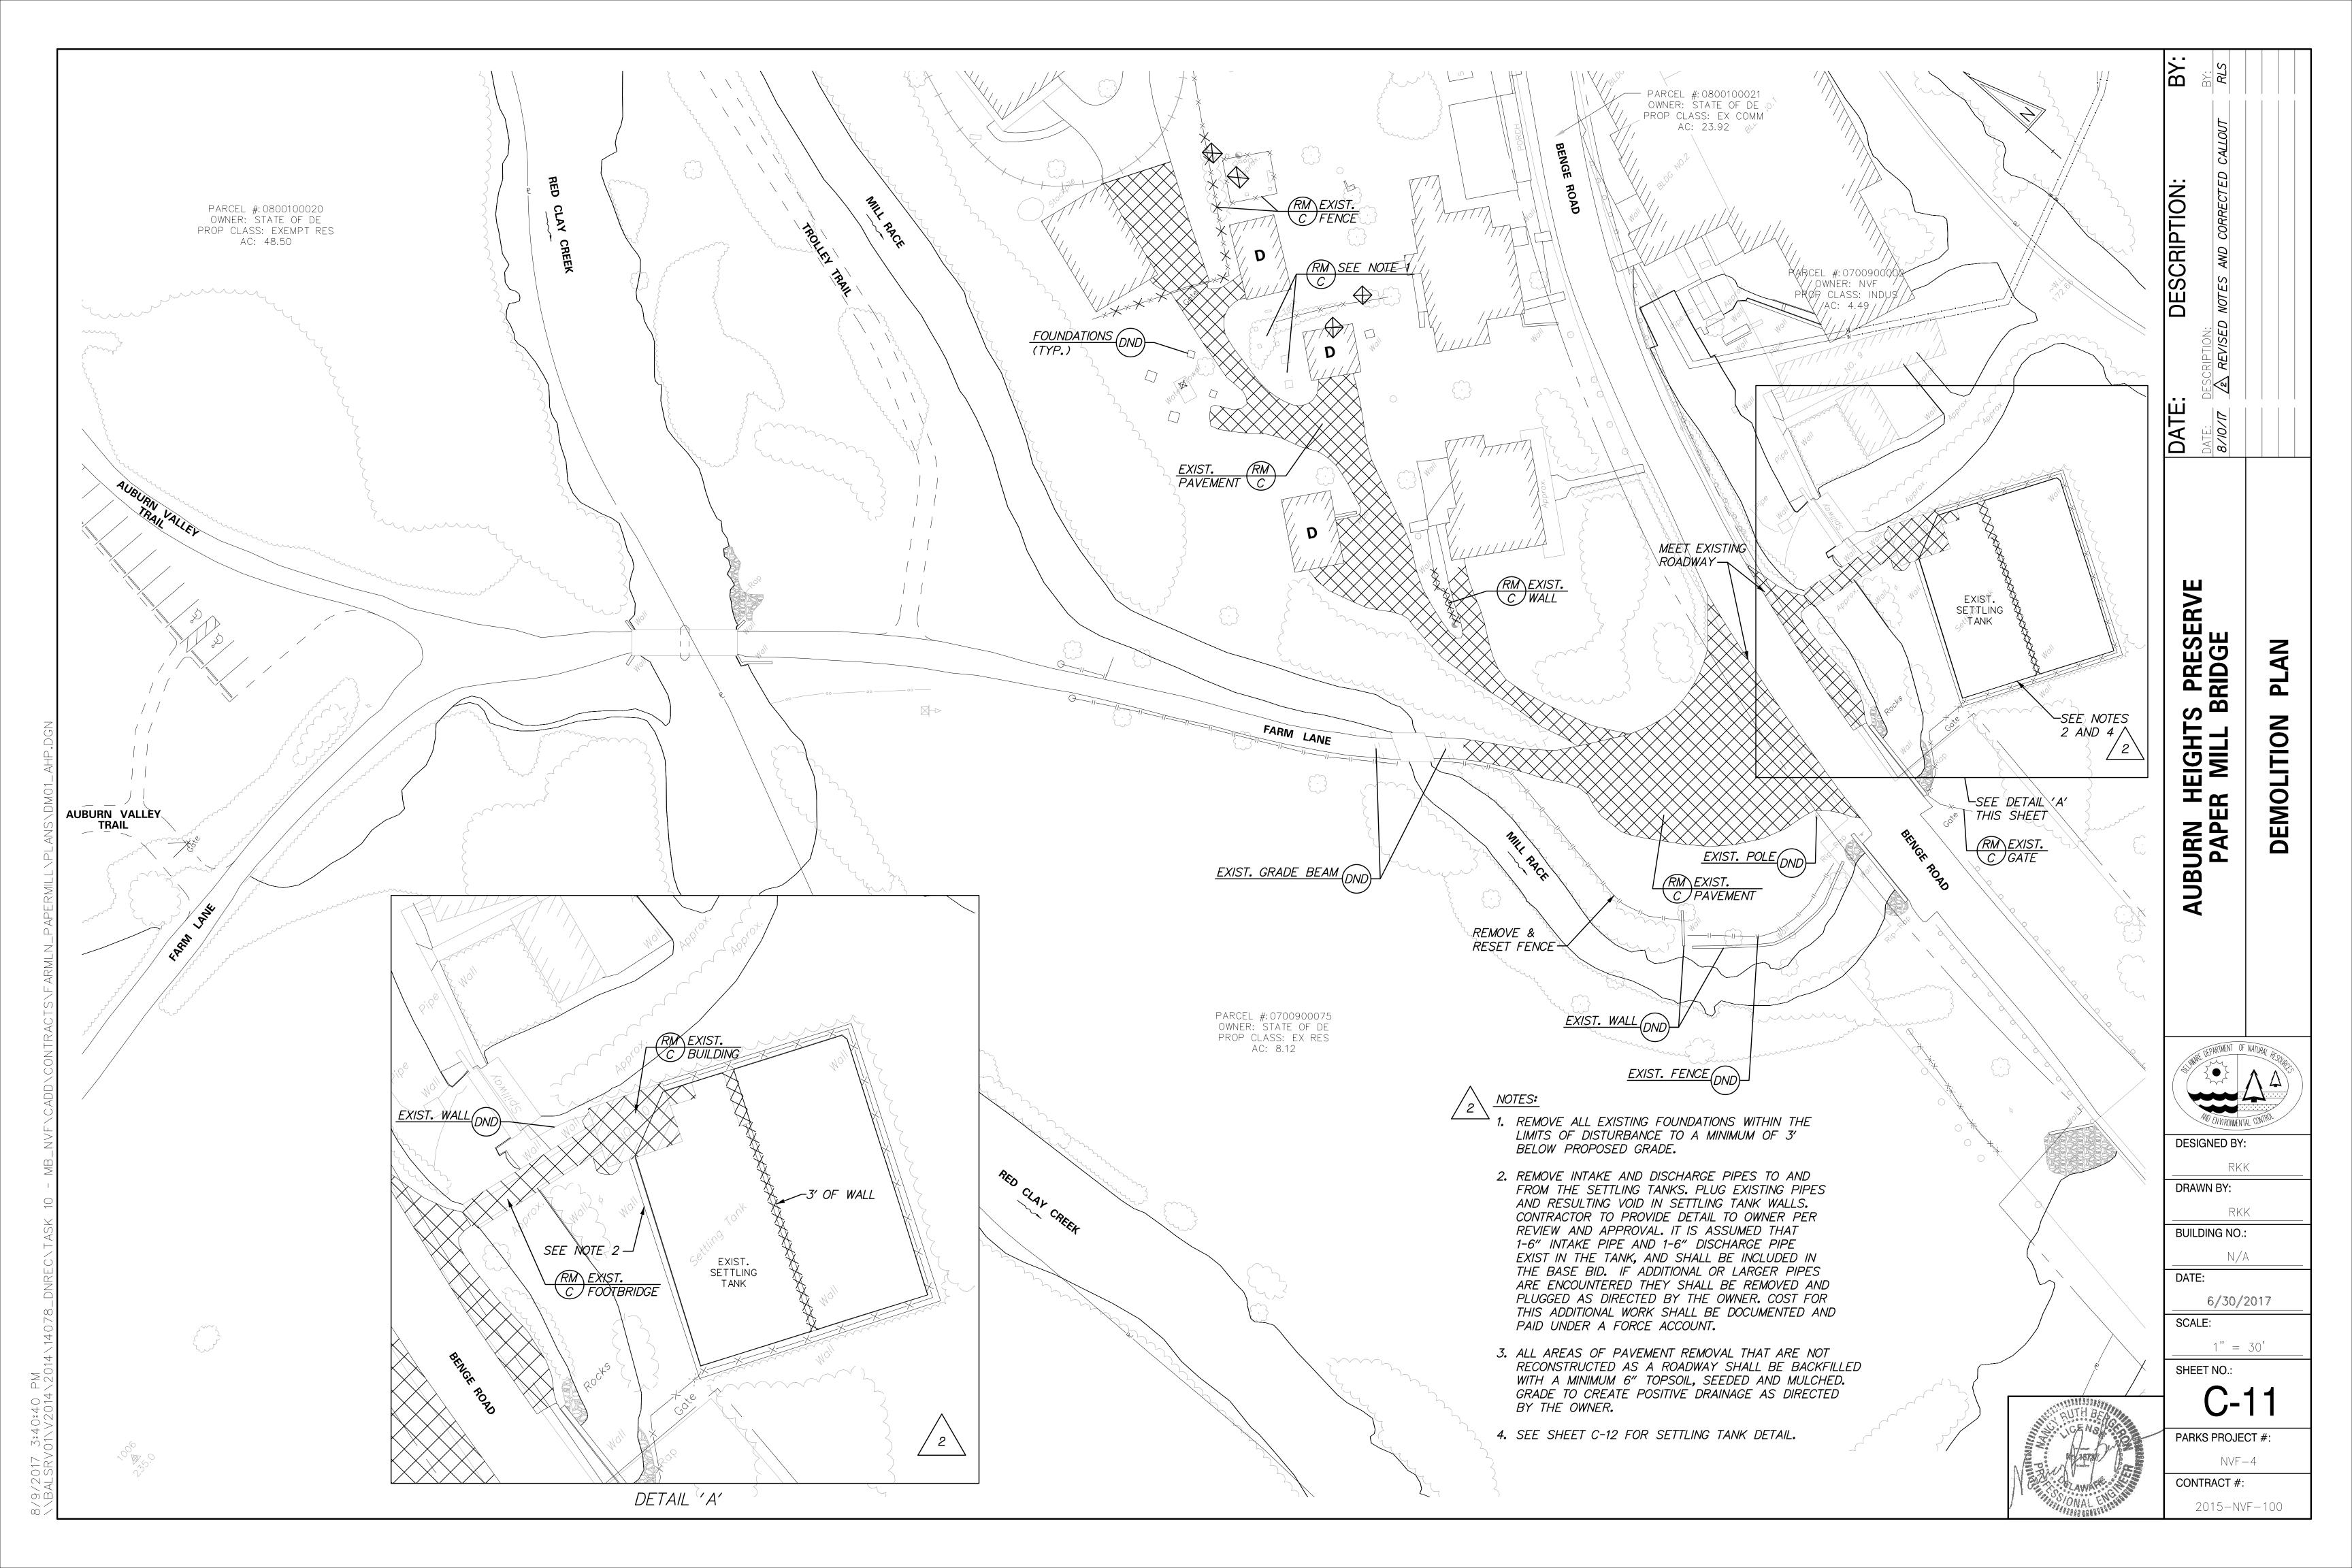


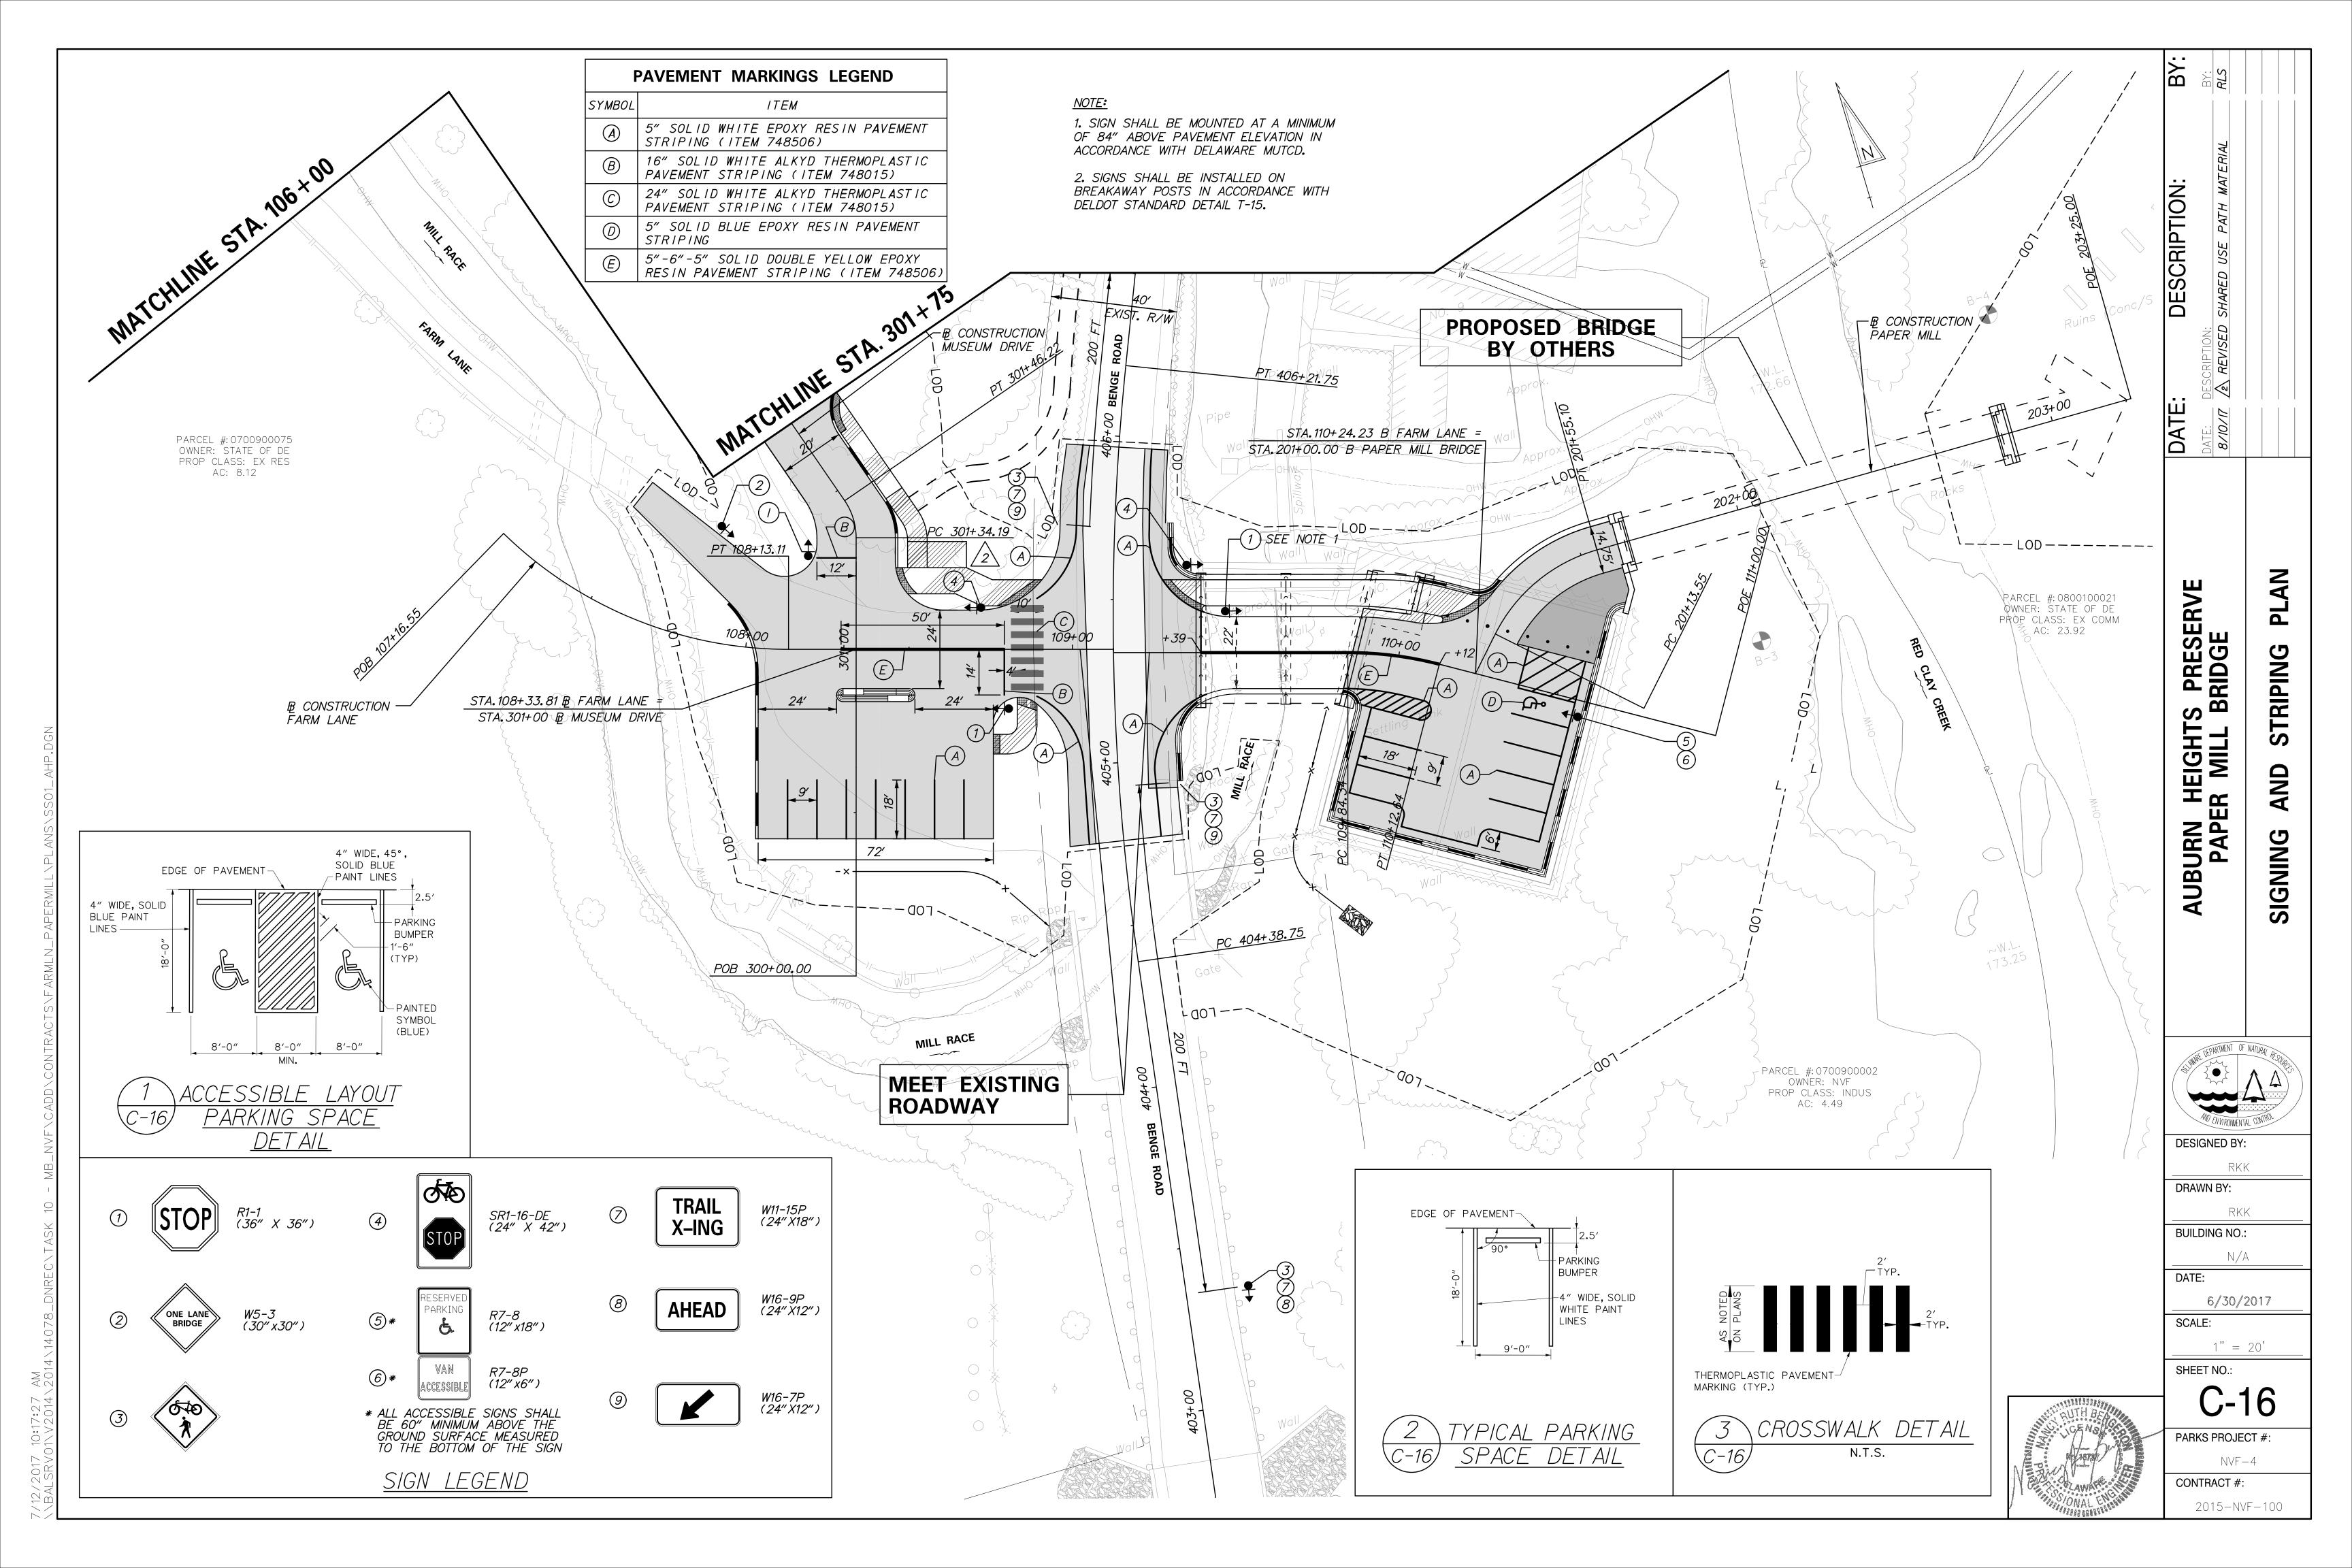

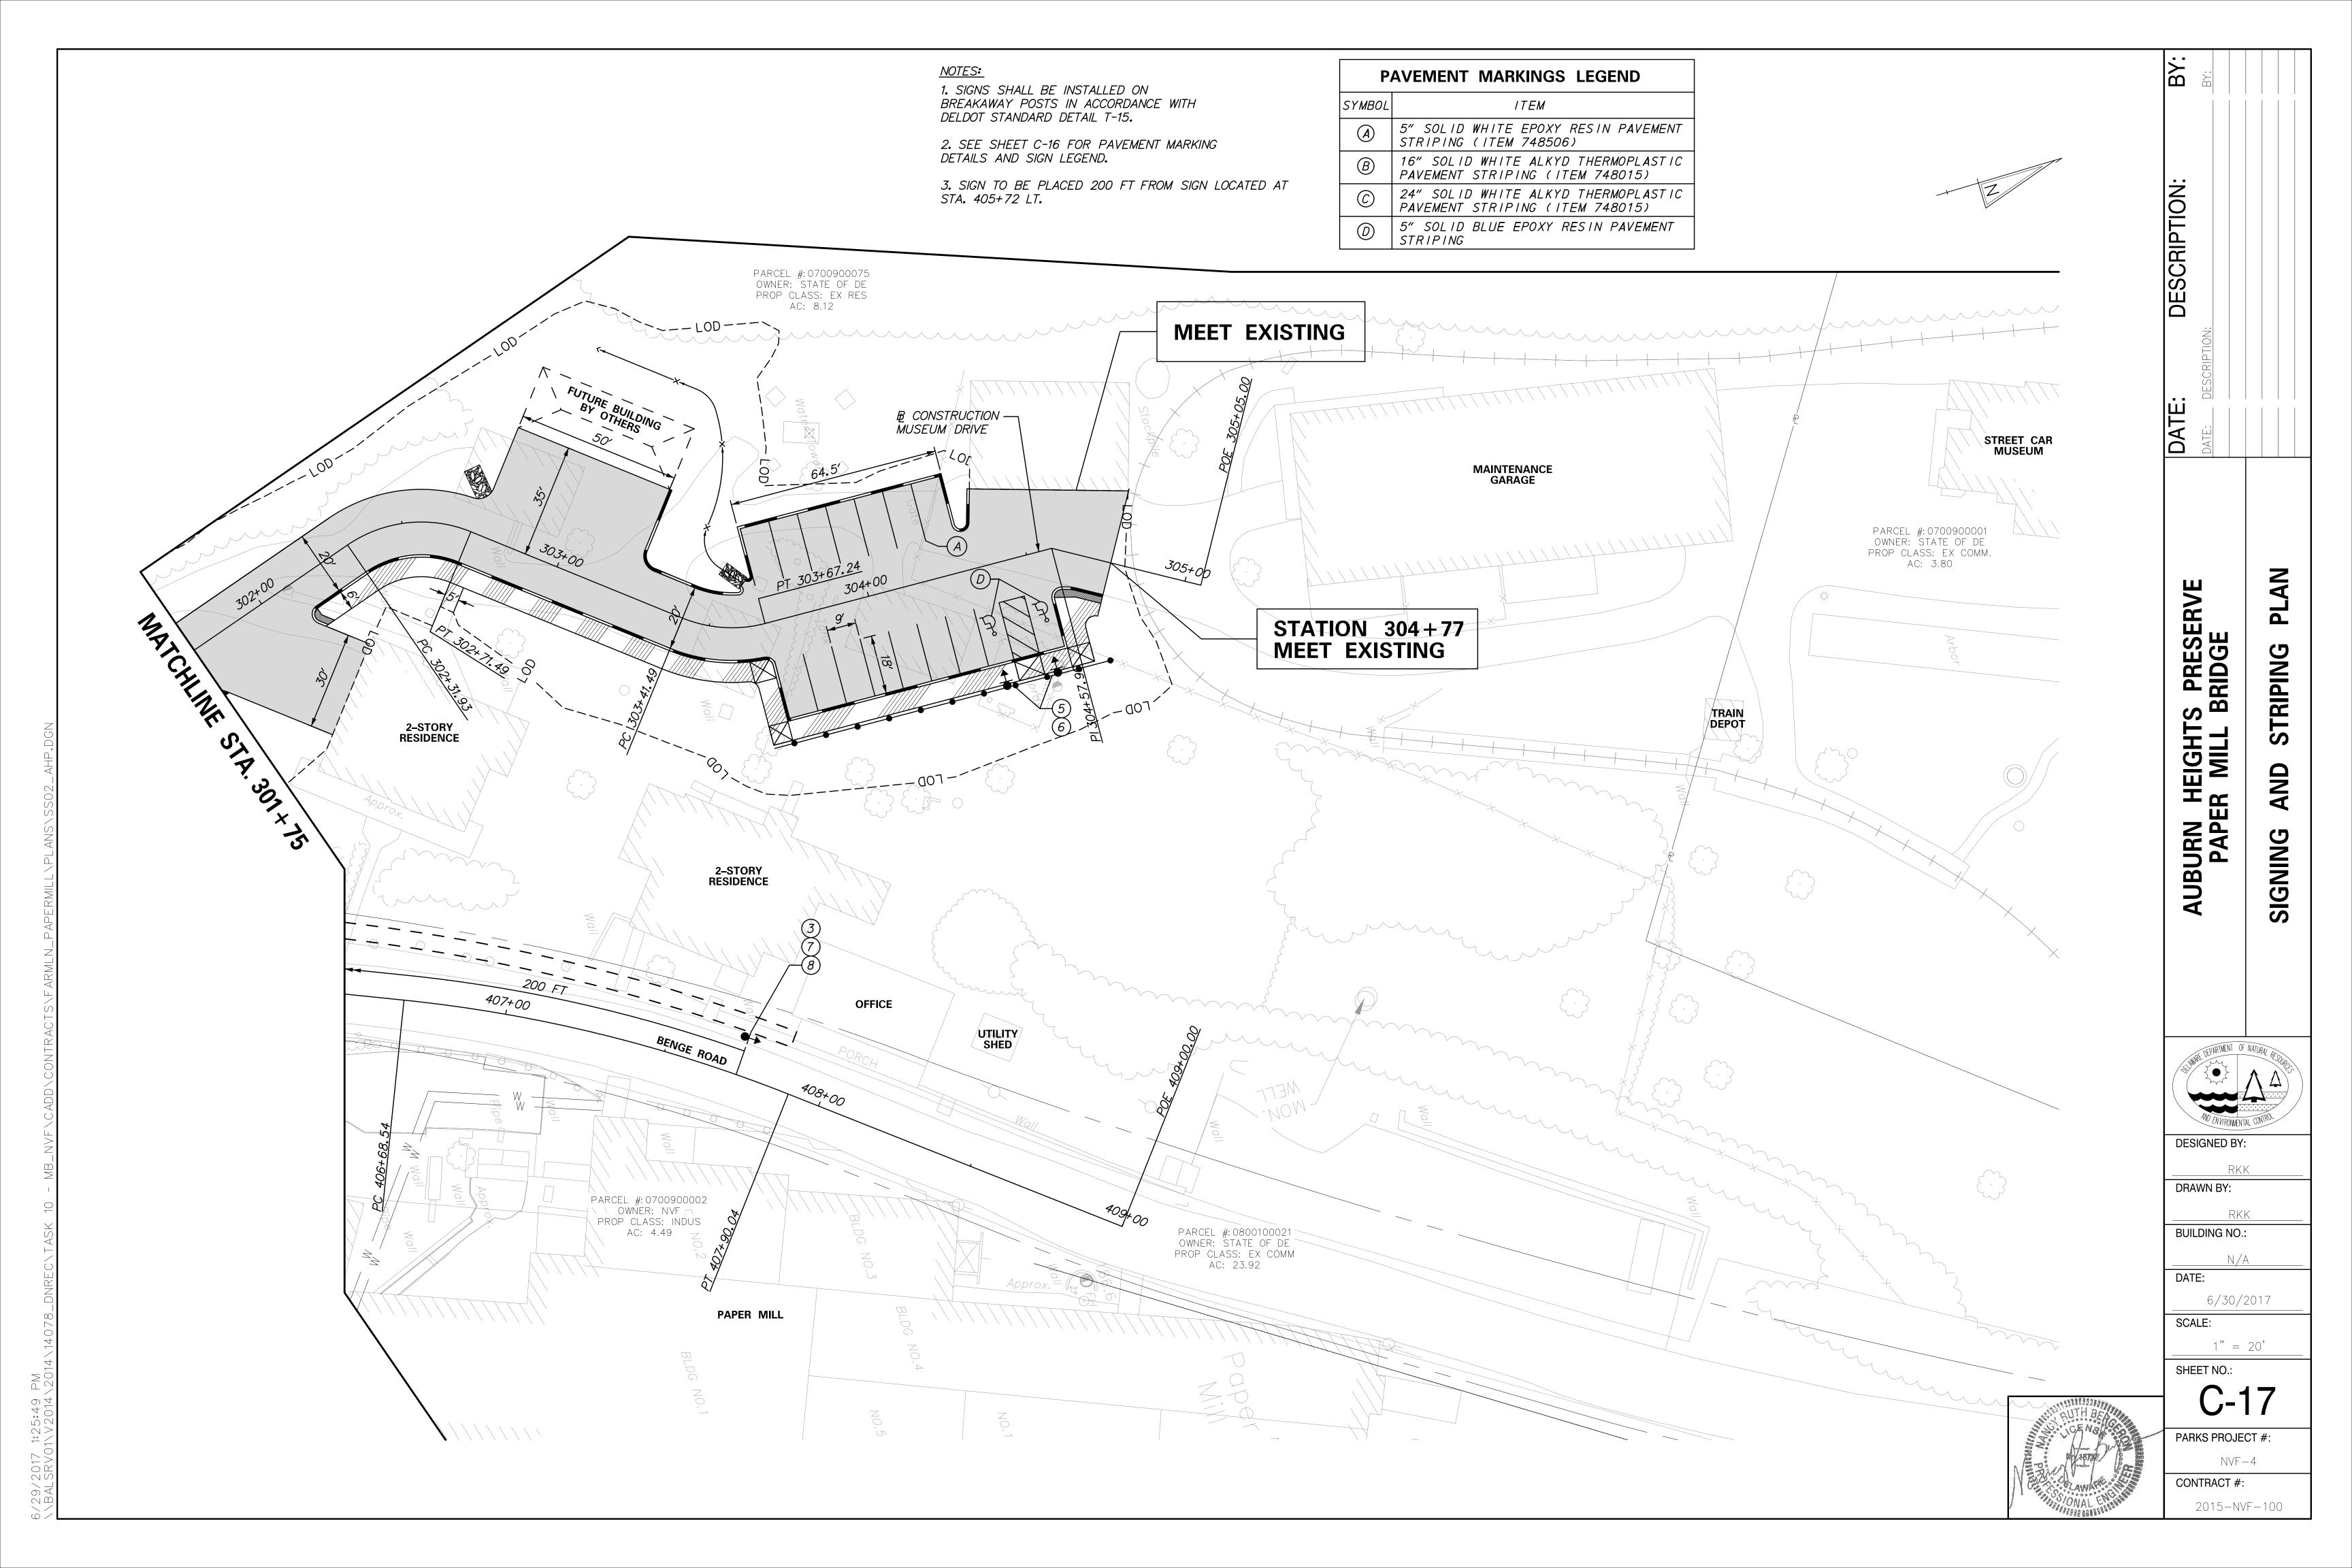

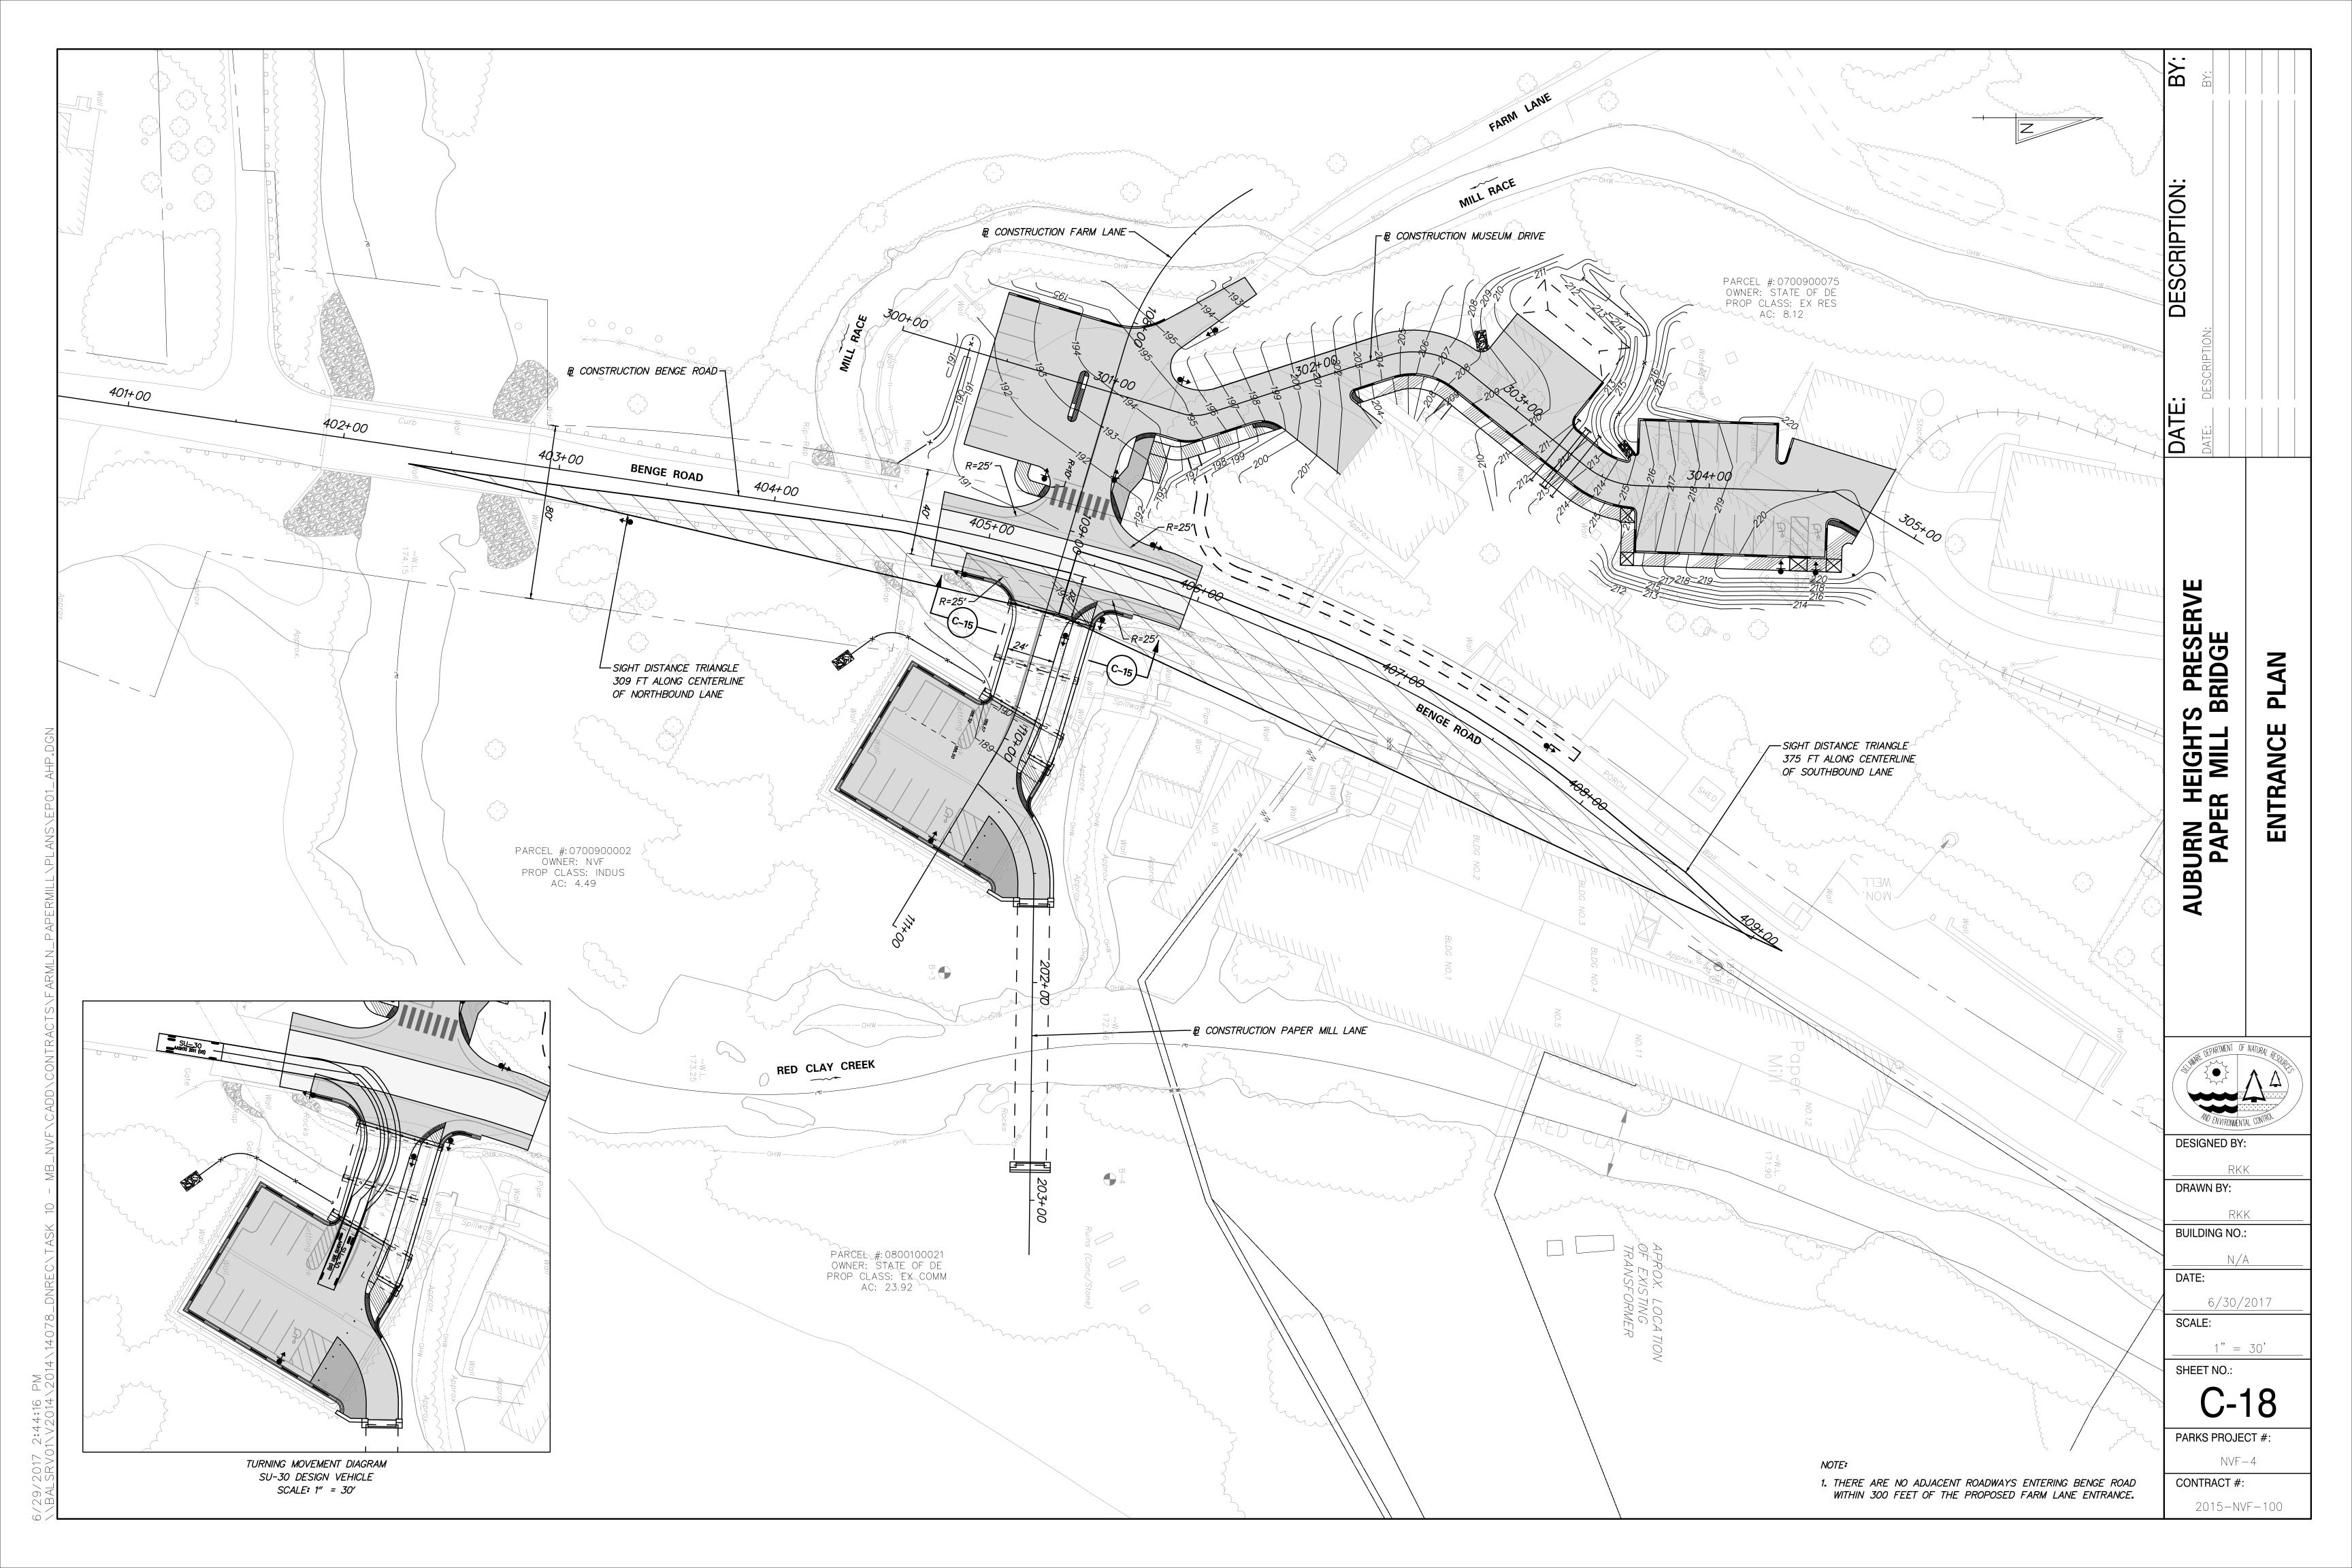



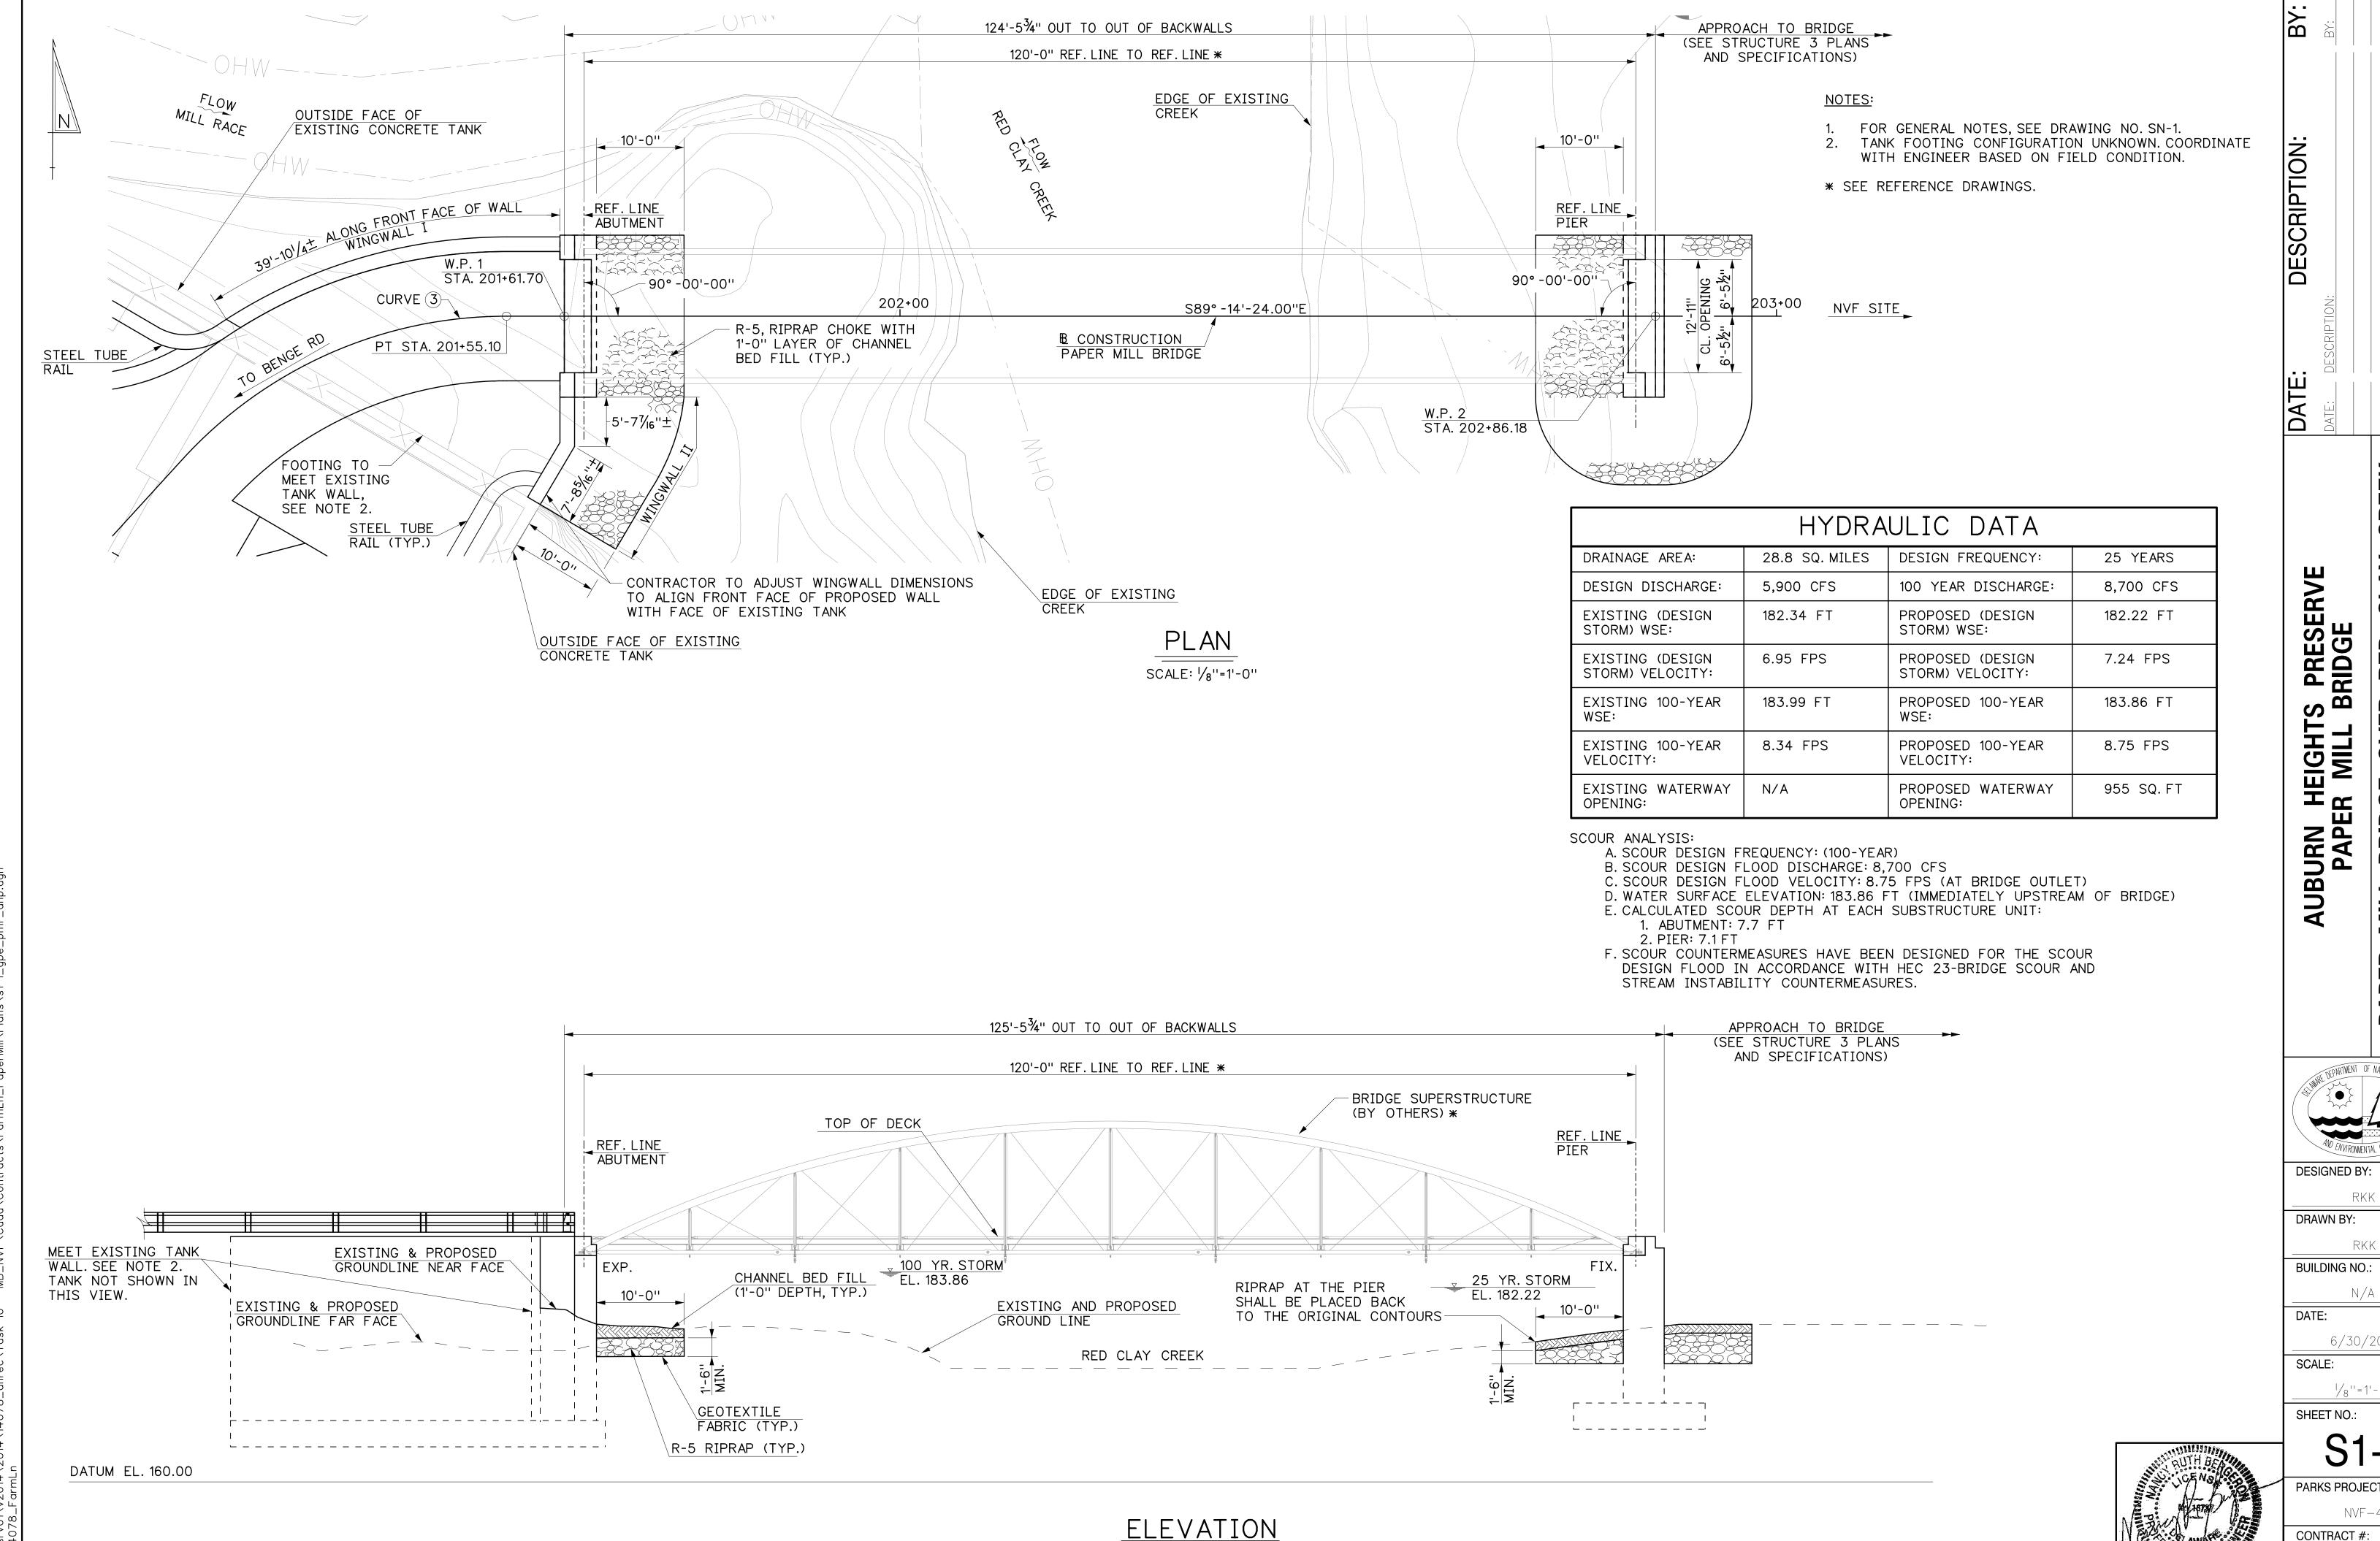

SCALE: 1/8"=1'-0"

CREEK DGE OVER RED CLAY PLAN AND ELEVATION MILL BRIC GENERAL F

PAPER

6/30/2017

1/8 | = 1 - 0 |

PARKS PROJECT #:

NVF-4CONTRACT #:

2015-NVF-100

